
PLANS FOR CONSTRUCTION


BIOLA COMMUNITY SIDEWALK IMPROVEMENTS

G STREET - SHAW AVE STATE PROJECT NO. ATPL-5942(303)

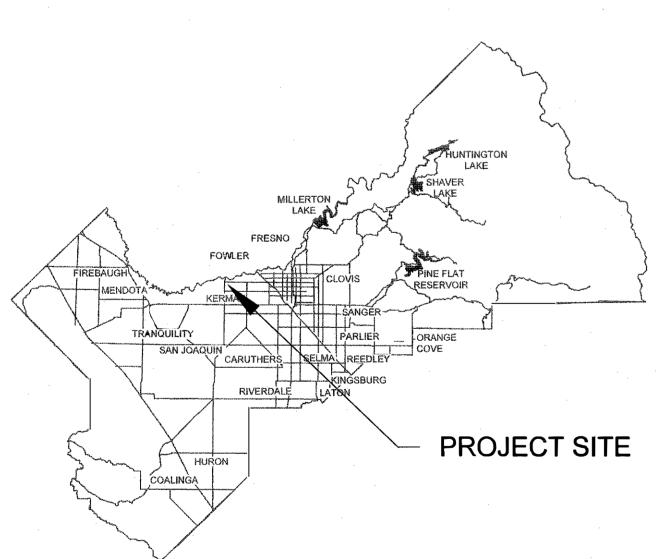



DIVISION	DESIGN	CONST	RMO	RESC
SIGNATURE	MA	MS	Ay.	
DATE	2/16/24	2.20.24	2-20-24	

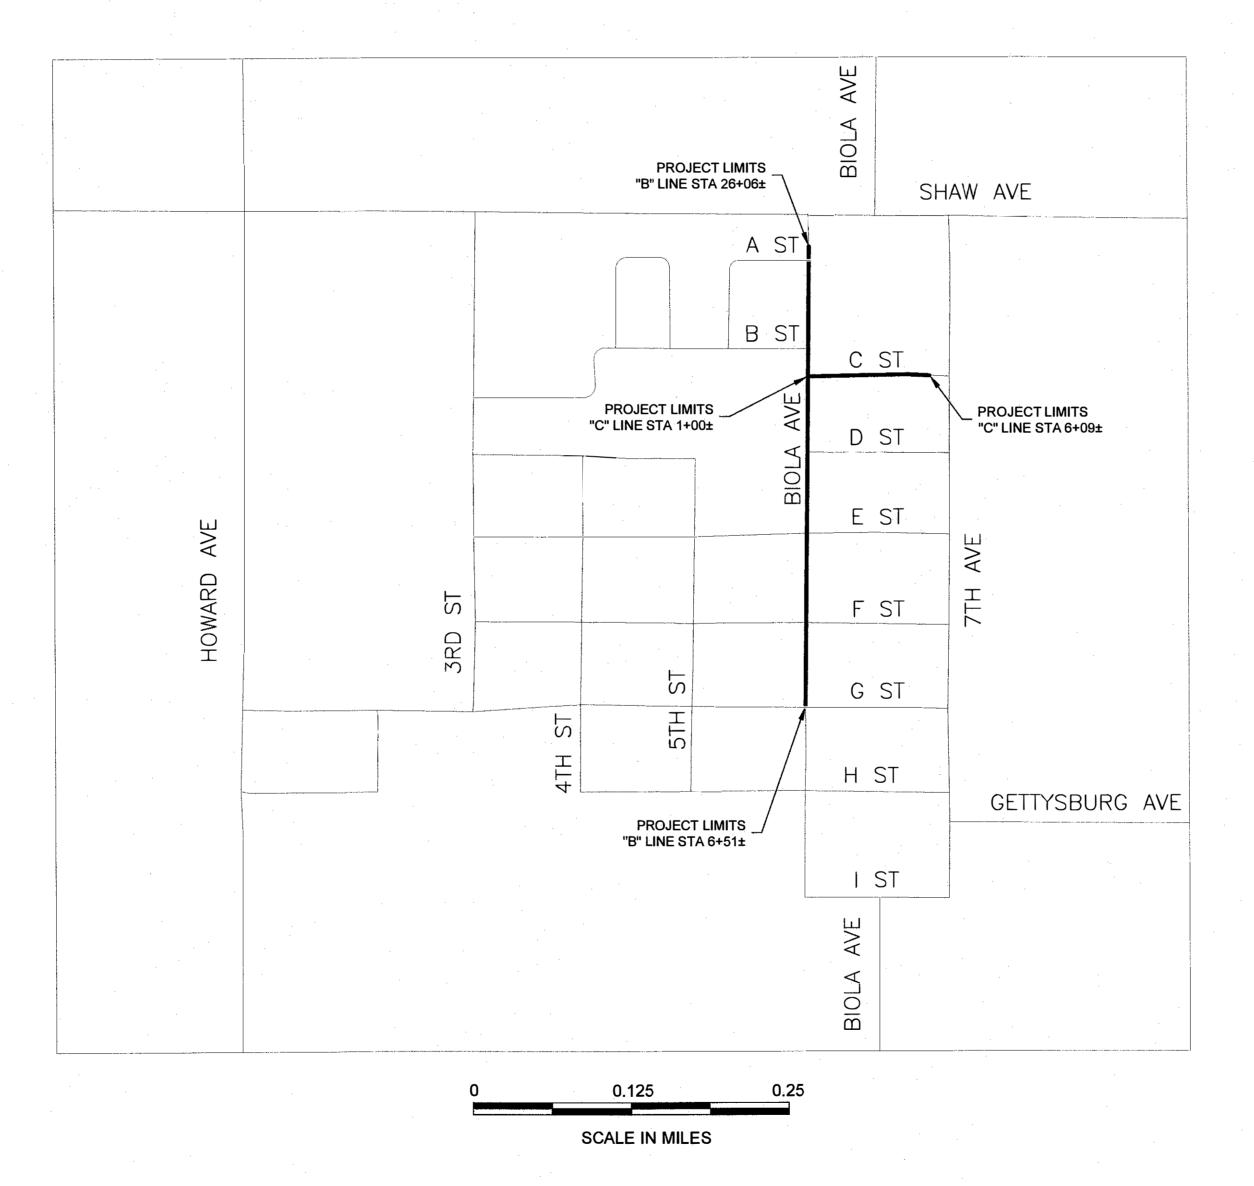



DEPARTMENT OF PUBLIC WORKS AND PLANNING

INDEX OF SHEETS

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- 30-31 STREET LIGHTING PLAN
- 32 ELECTRICAL DETAILS


Steve Brandau 2nd District
Brian Pacheco 1st District
Sal Quintero 3rd District
Ernest Buddy Mendes Vice Chairman 4th District
Nathan Magsig Chairman 5th District


Paul Nerland County Administrative Office


Steven E. White, Director
Department of Public Works and Planning


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	3	ENGINEERING	SS A, GENERAI	CLA	
		K AND PAVING	12, EARTHWOR	C-	
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32	1	23/24	N/A	W1250	11320


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ADDRESS		,	.,
CITY	STATE	ZIP	
PHONE			
DATE AWARDED			
DATE STARTED			
DATE COMPLETED			
	RESIDENT ENGINEER		
NAME	SIGNATURE		
NAME	SIGNATURE		

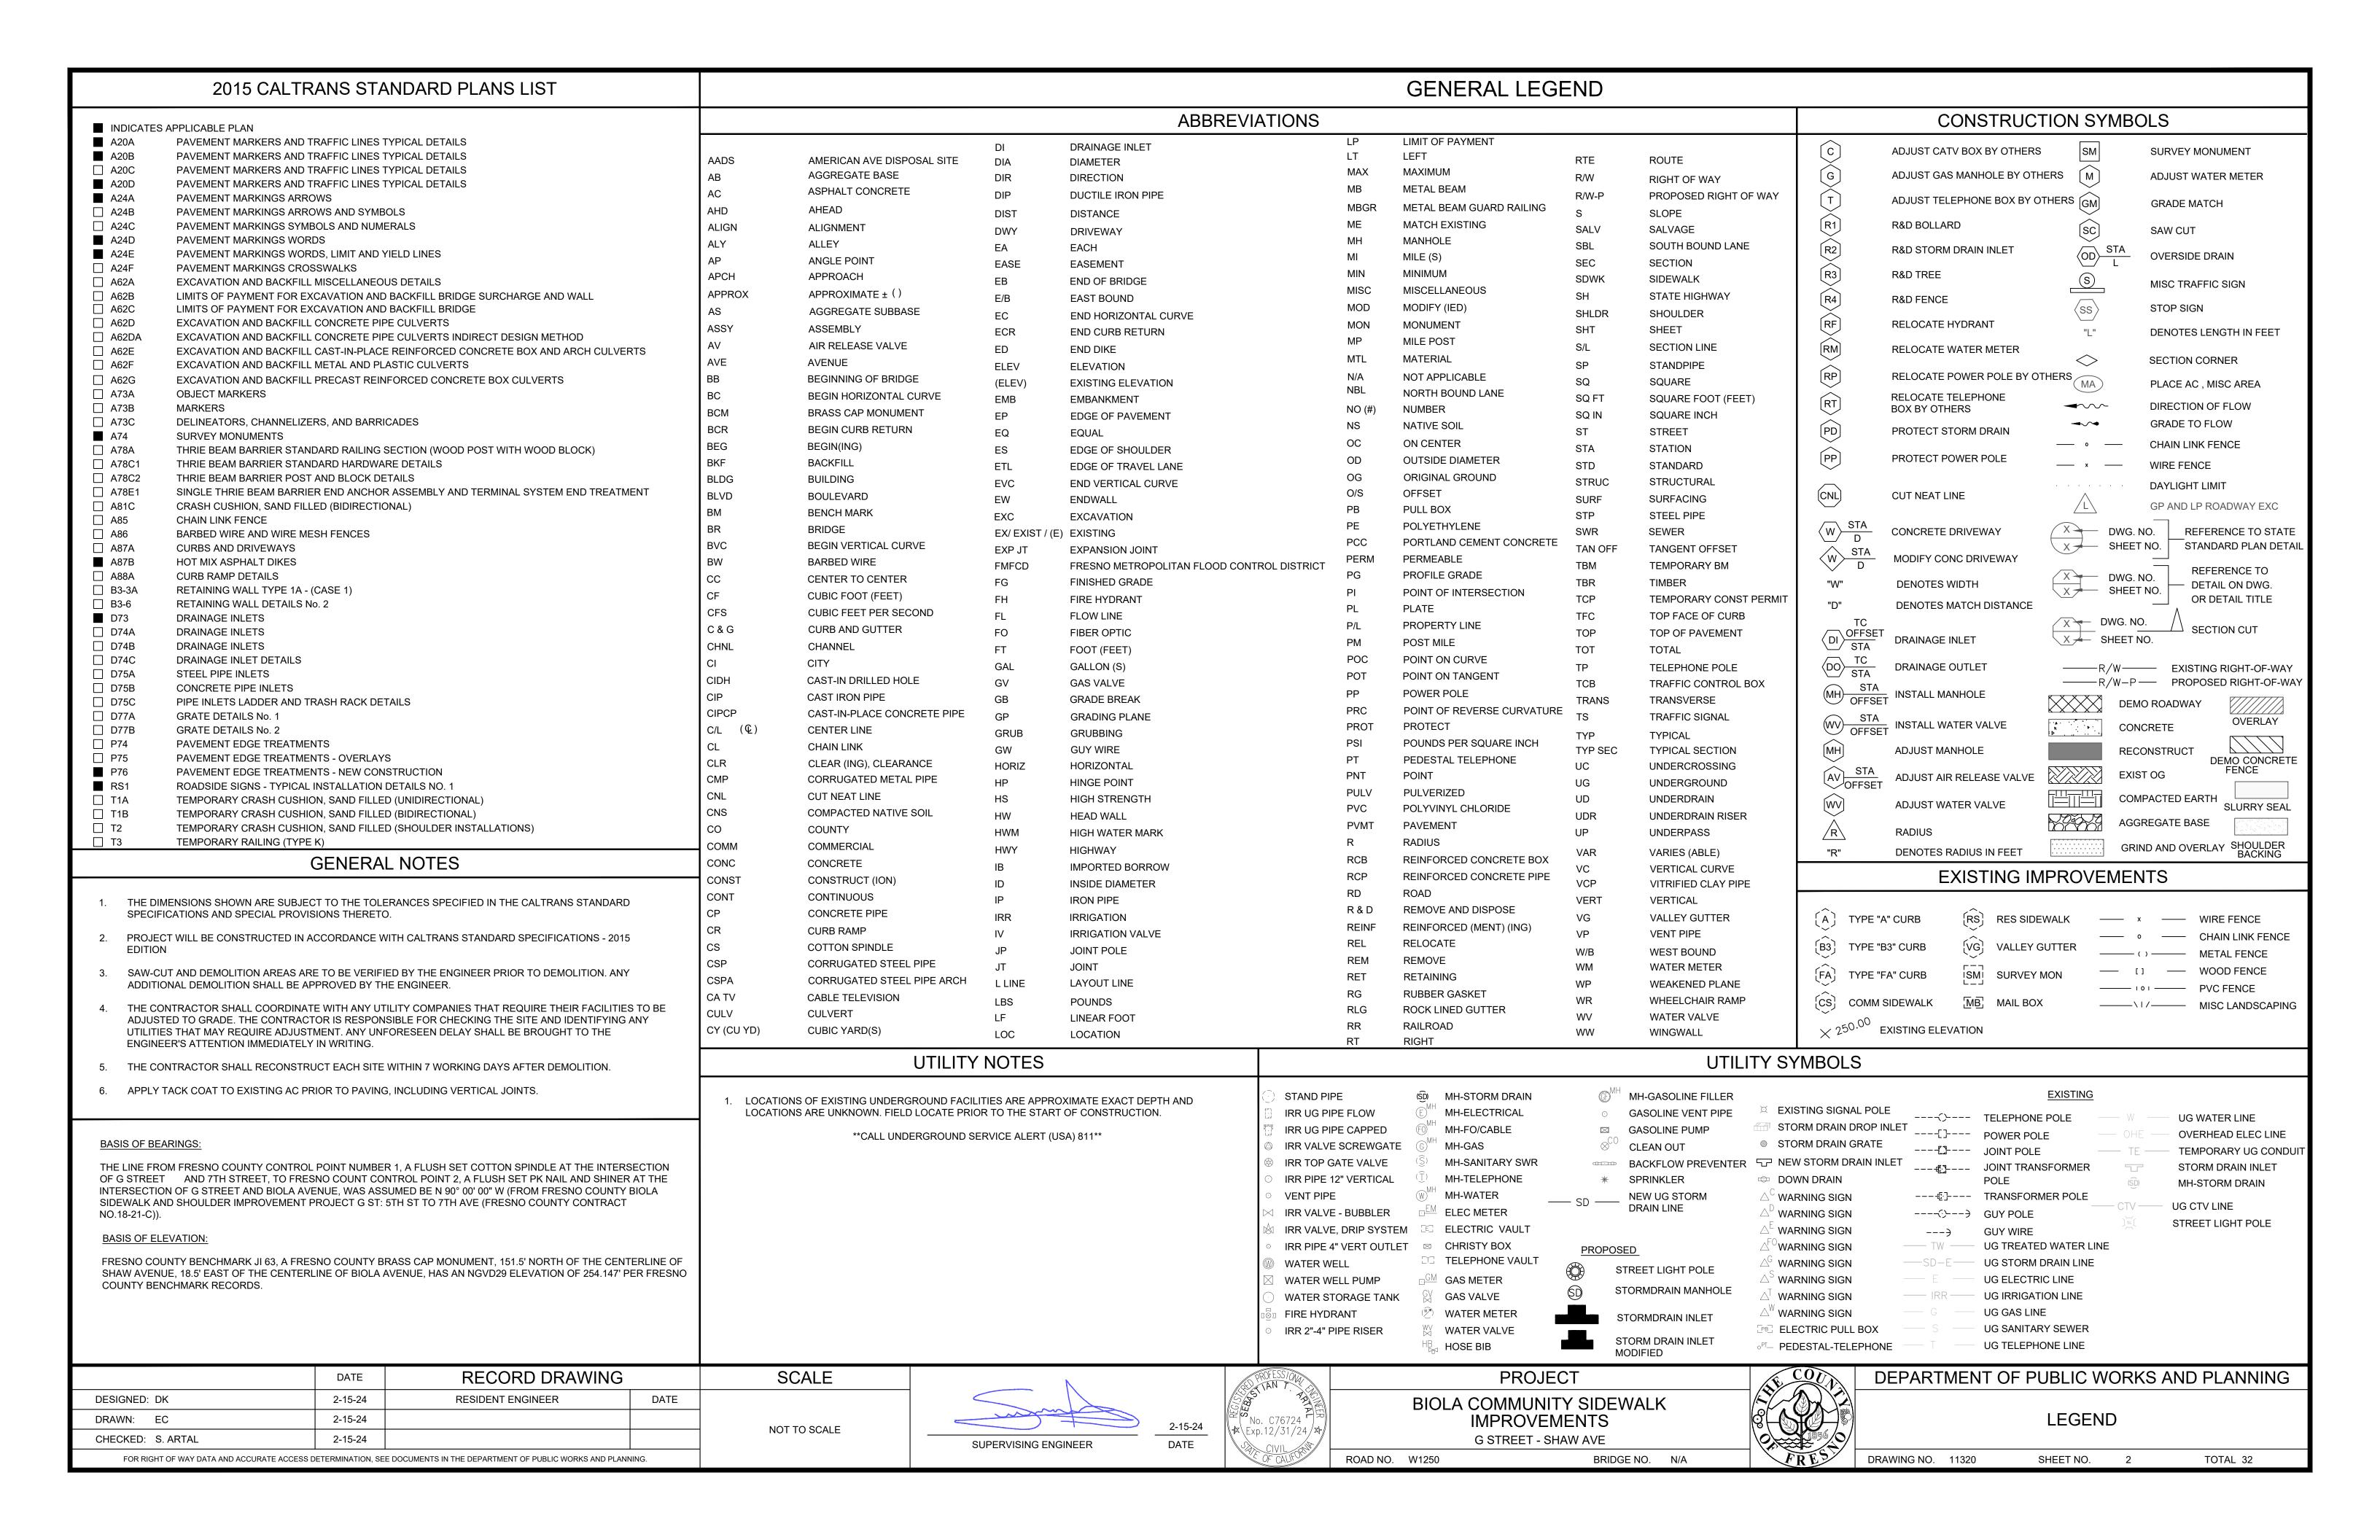


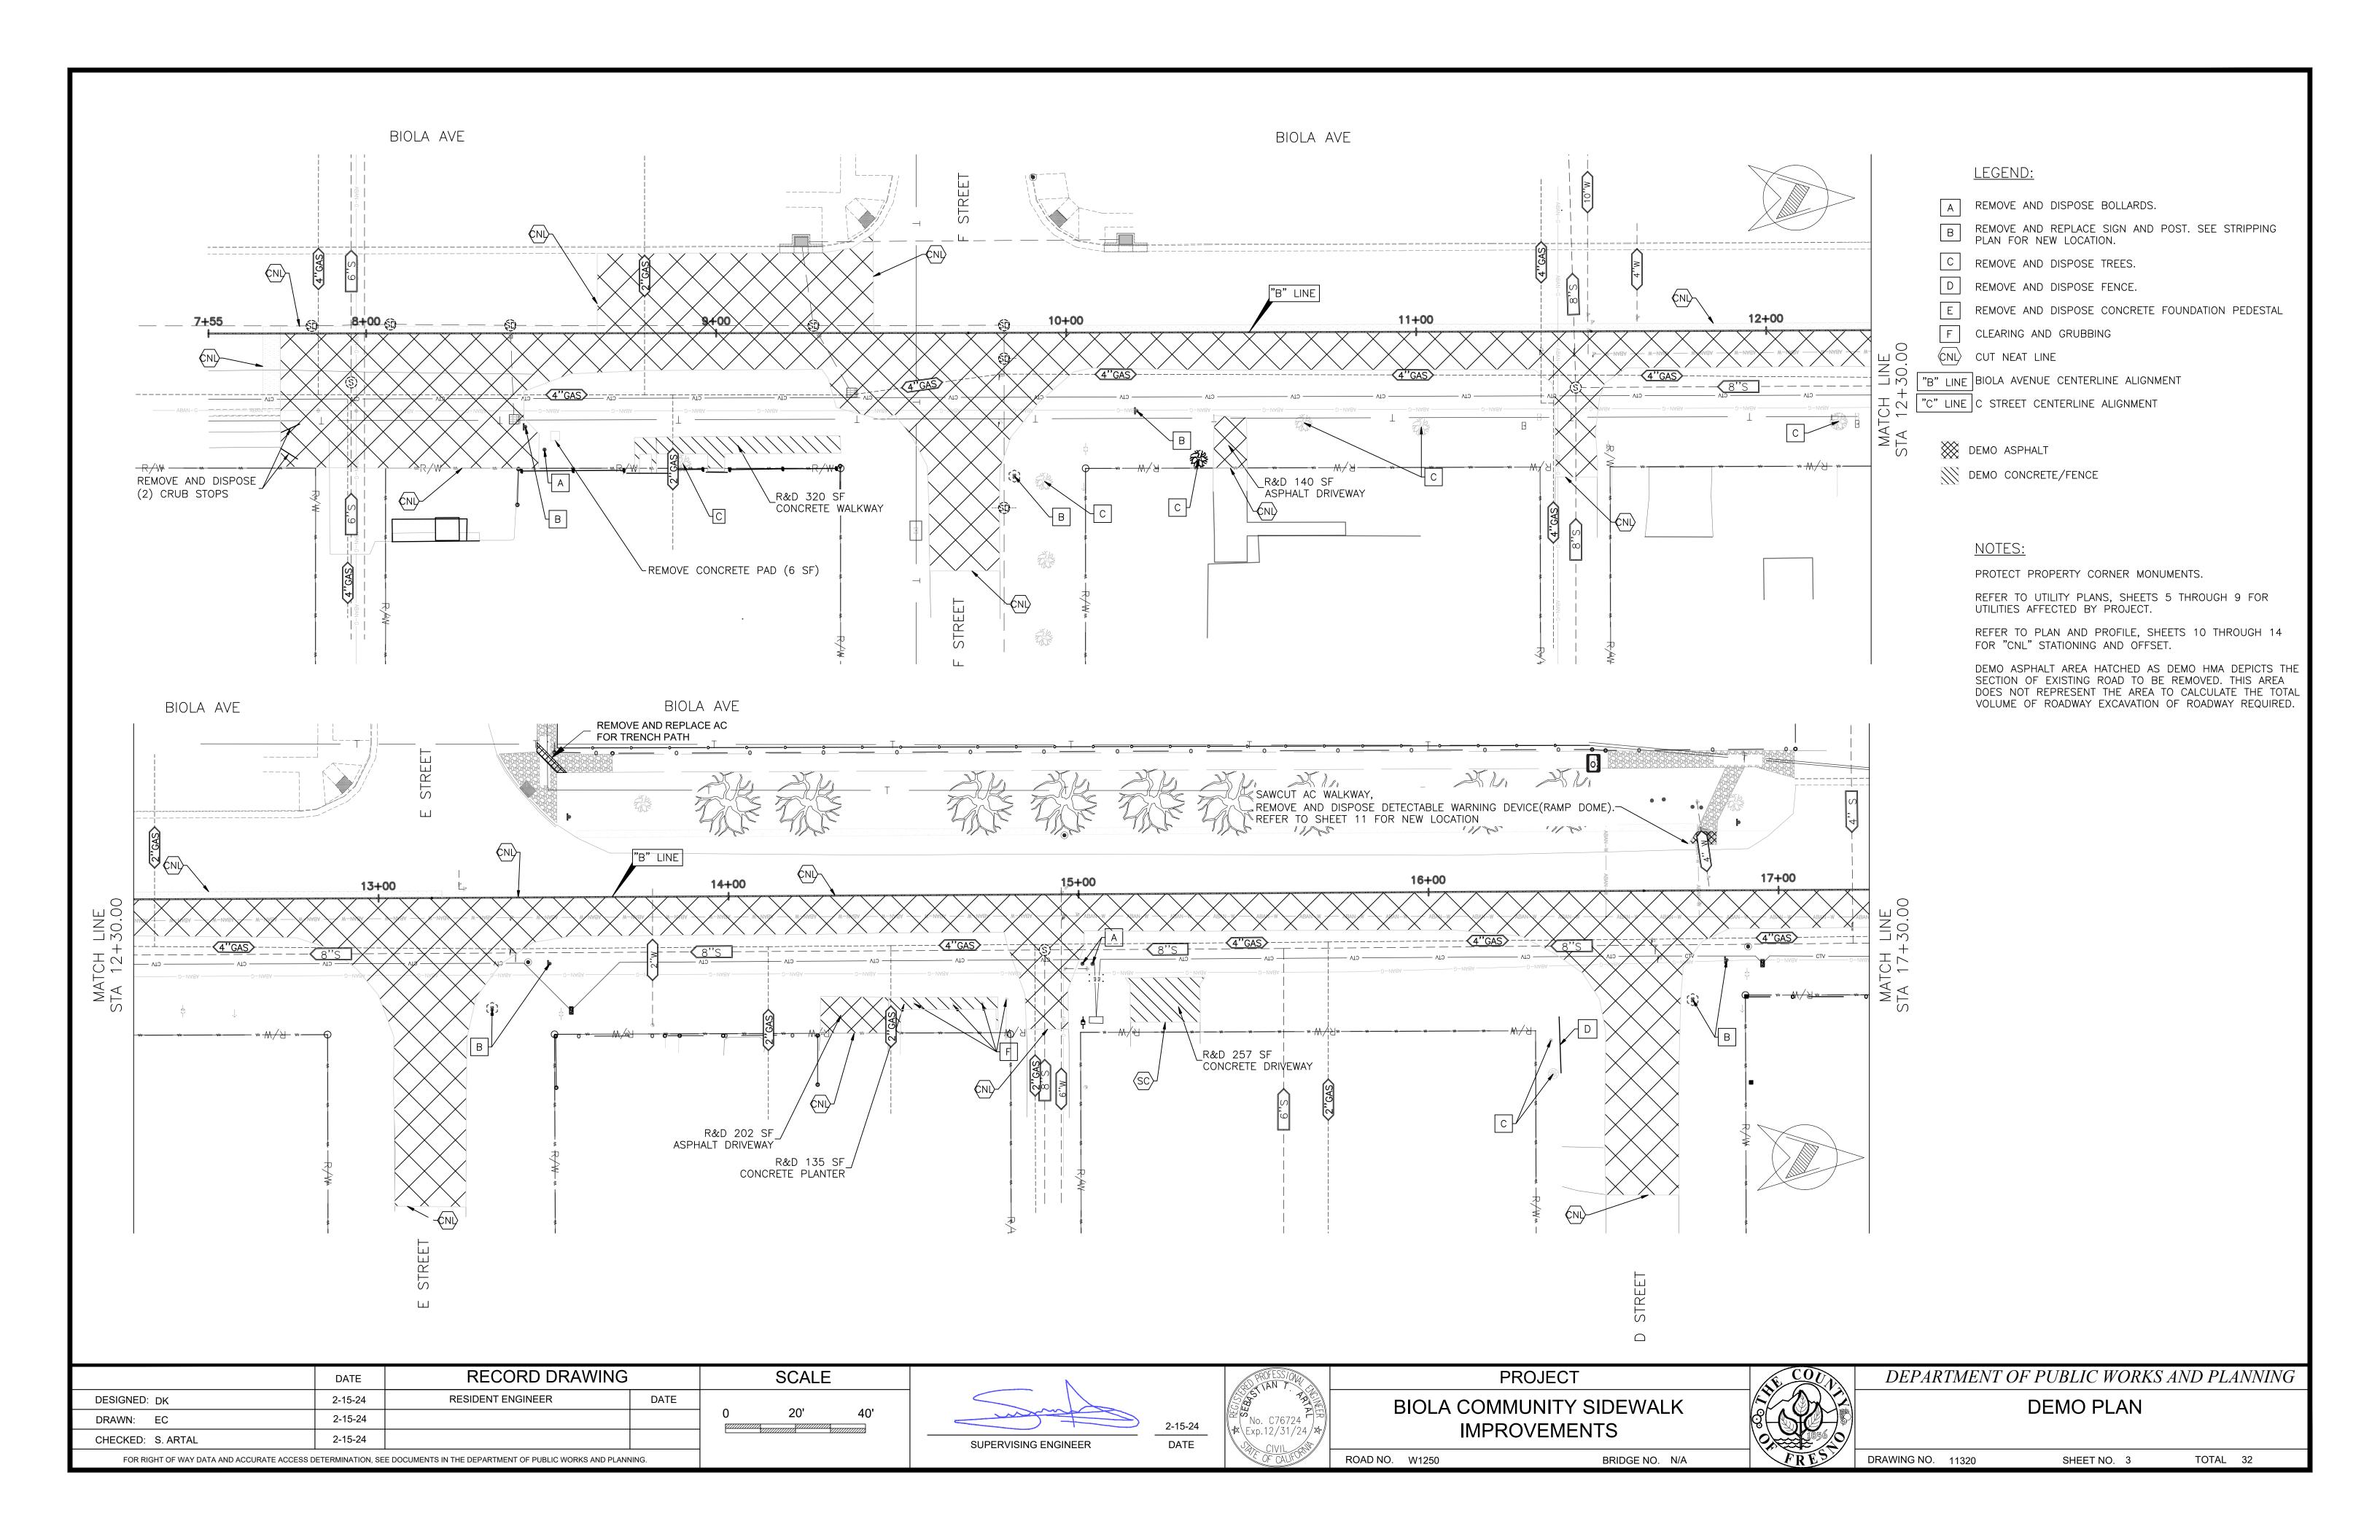


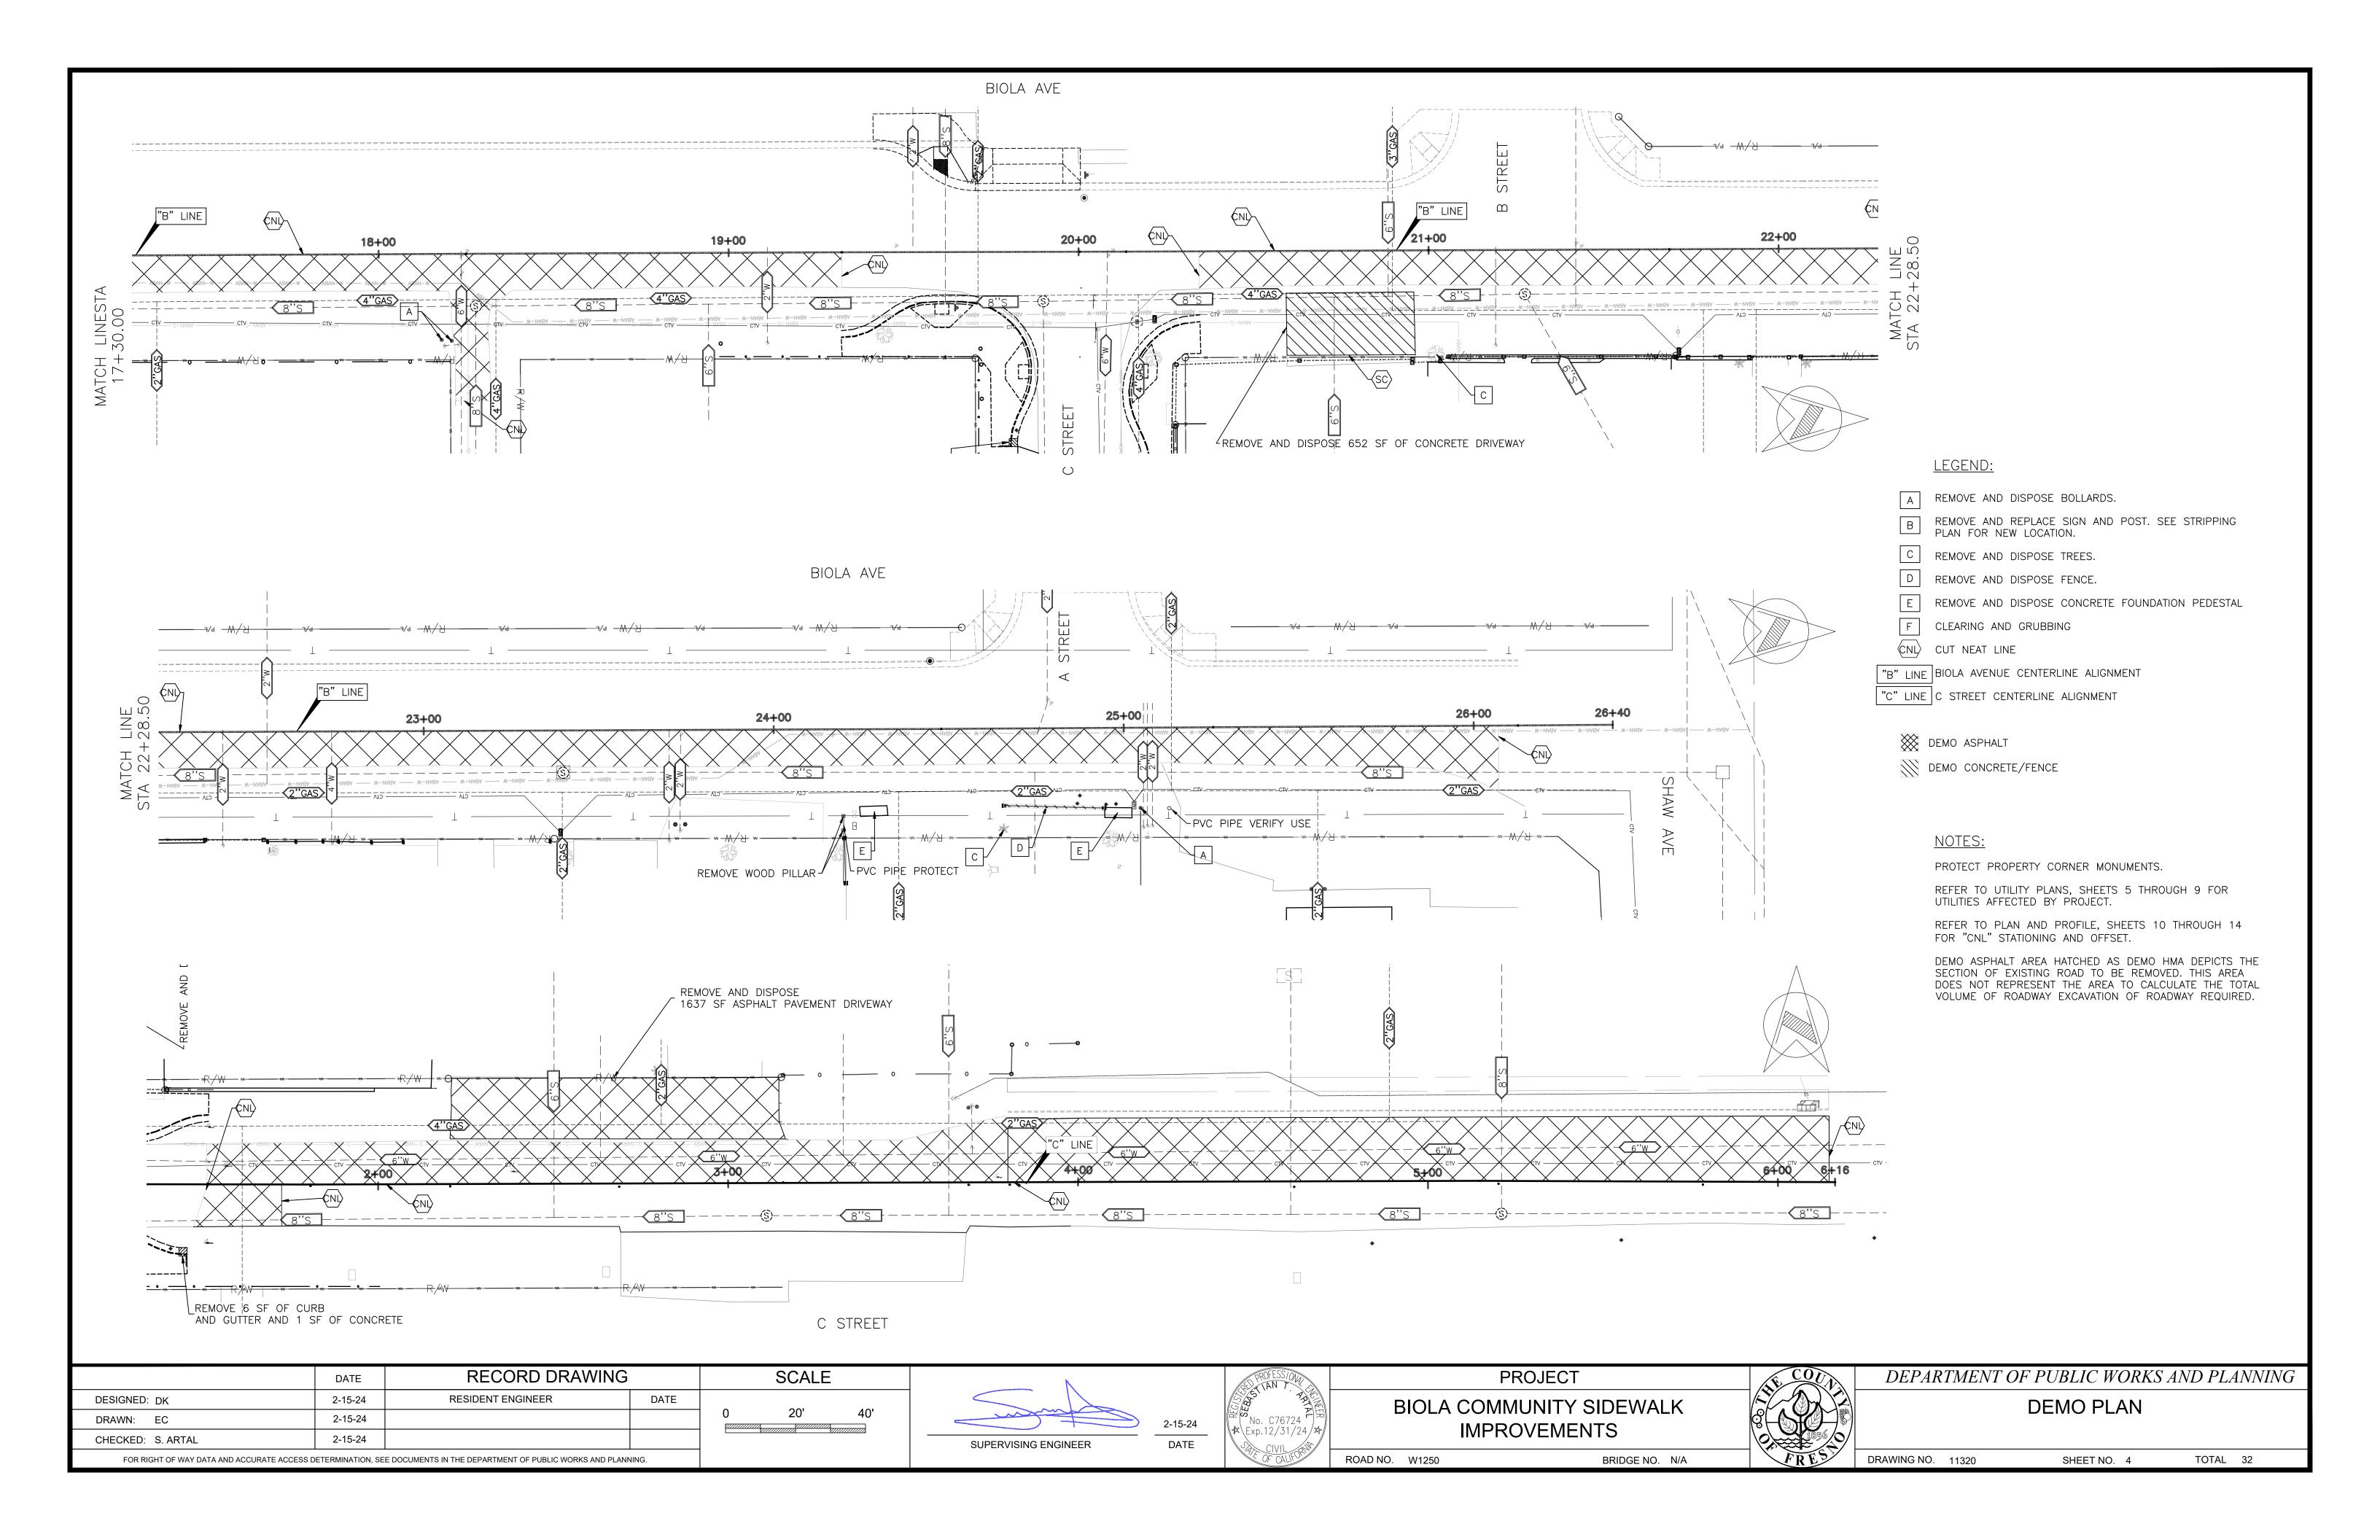


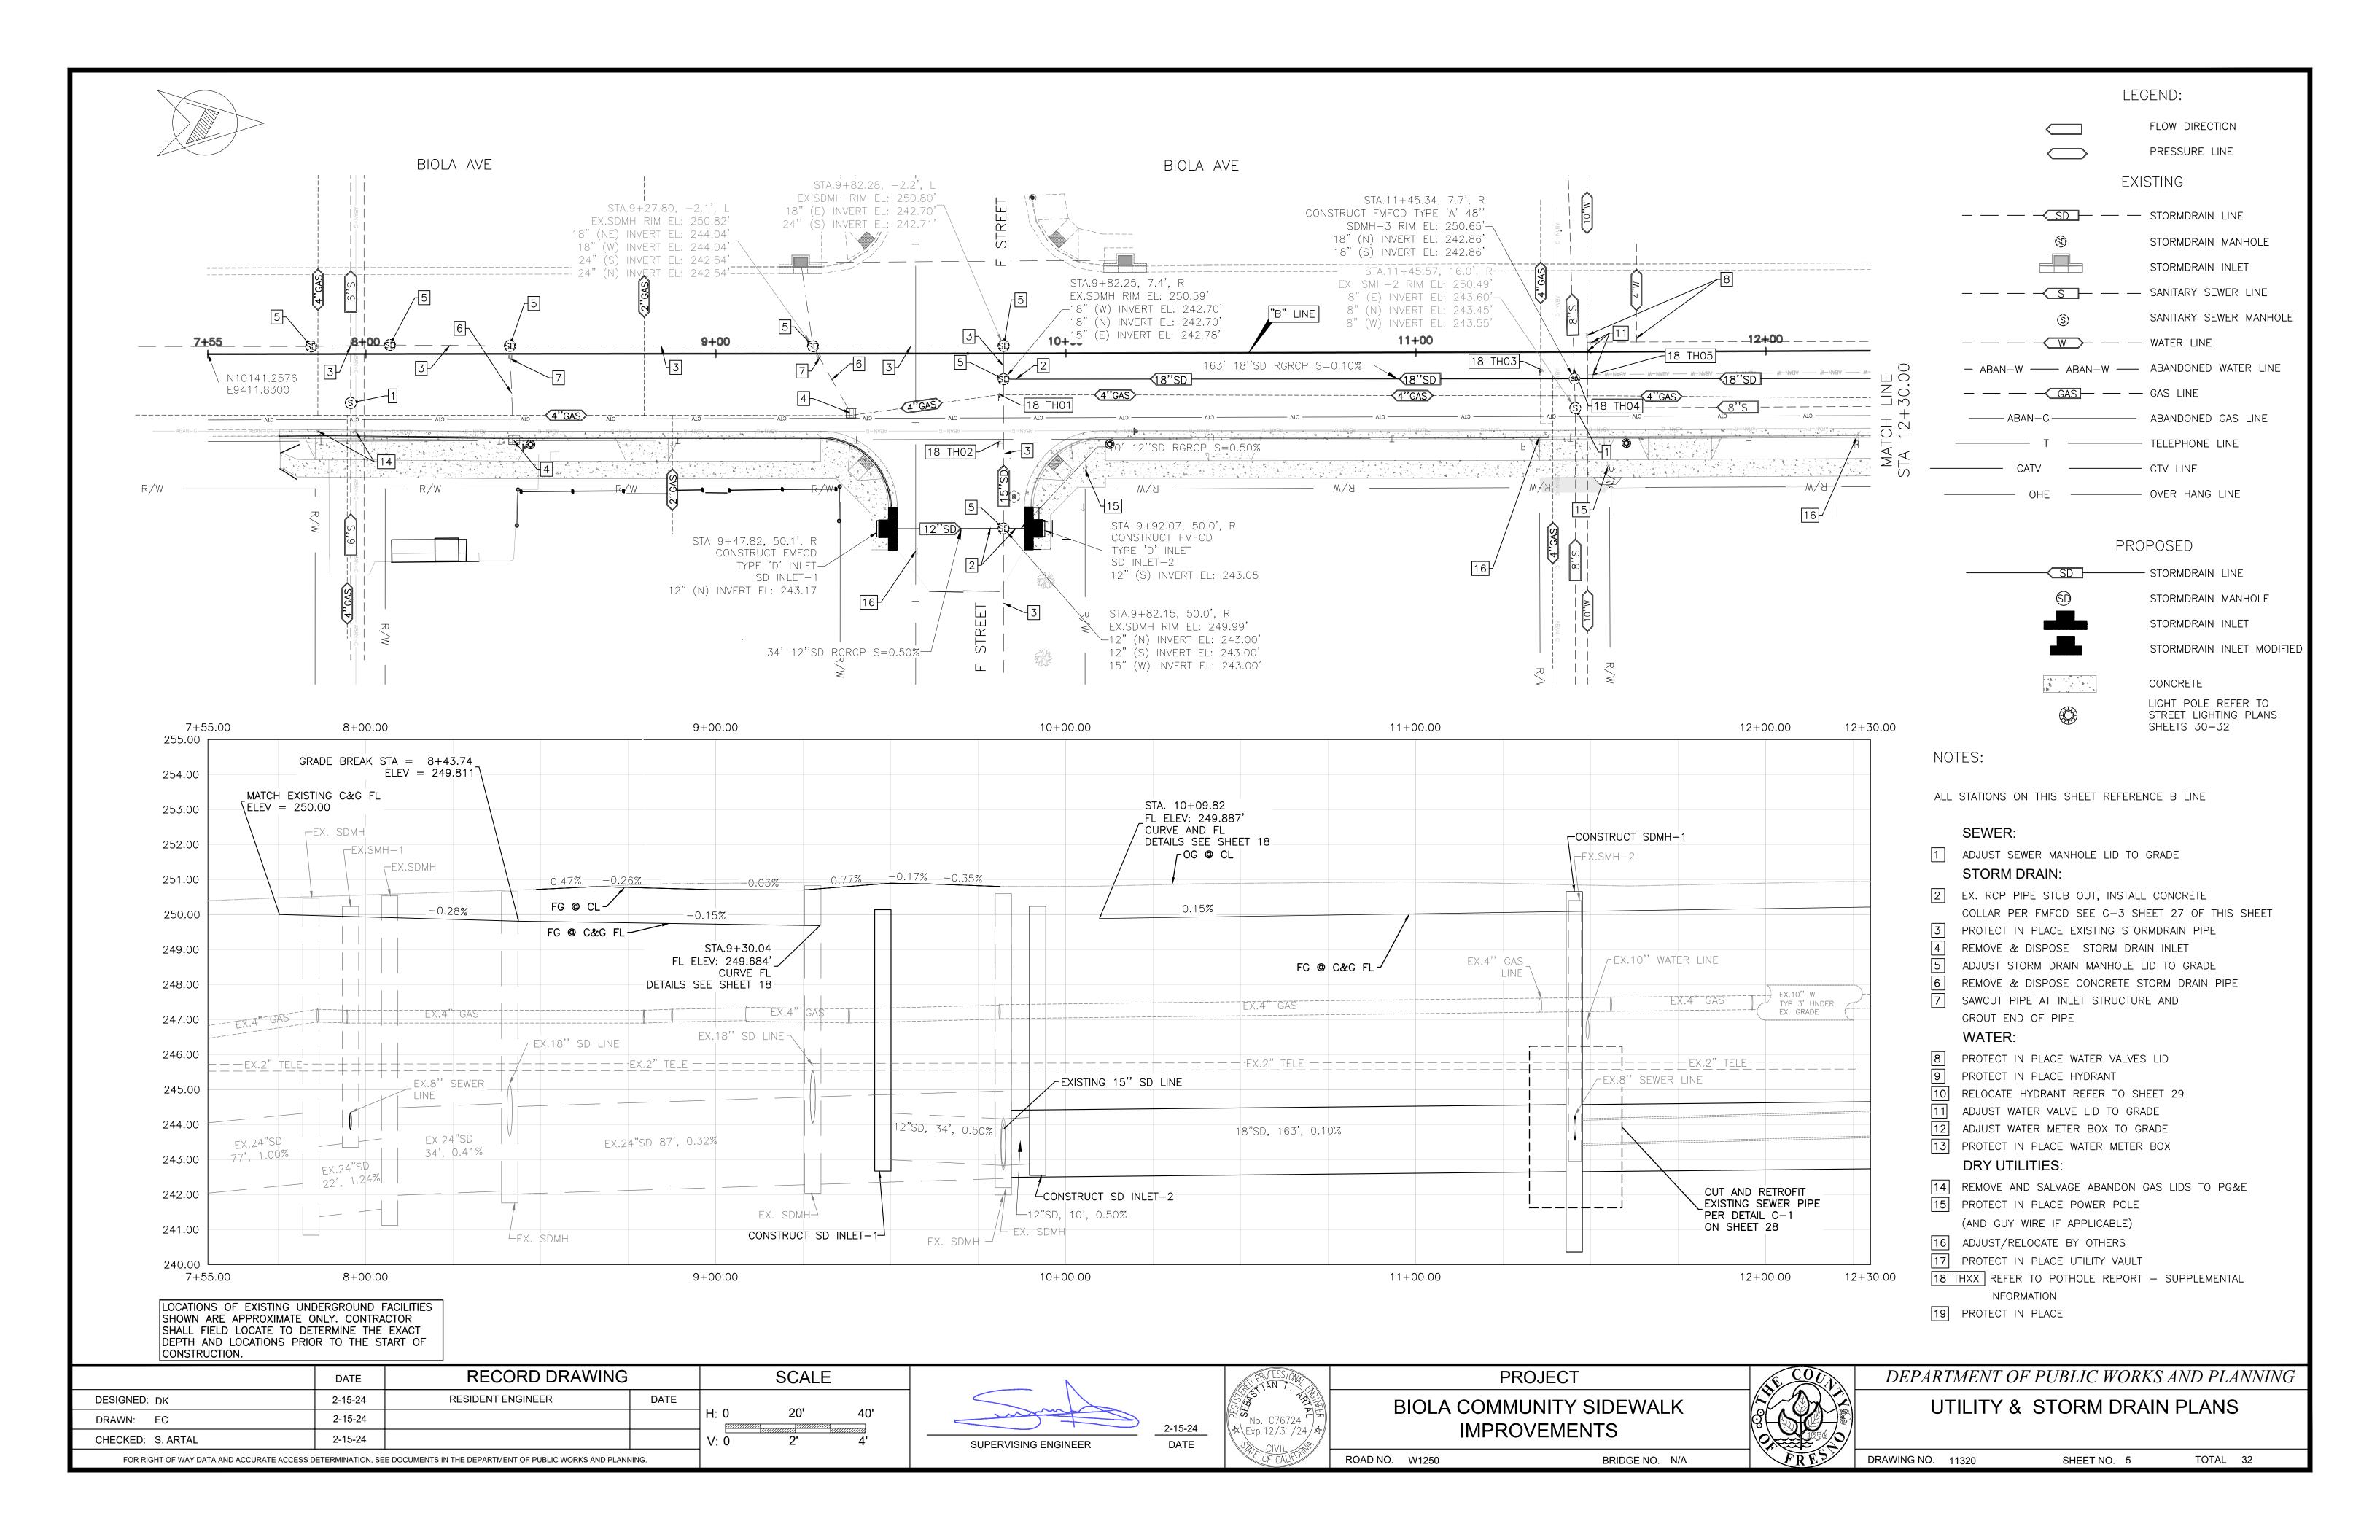


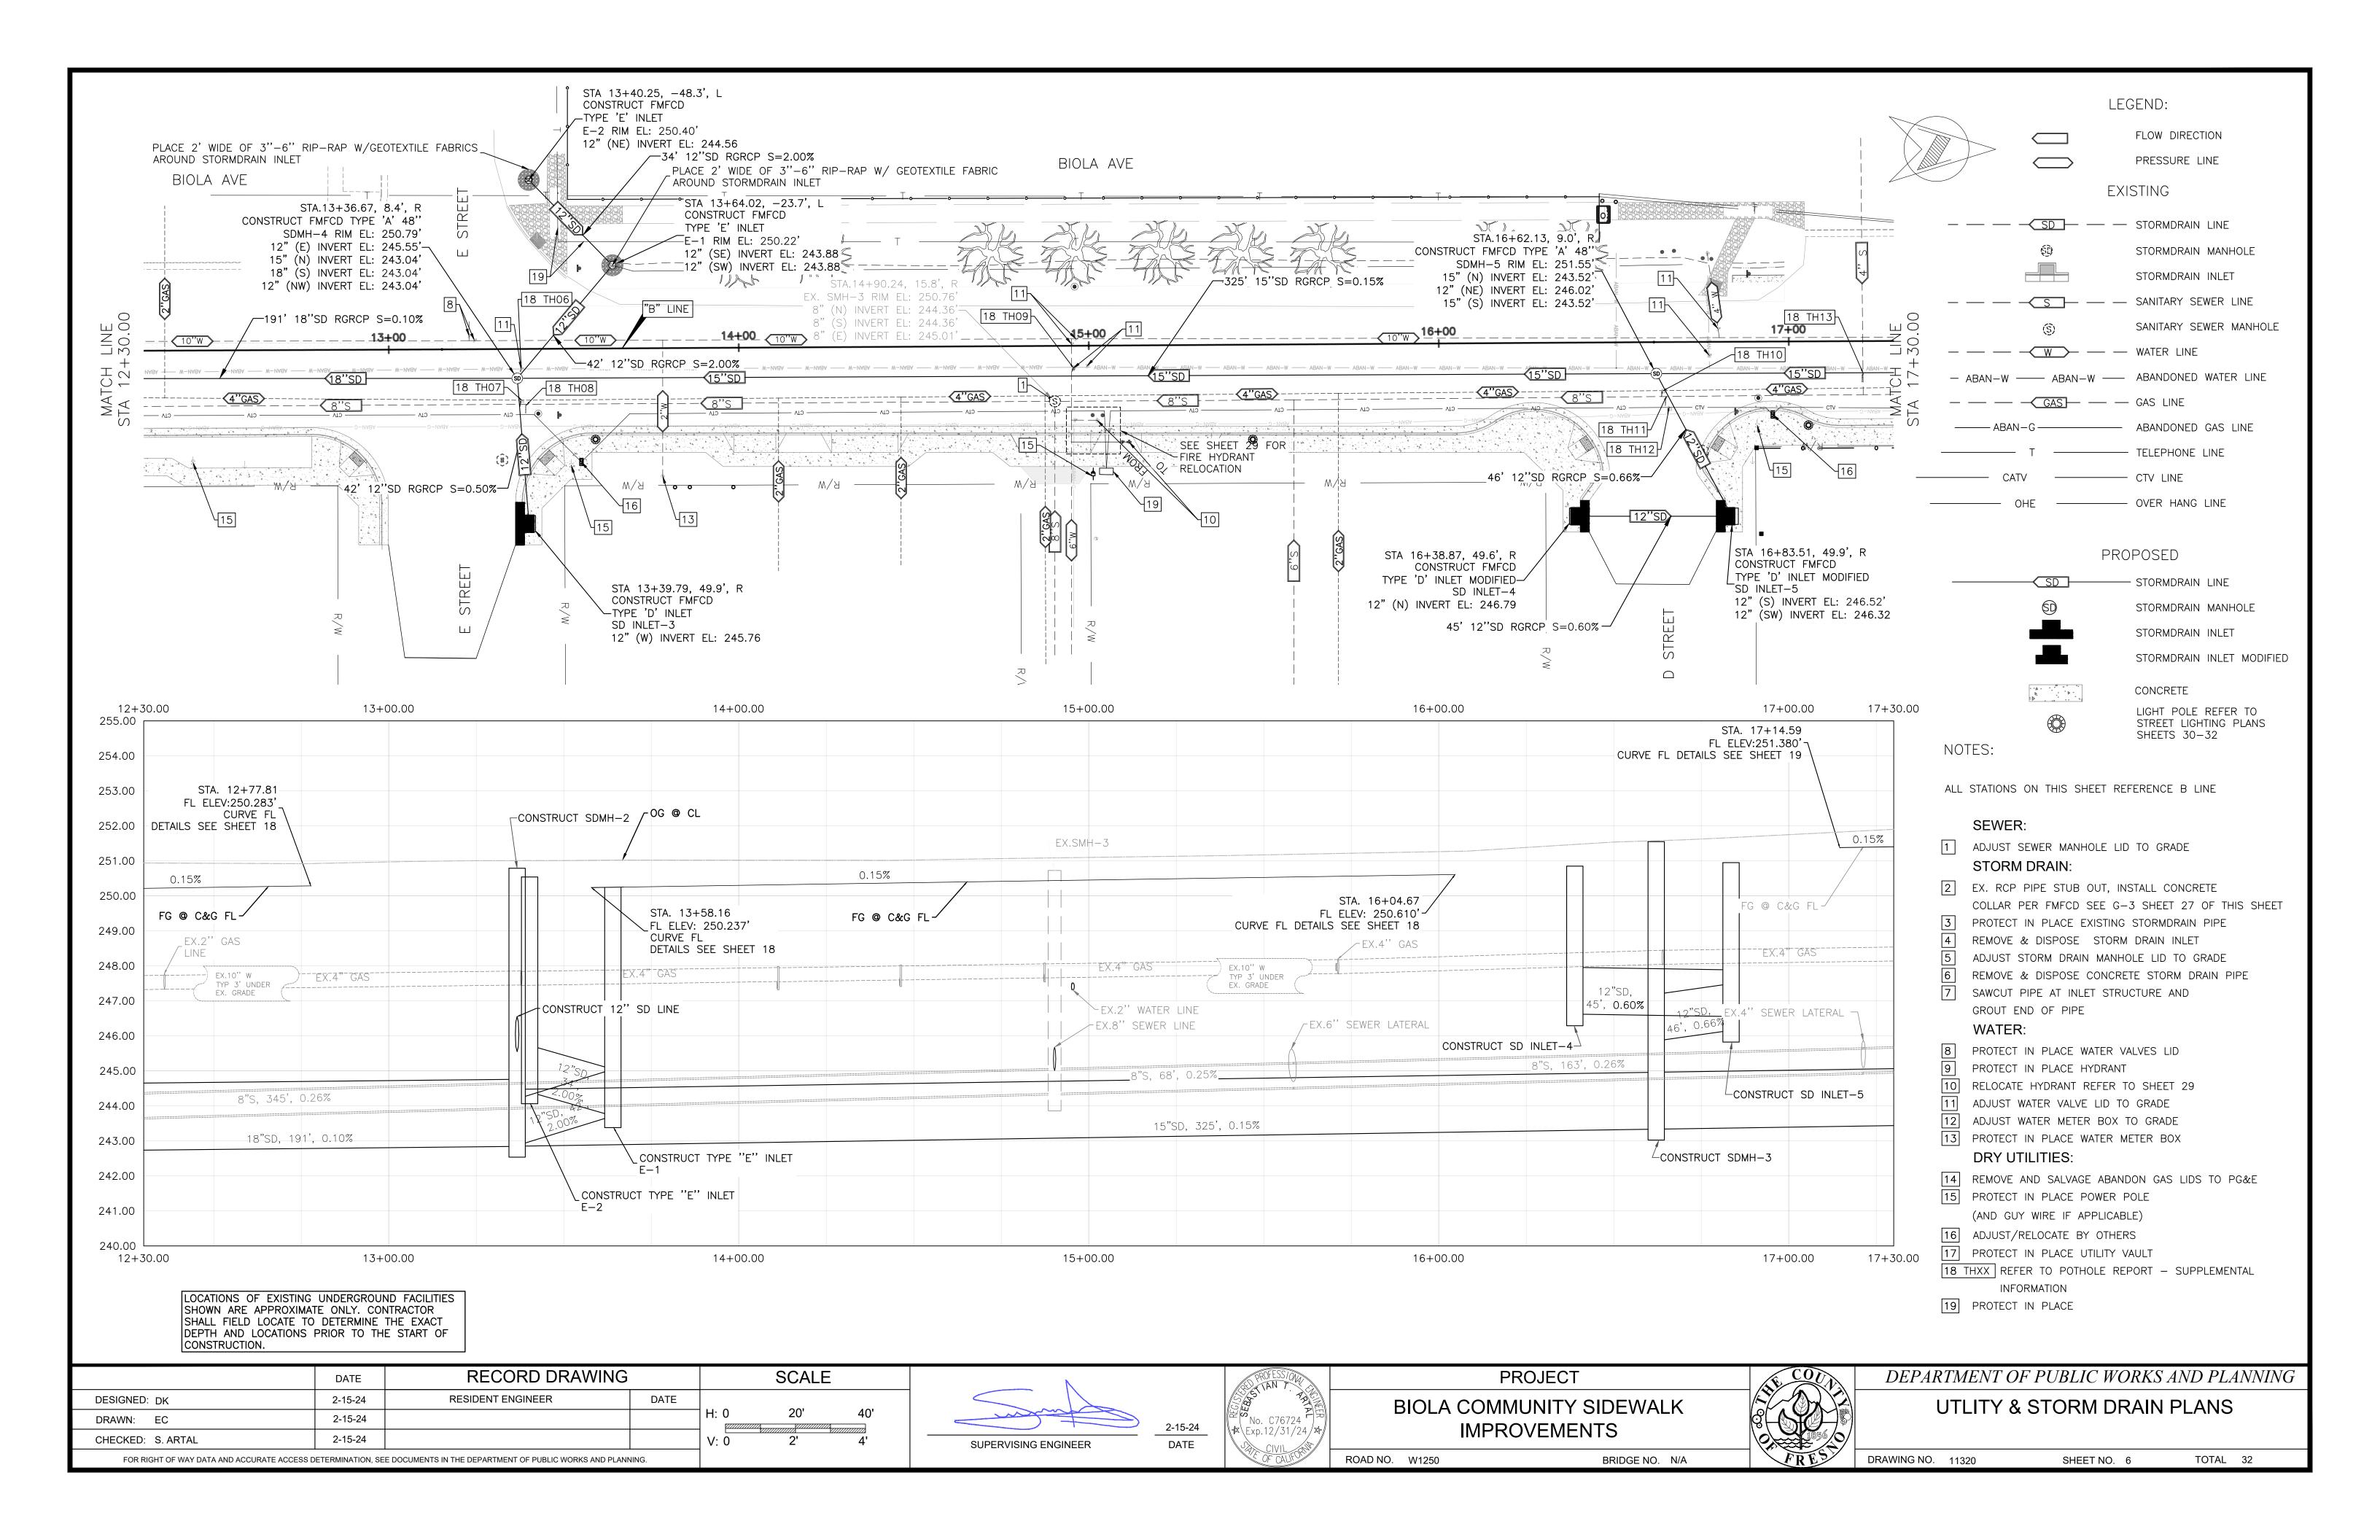


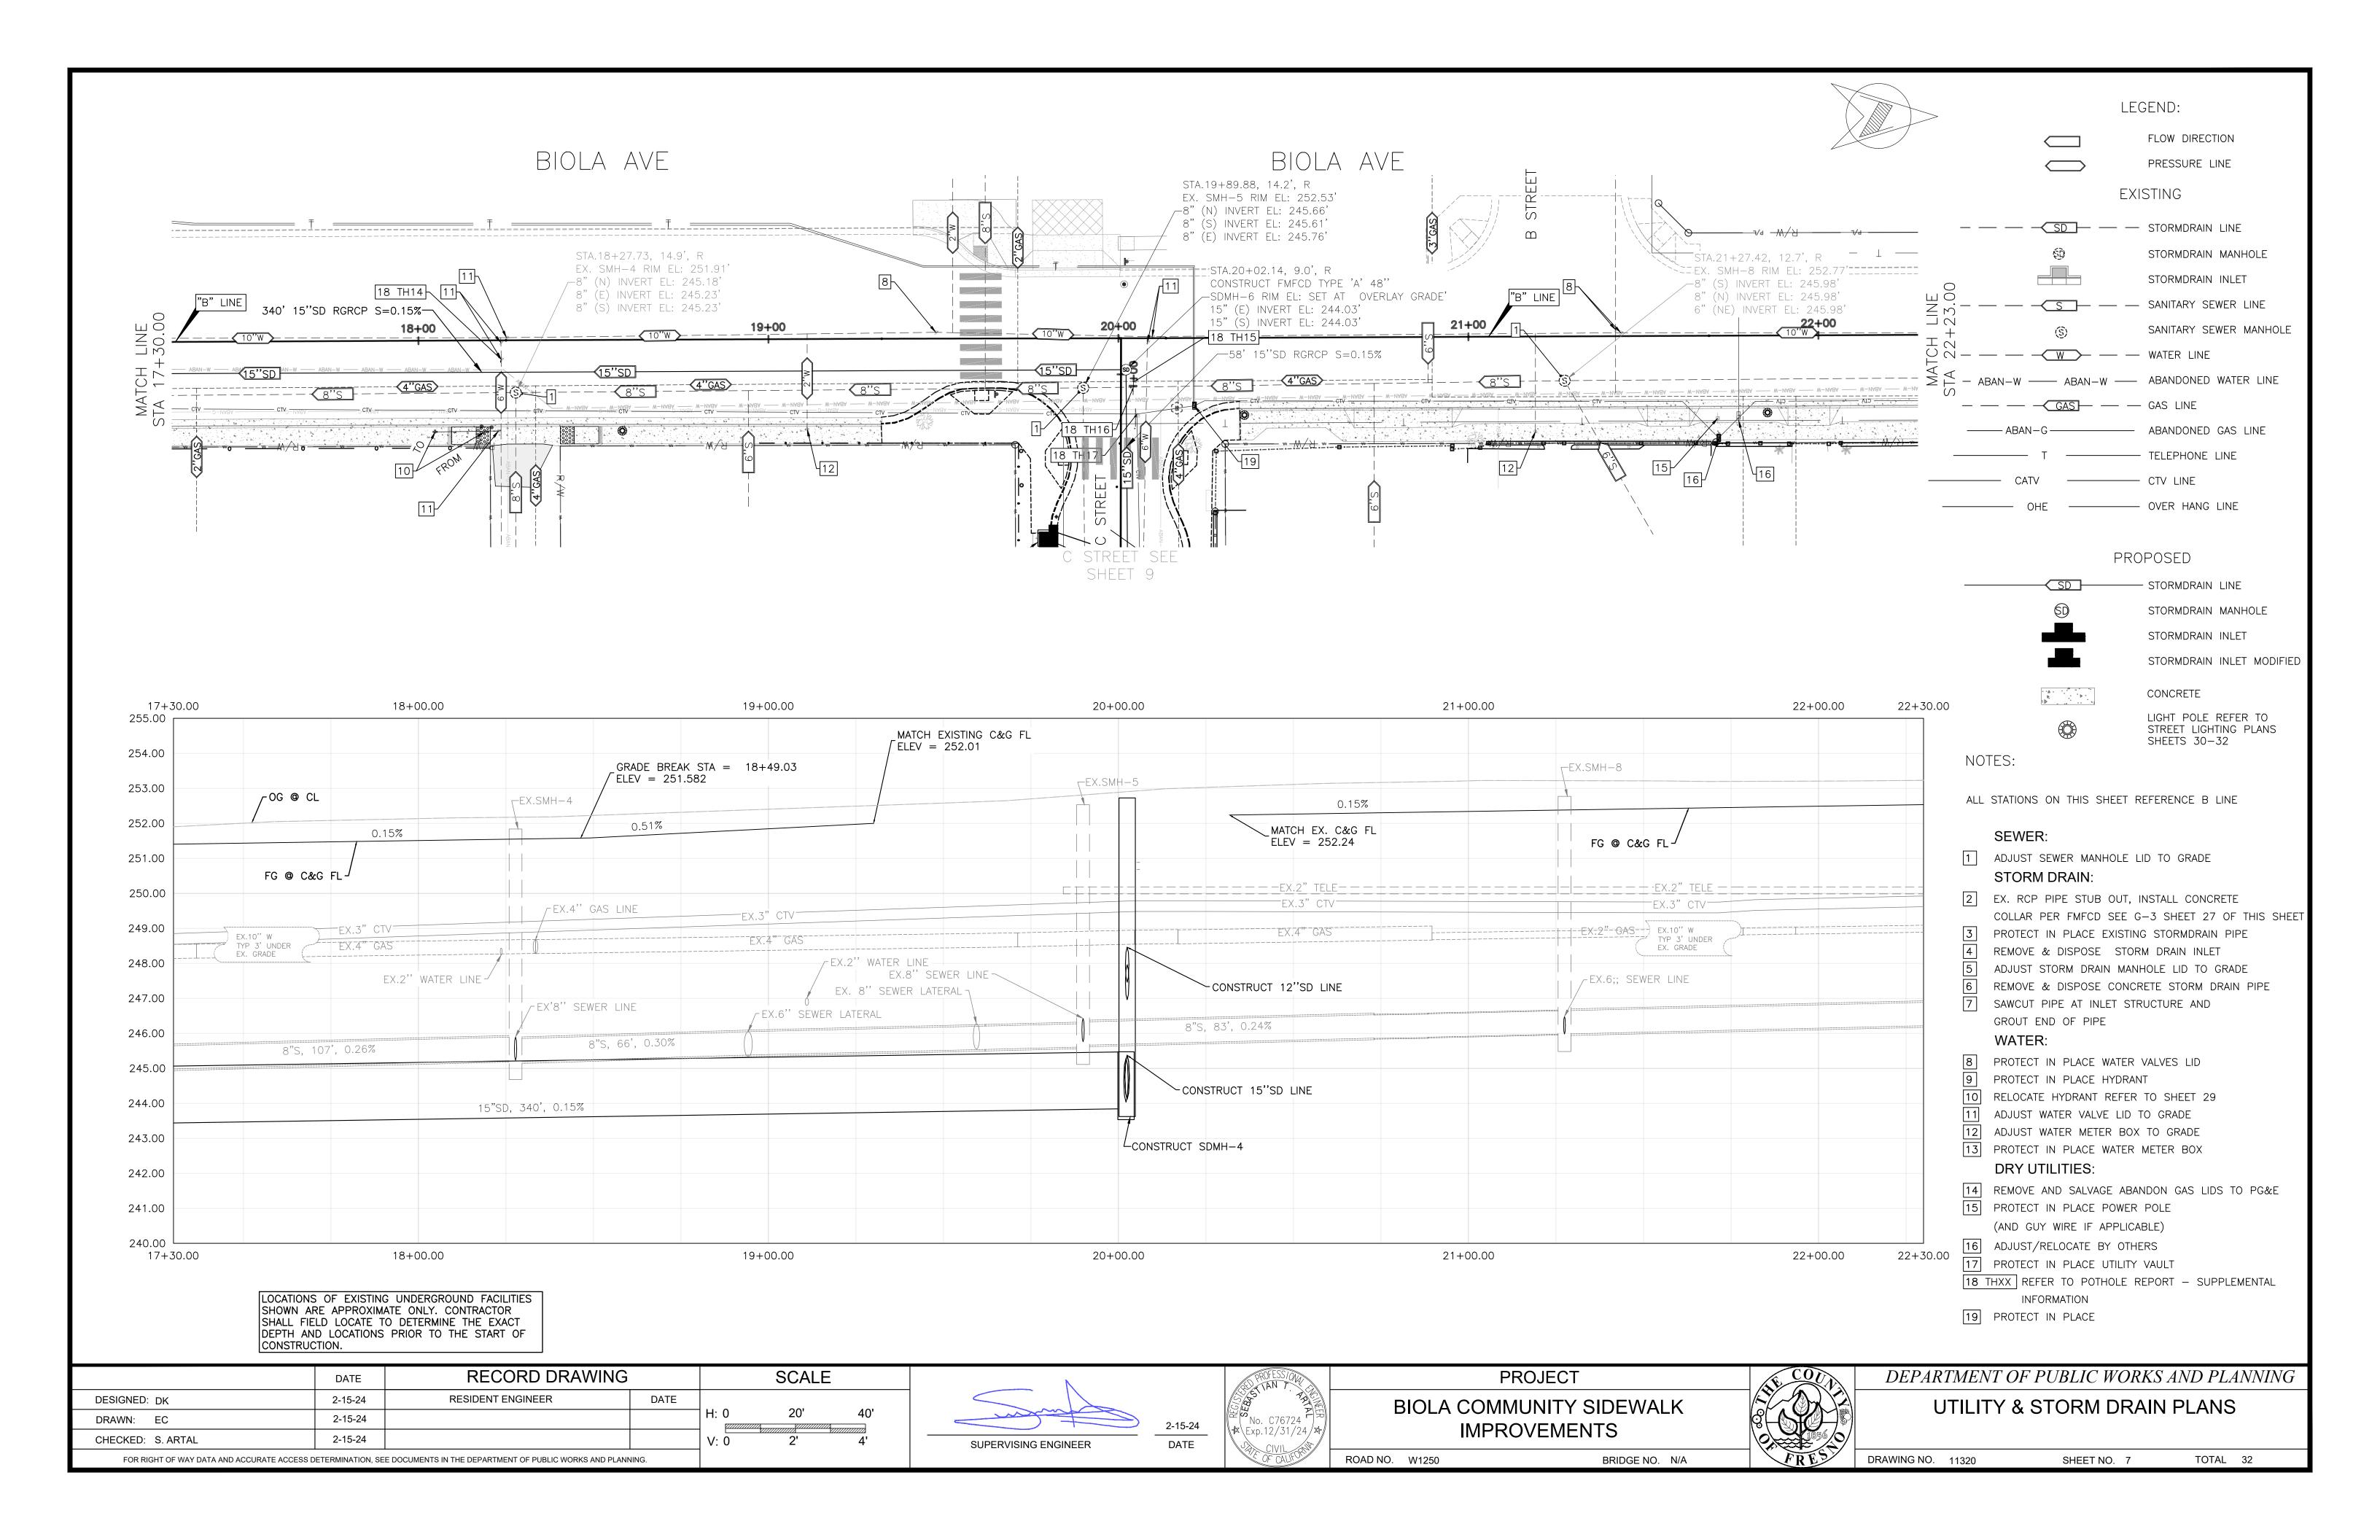


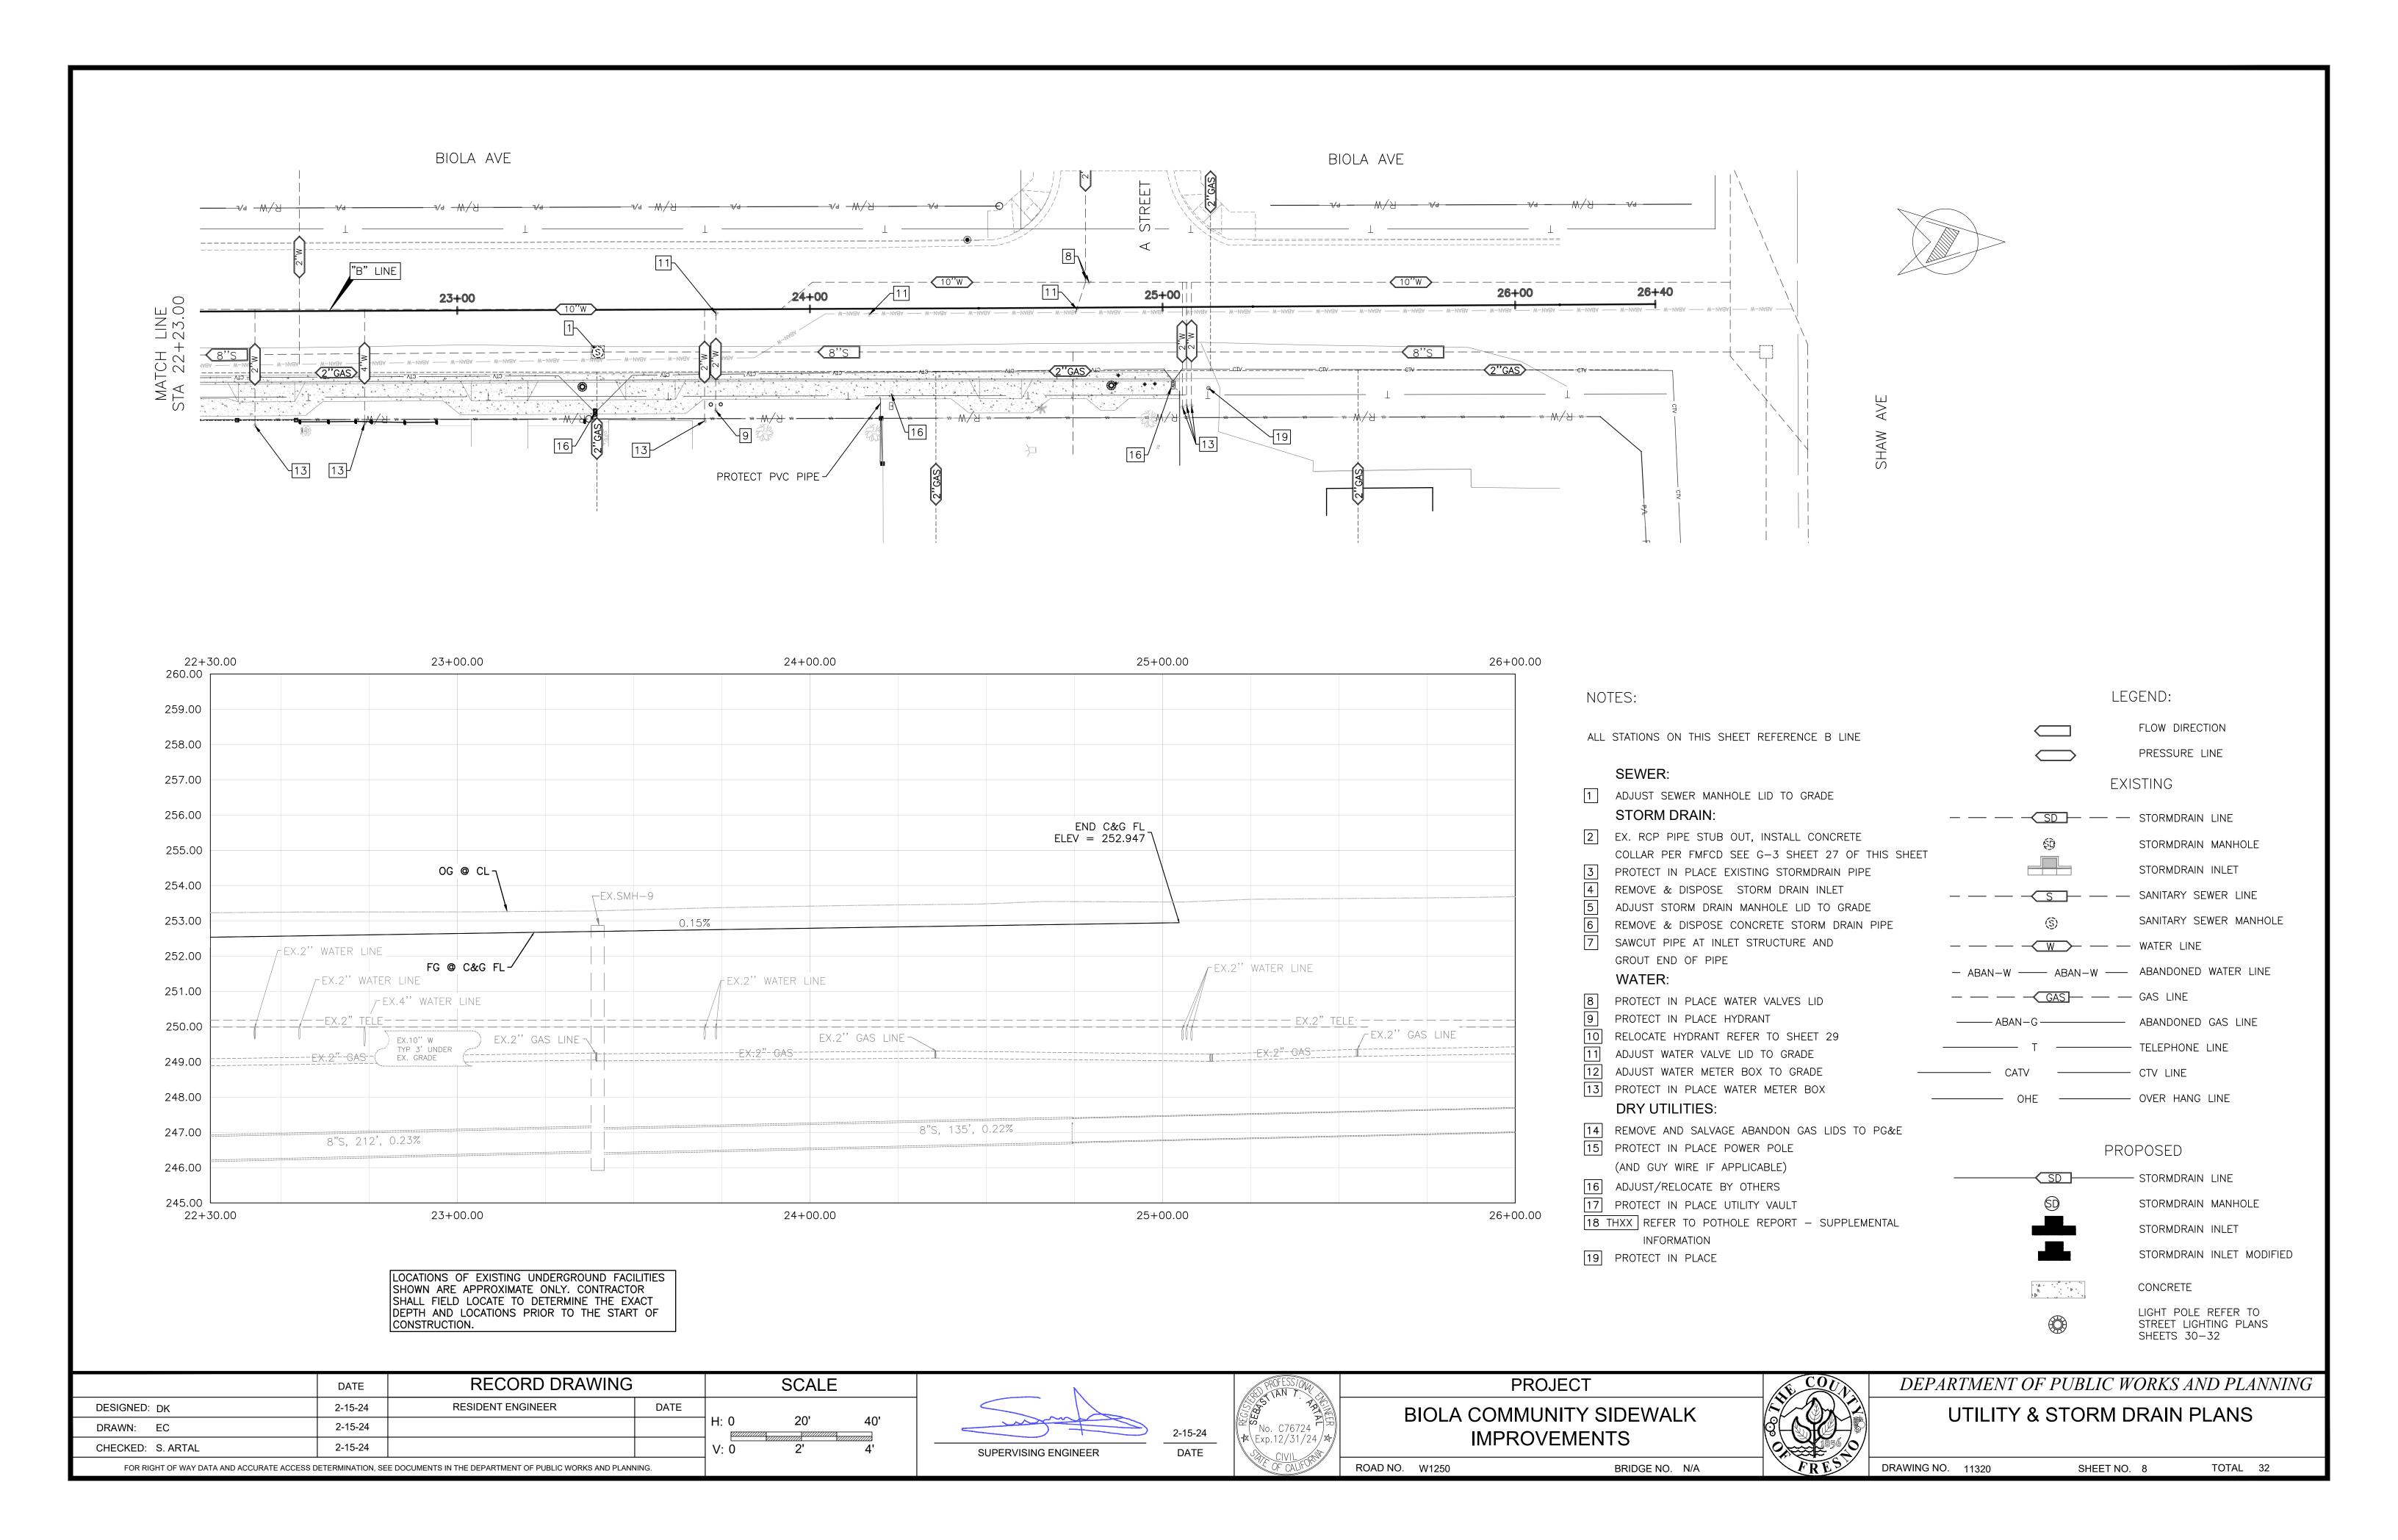


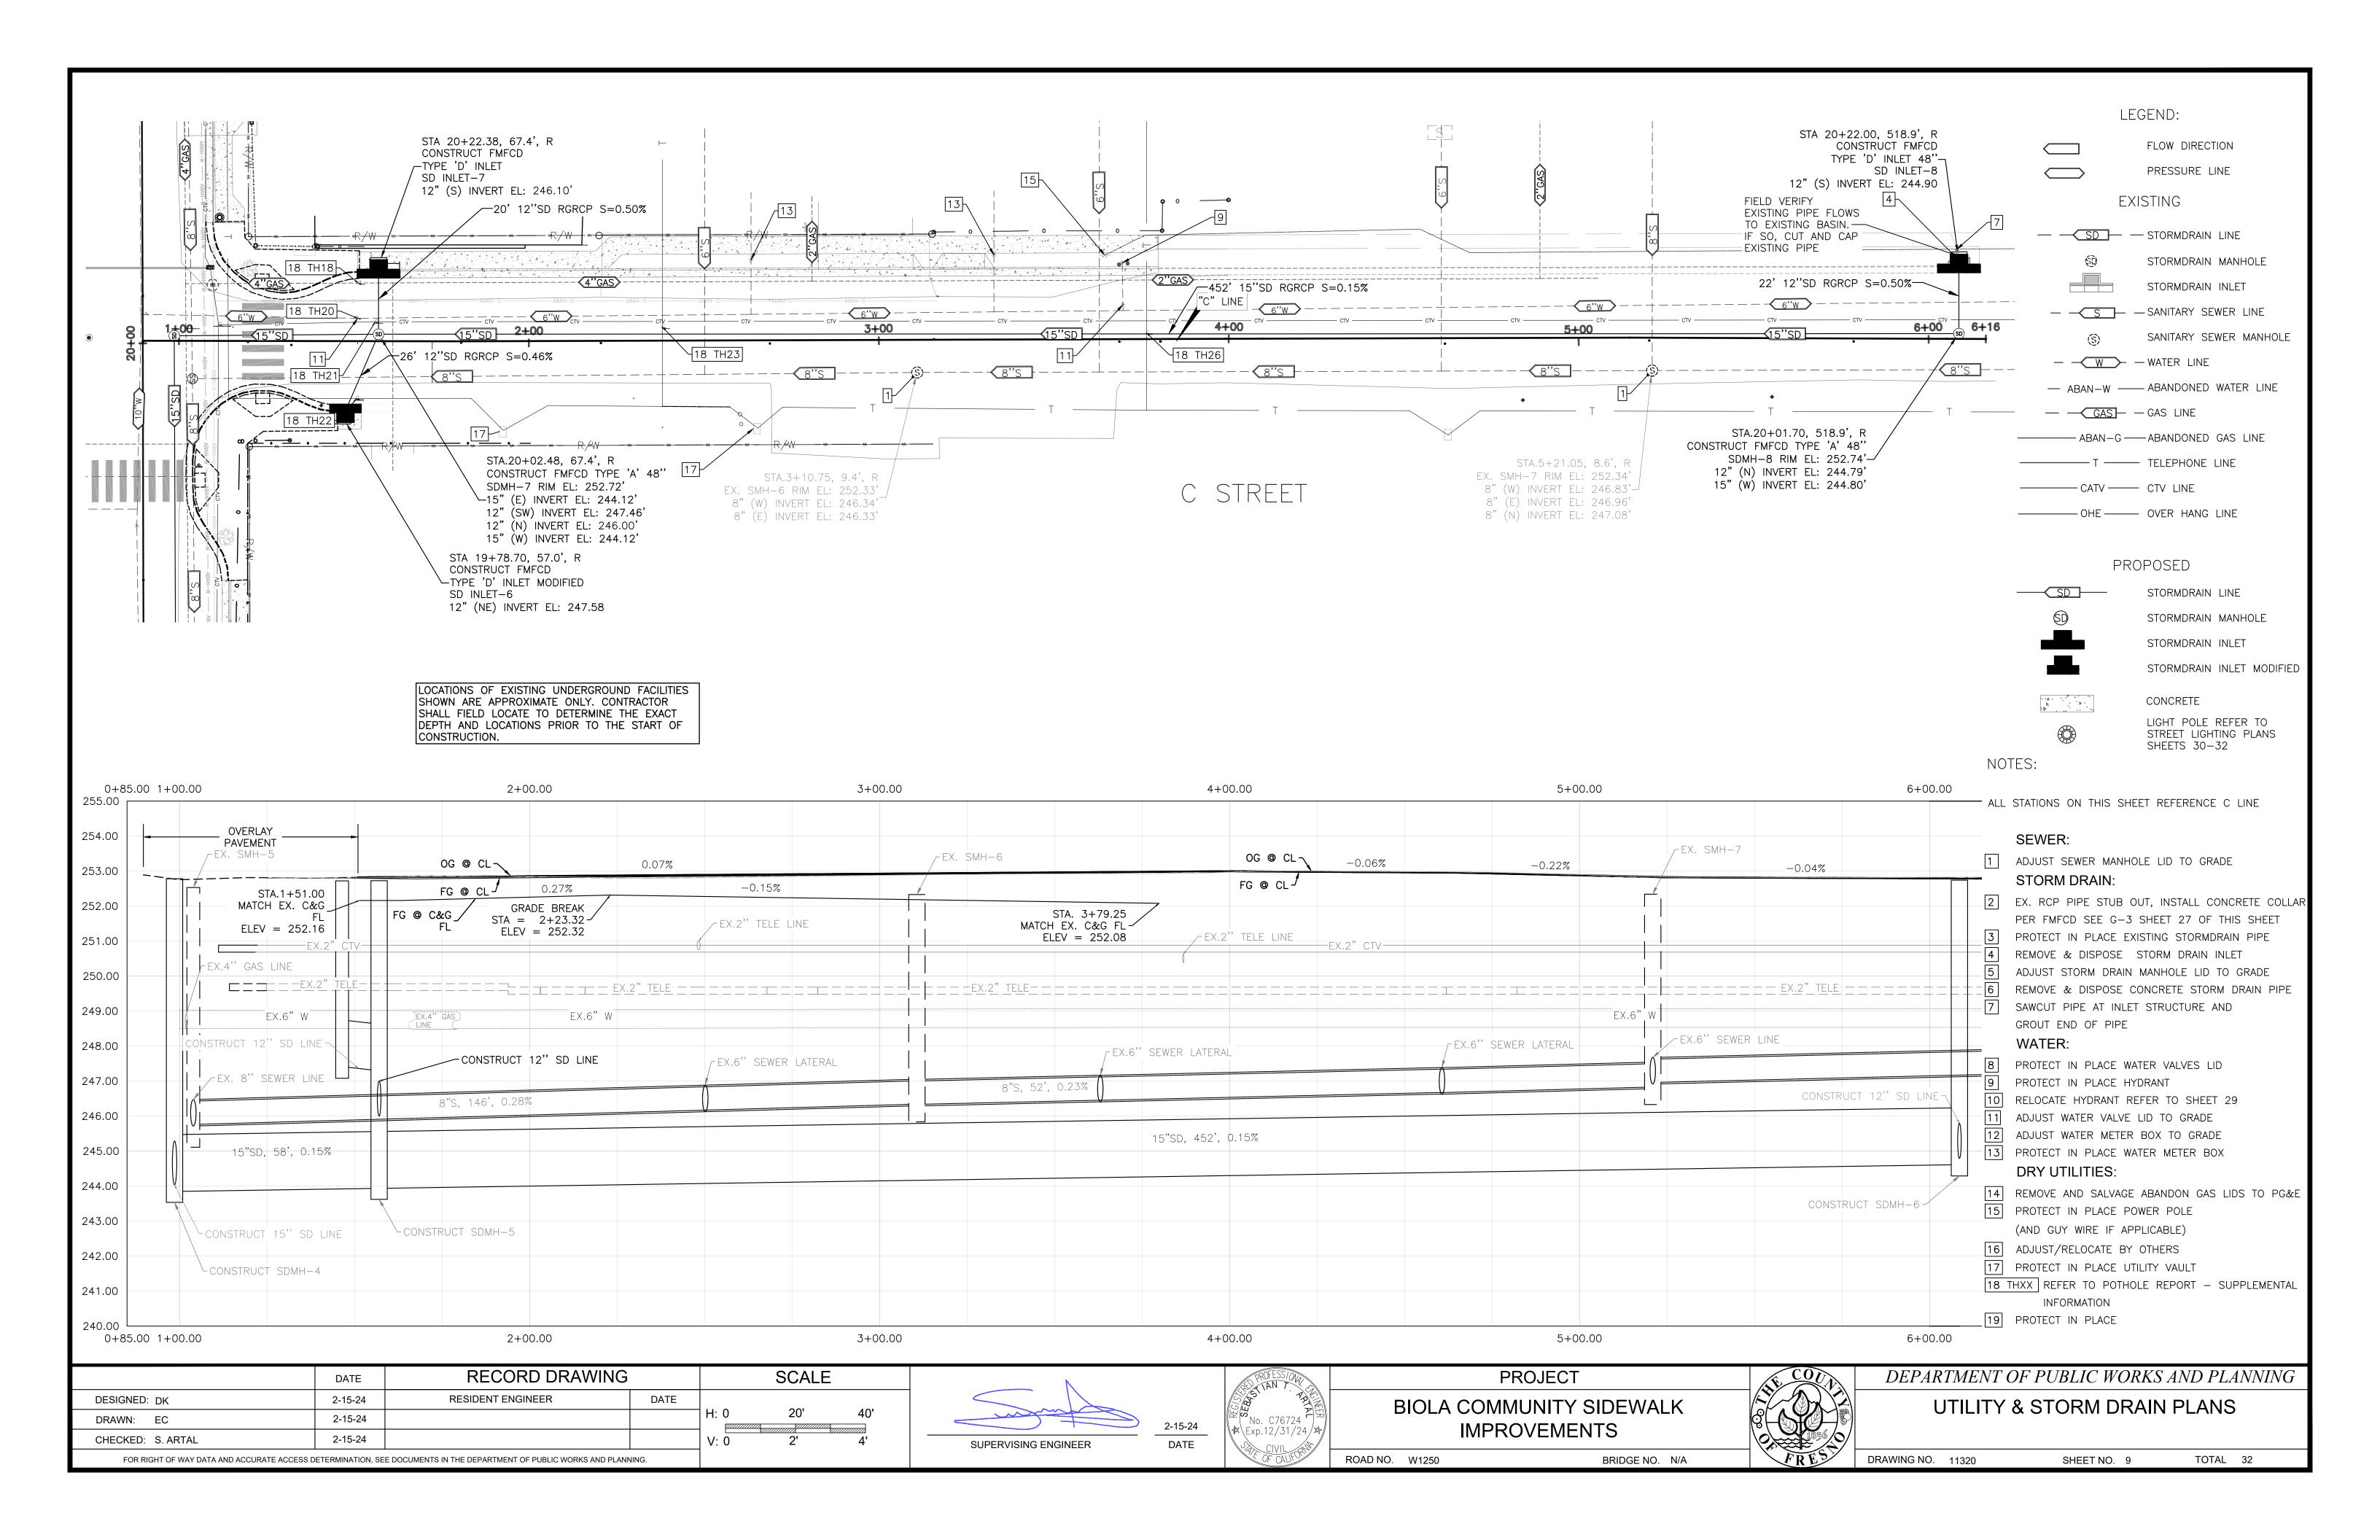


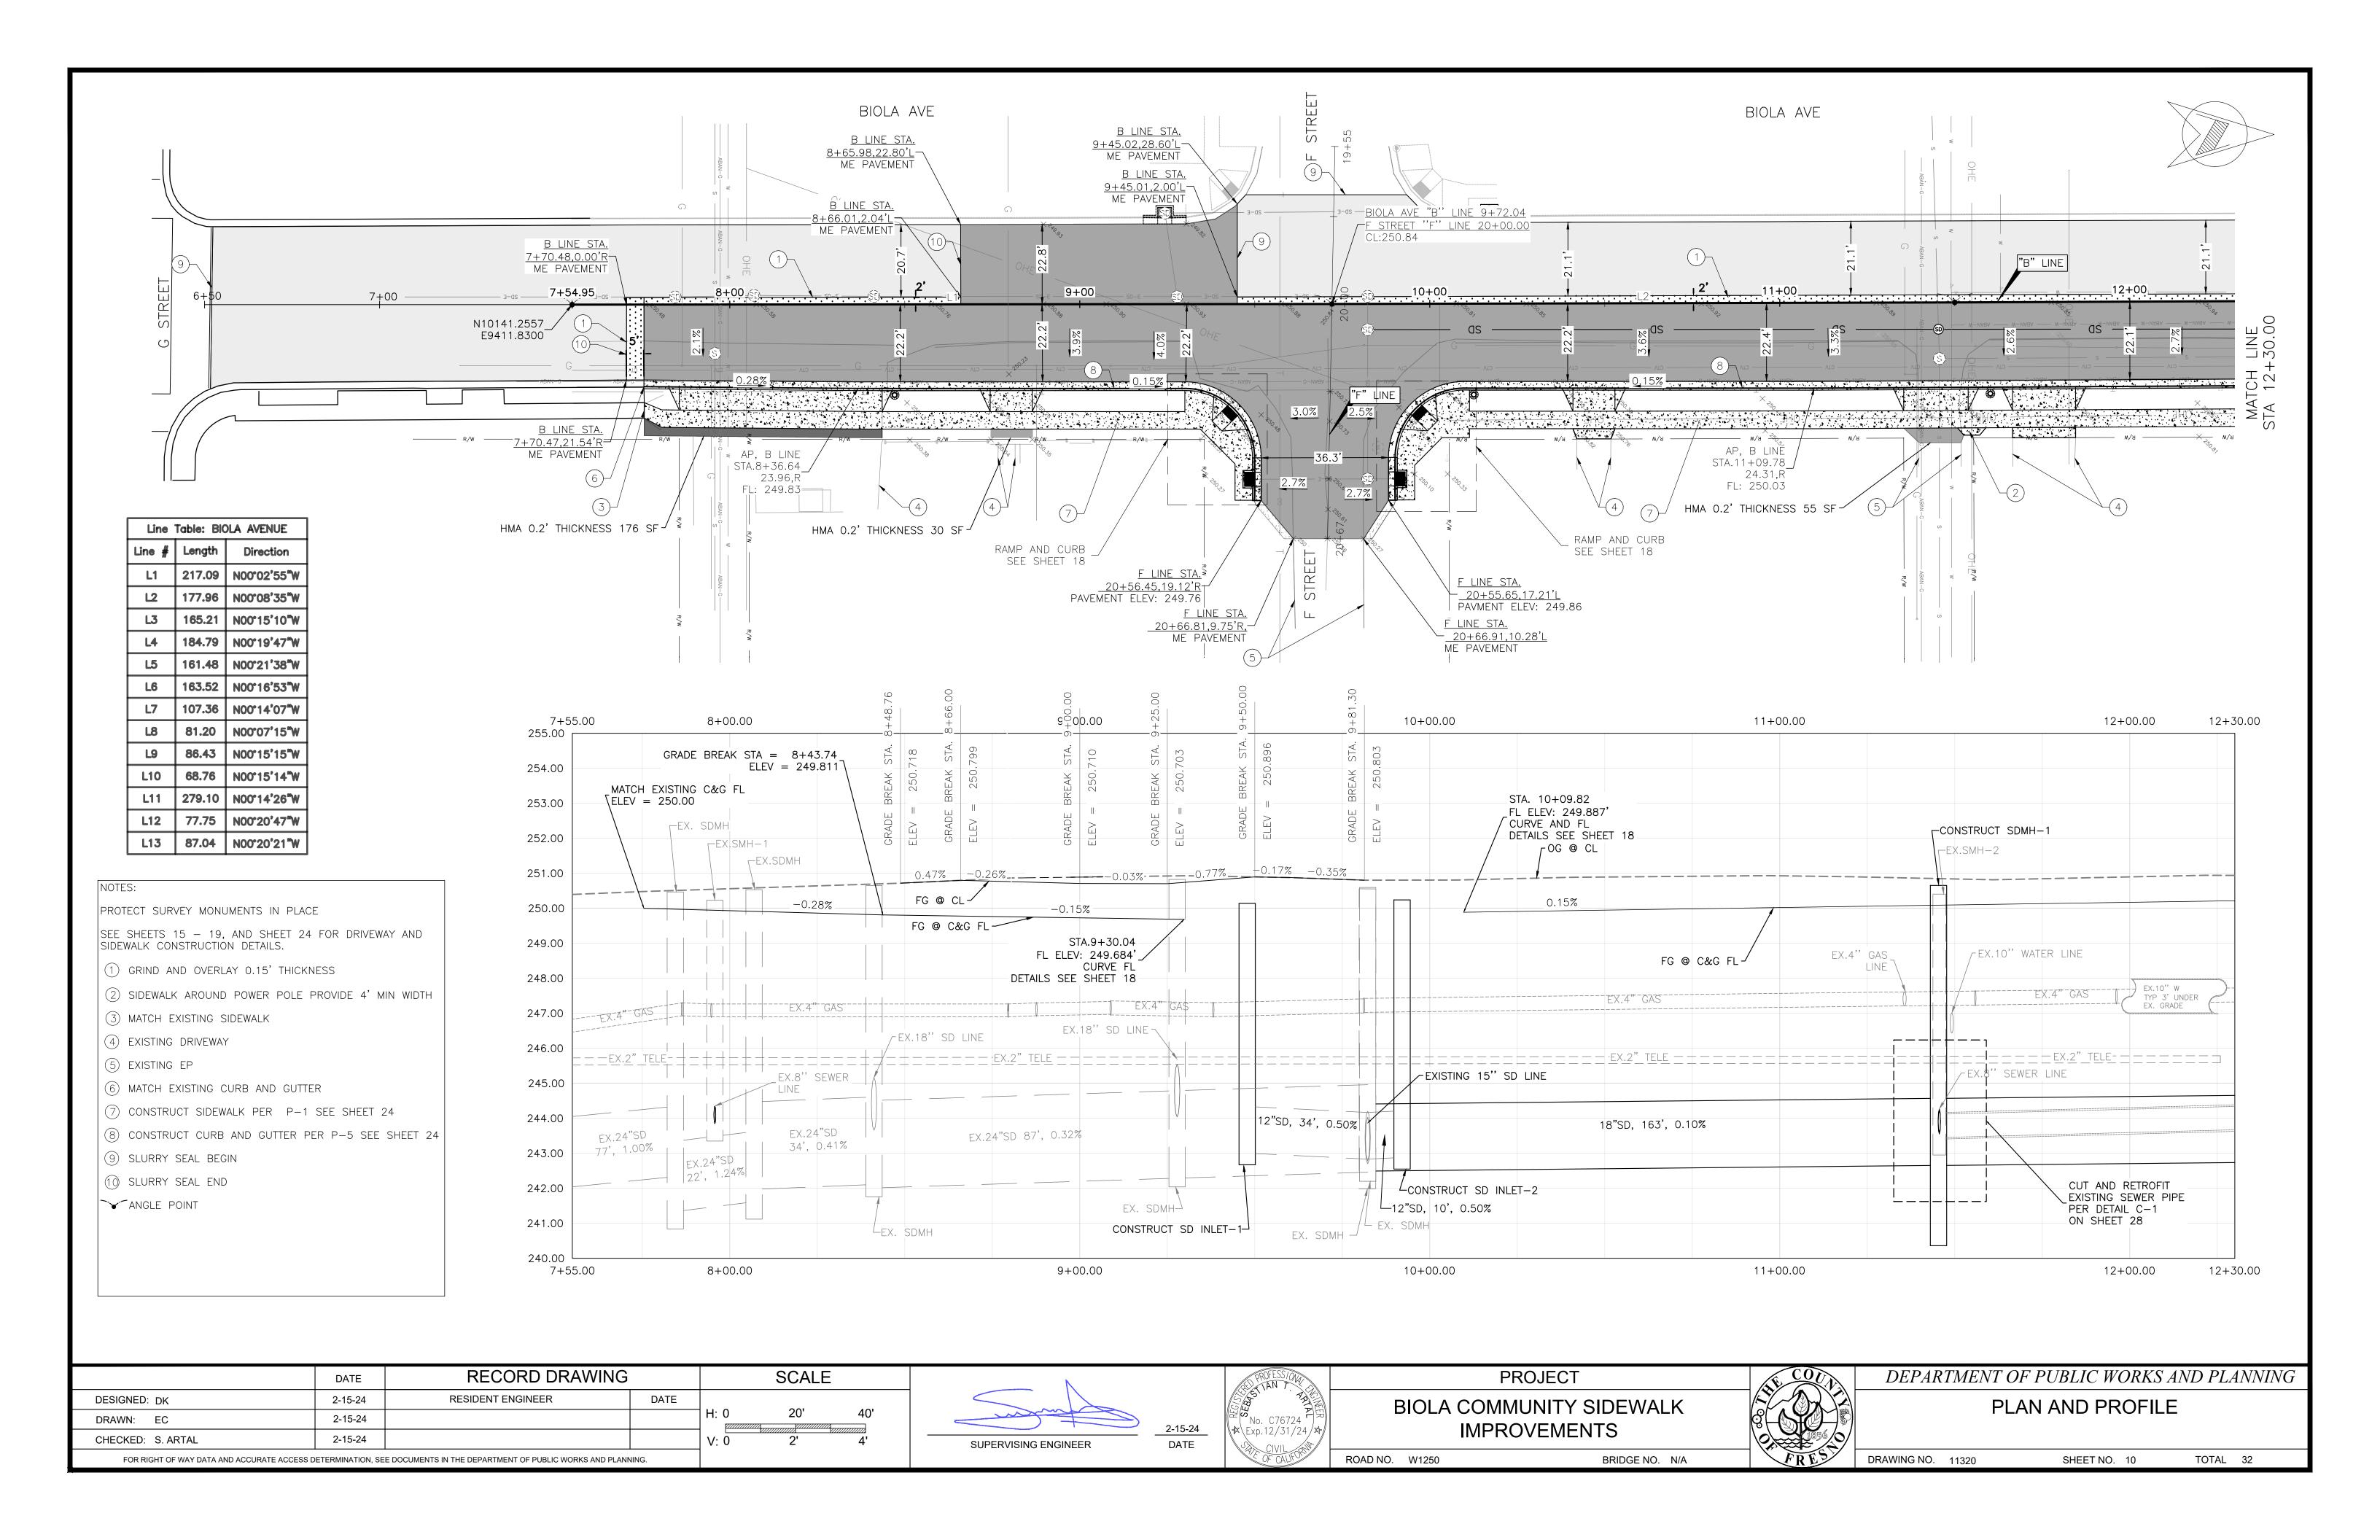

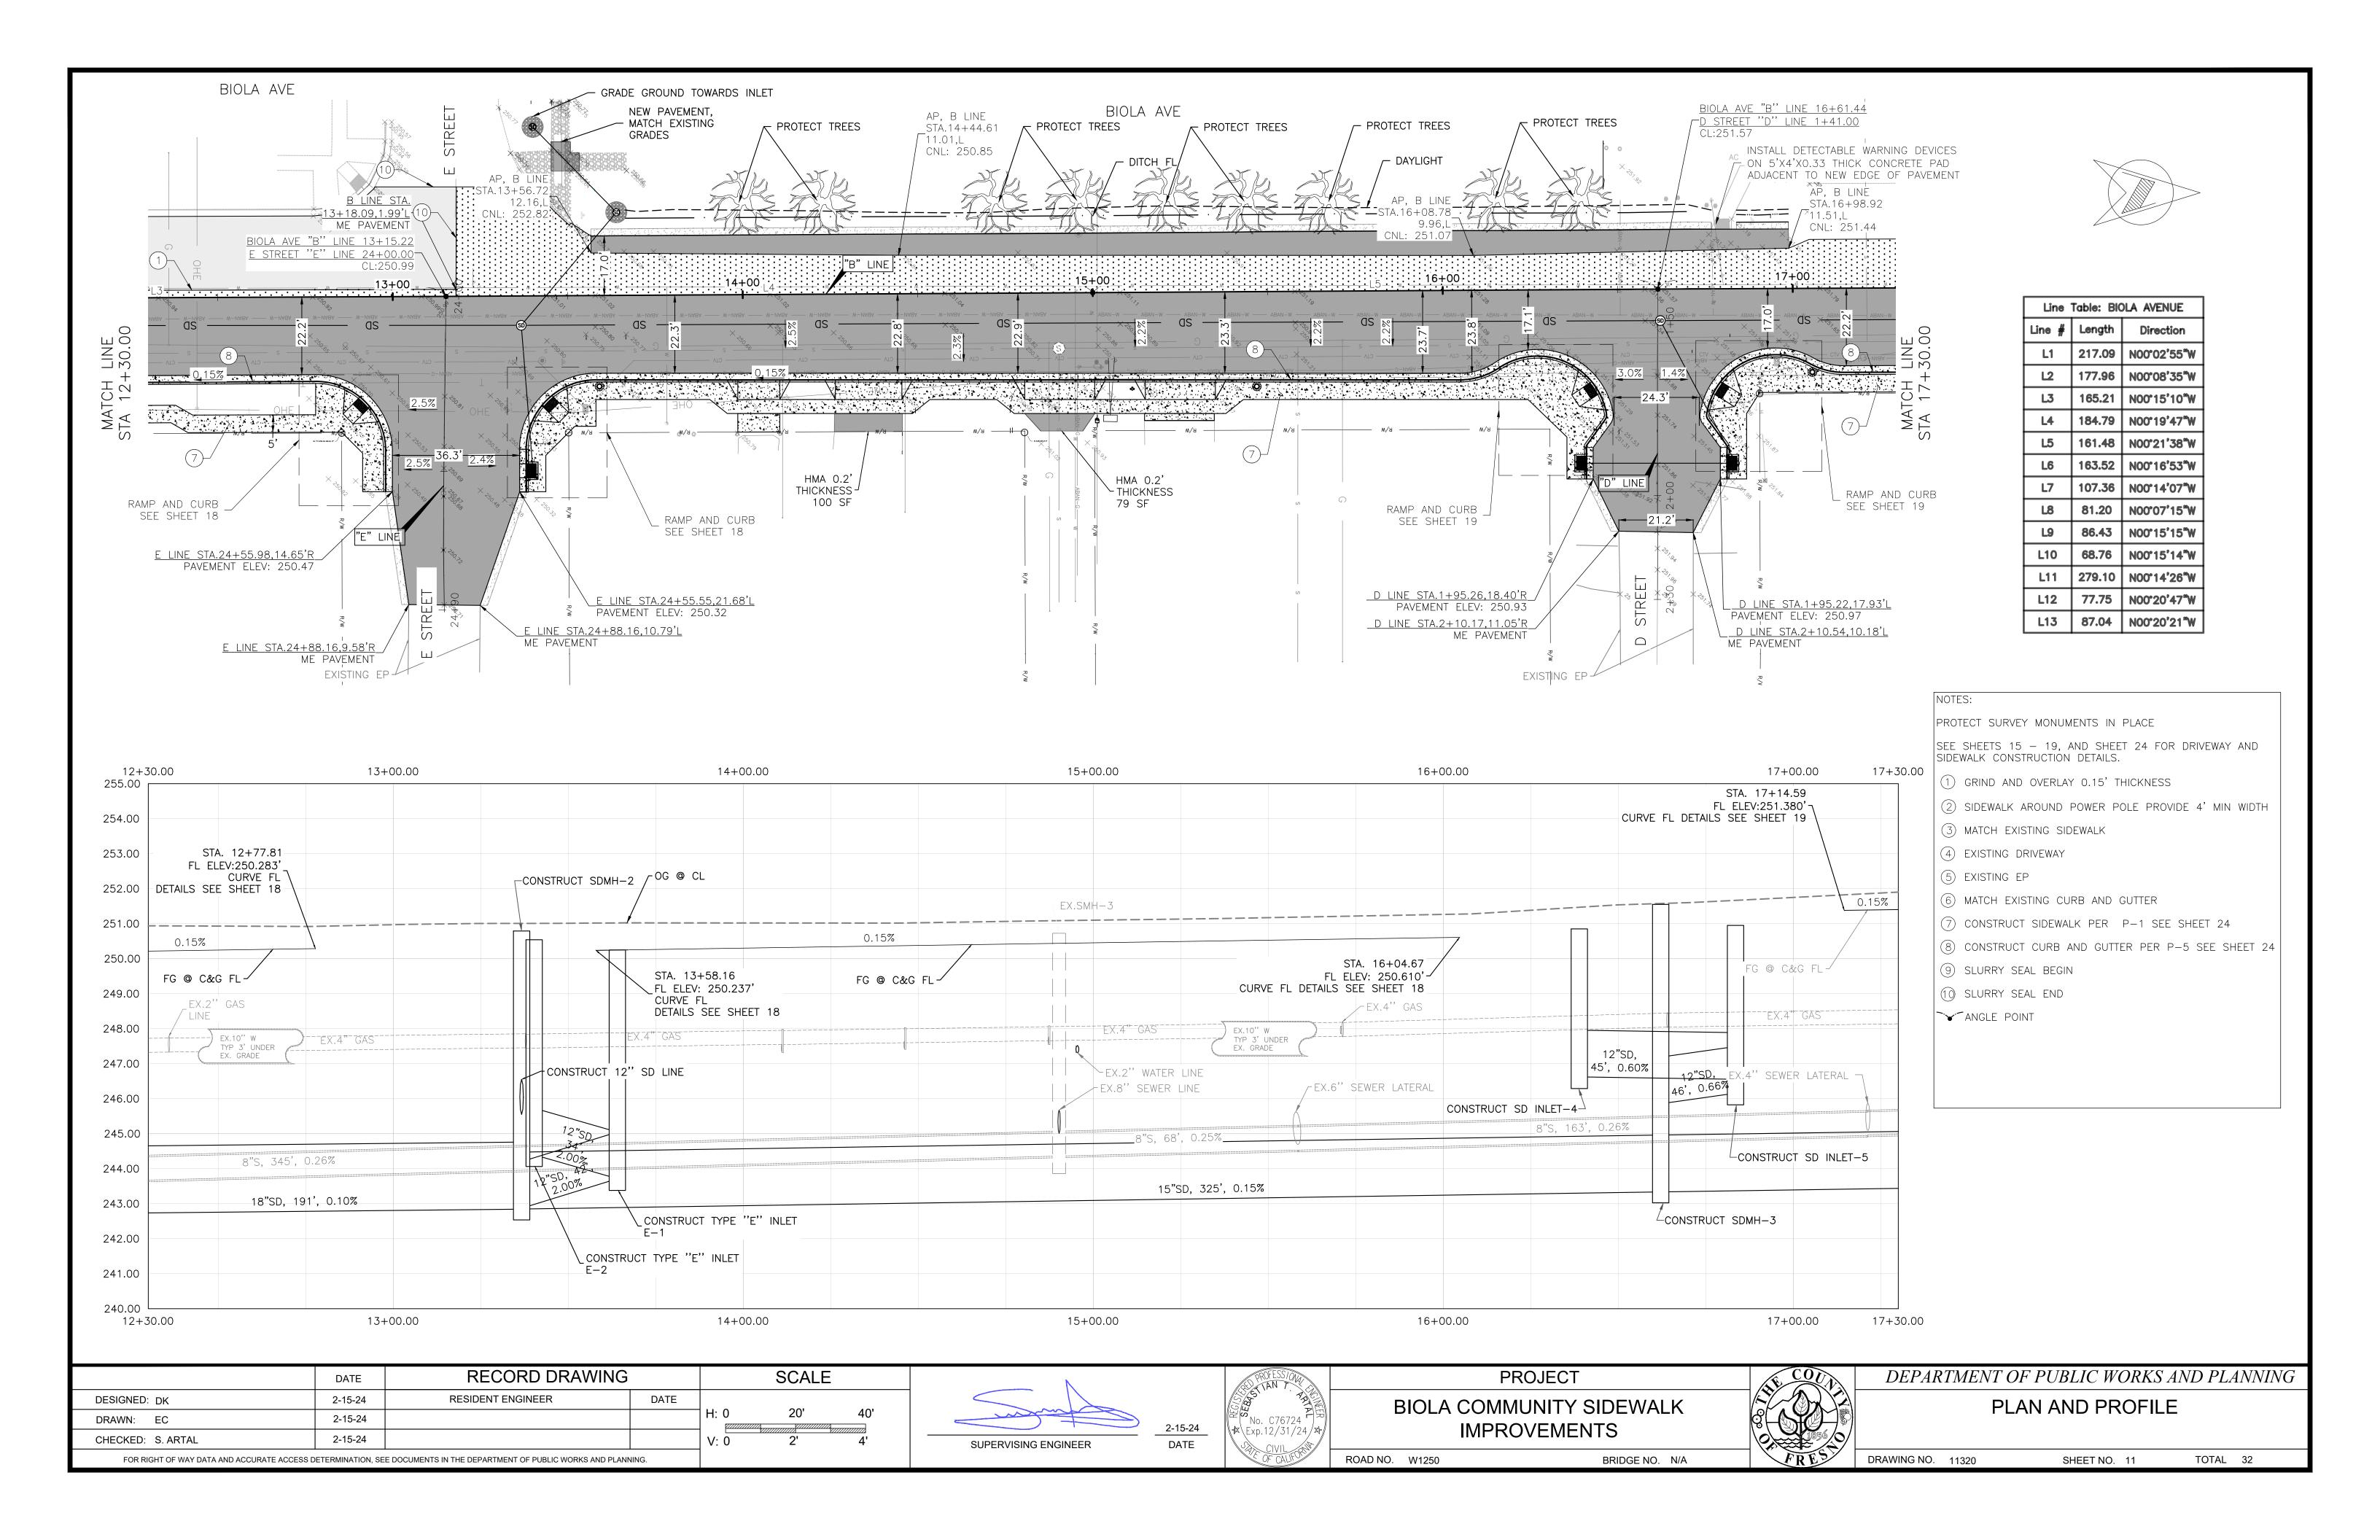

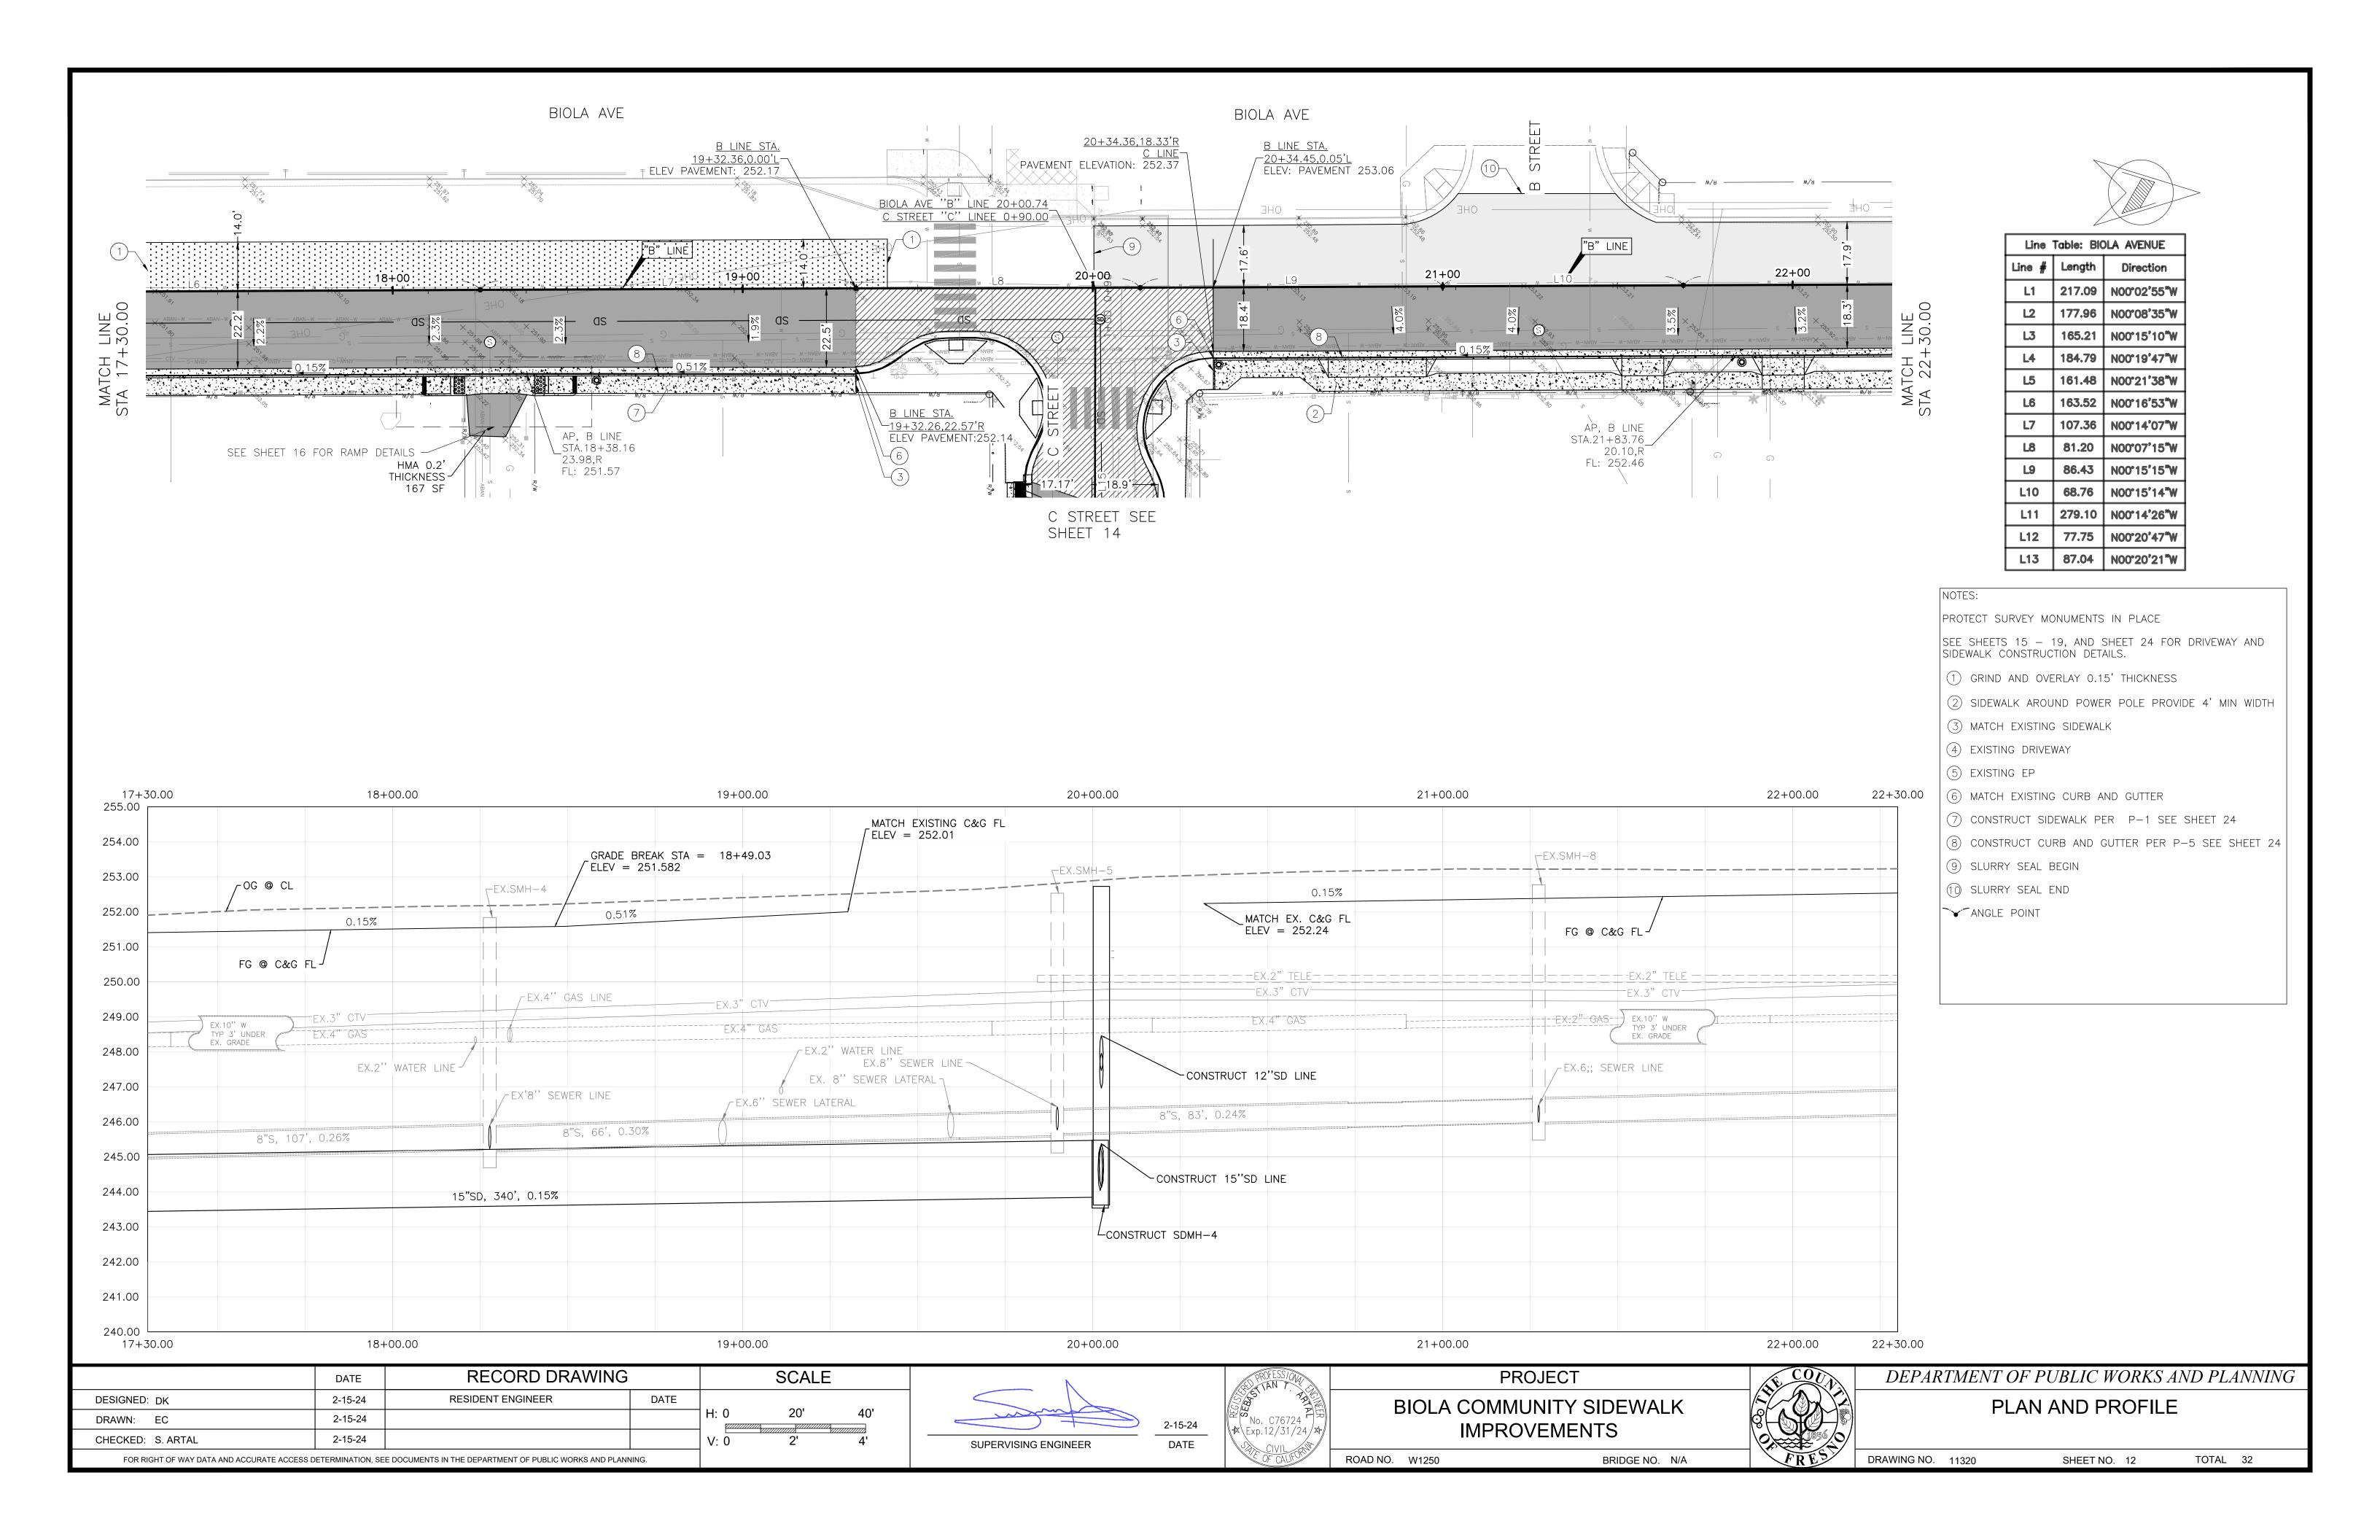


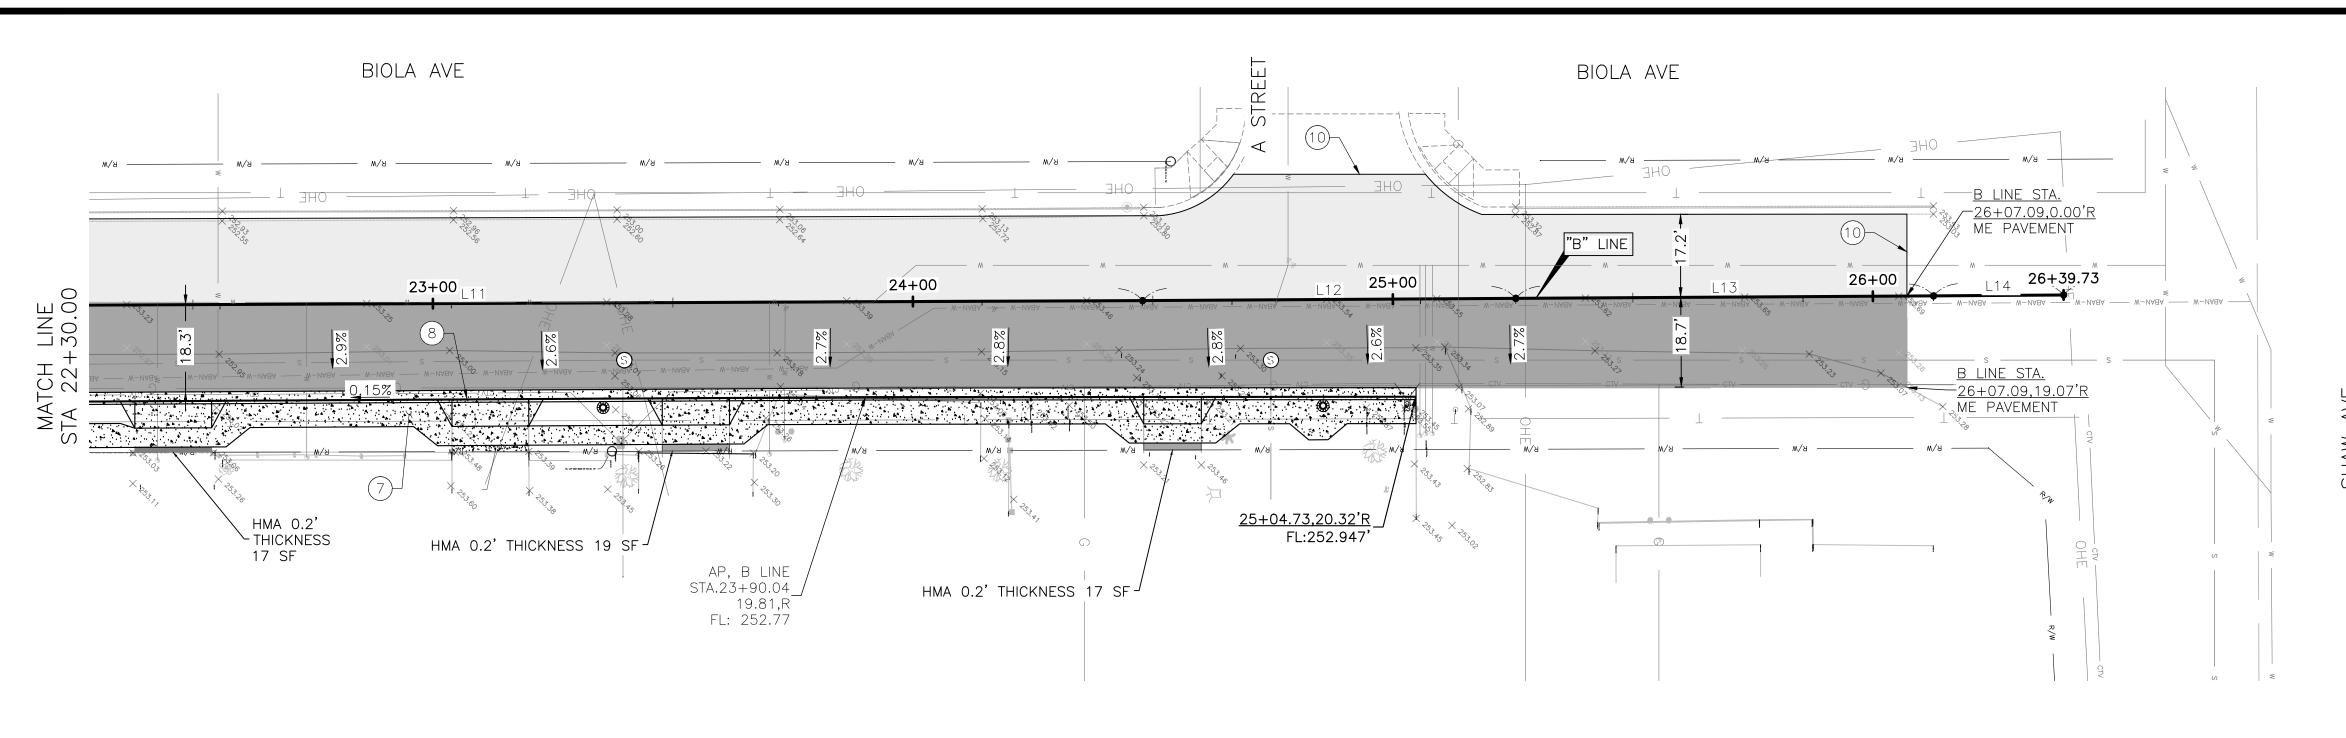

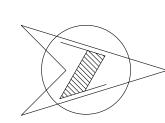

SHAW AVE

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	217.09	N00°02'55"W
L2	177.96	N00°08'35"W
L3	165.21	N00°15'10"W
L4	184.79	N00°19'47"W
L5	161.48	N00°21'38"W
L6	163.52	N00°16'53"W
L7	107.36	N00°14'07"W
L8	81.20	N00°07'15"W
L9	86.43	N00°15'15"W
L10	68.76	N00°15'14"W
L11	279.10	N00°14'26"W
L12	77.75	N00°20'47"W
L13	87.04	N00°20'21"W

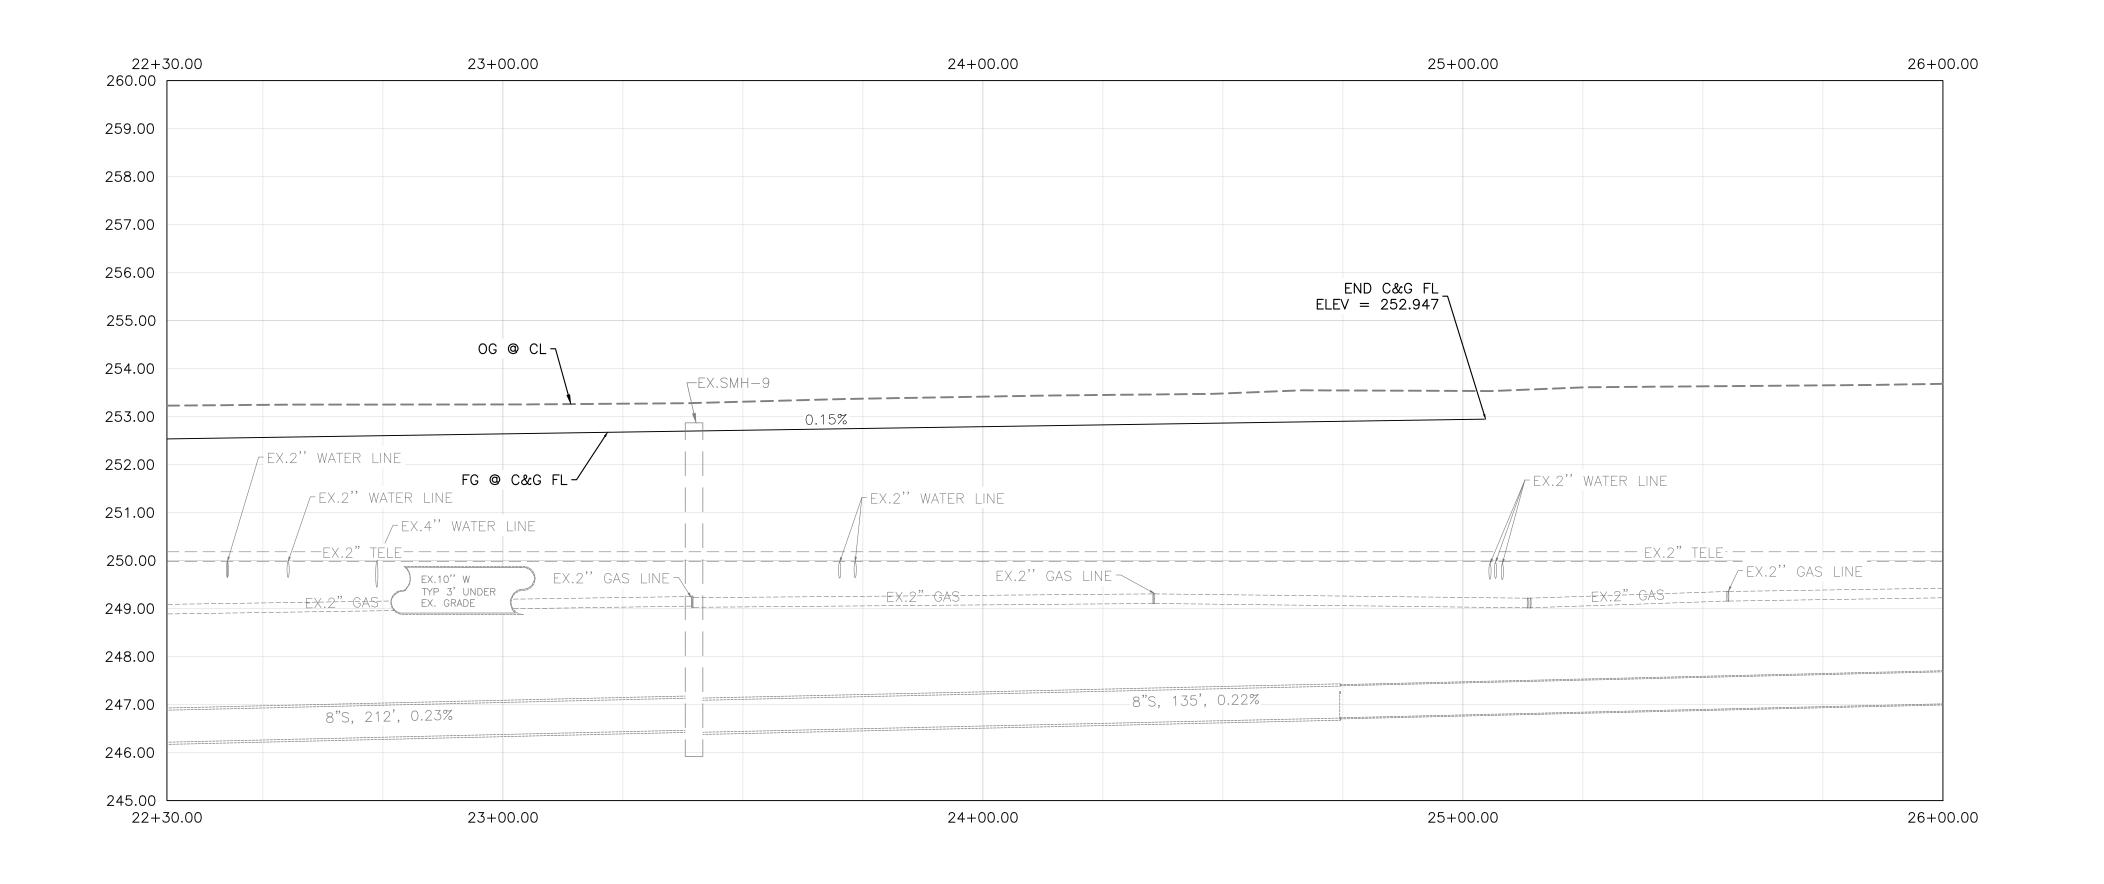


INOTES:

PROTECT SURVEY MONUMENTS IN PLACE

SEE SHEETS 15 — 19, AND SHEET 24 FOR DRIVEWAY AND SIDEWALK CONSTRUCTION DETAILS.

- (1) GRIND AND OVERLAY 0.15' THICKNESS
- 2 SIDEWALK AROUND POWER POLE PROVIDE 4' MIN WIDTH
- 3 MATCH EXISTING SIDEWALK
- 4 EXISTING DRIVEWAY
- 5 EXISTING EP
- (6) MATCH EXISTING CURB AND GUTTER
- 7 CONSTRUCT SIDEWALK PER P-1 SEE SHEET 24
- 8 CONSTRUCT CURB AND GUTTER PER P-5 SEE SHEET 24
- (9) SLURRY SEAL BEGIN
- (10) SLURRY SEAL END

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CHECKED: S. ARTAL	2-15-24			V: 0	2'	4'
FOR RIGHT OF WAY DATA AND ACCURATE ACCESS DETERMINATION. SEE DOCUMENTS IN THE DEPARTMENT OF PUBLIC WORKS AND PLANNING						

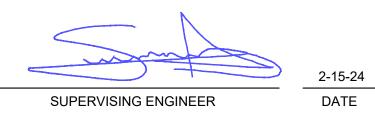

	PROFESS/ONAL TAN T
	SEBASS
_	No. C76724 √ × Exp.12/31/24/ ×
	CIVIL OF CALIFORNIA

ROAD NO. W1250

PROJECT	
BIOLA COMMUNITY SIDEWALK	
IMPROVEMENTS	


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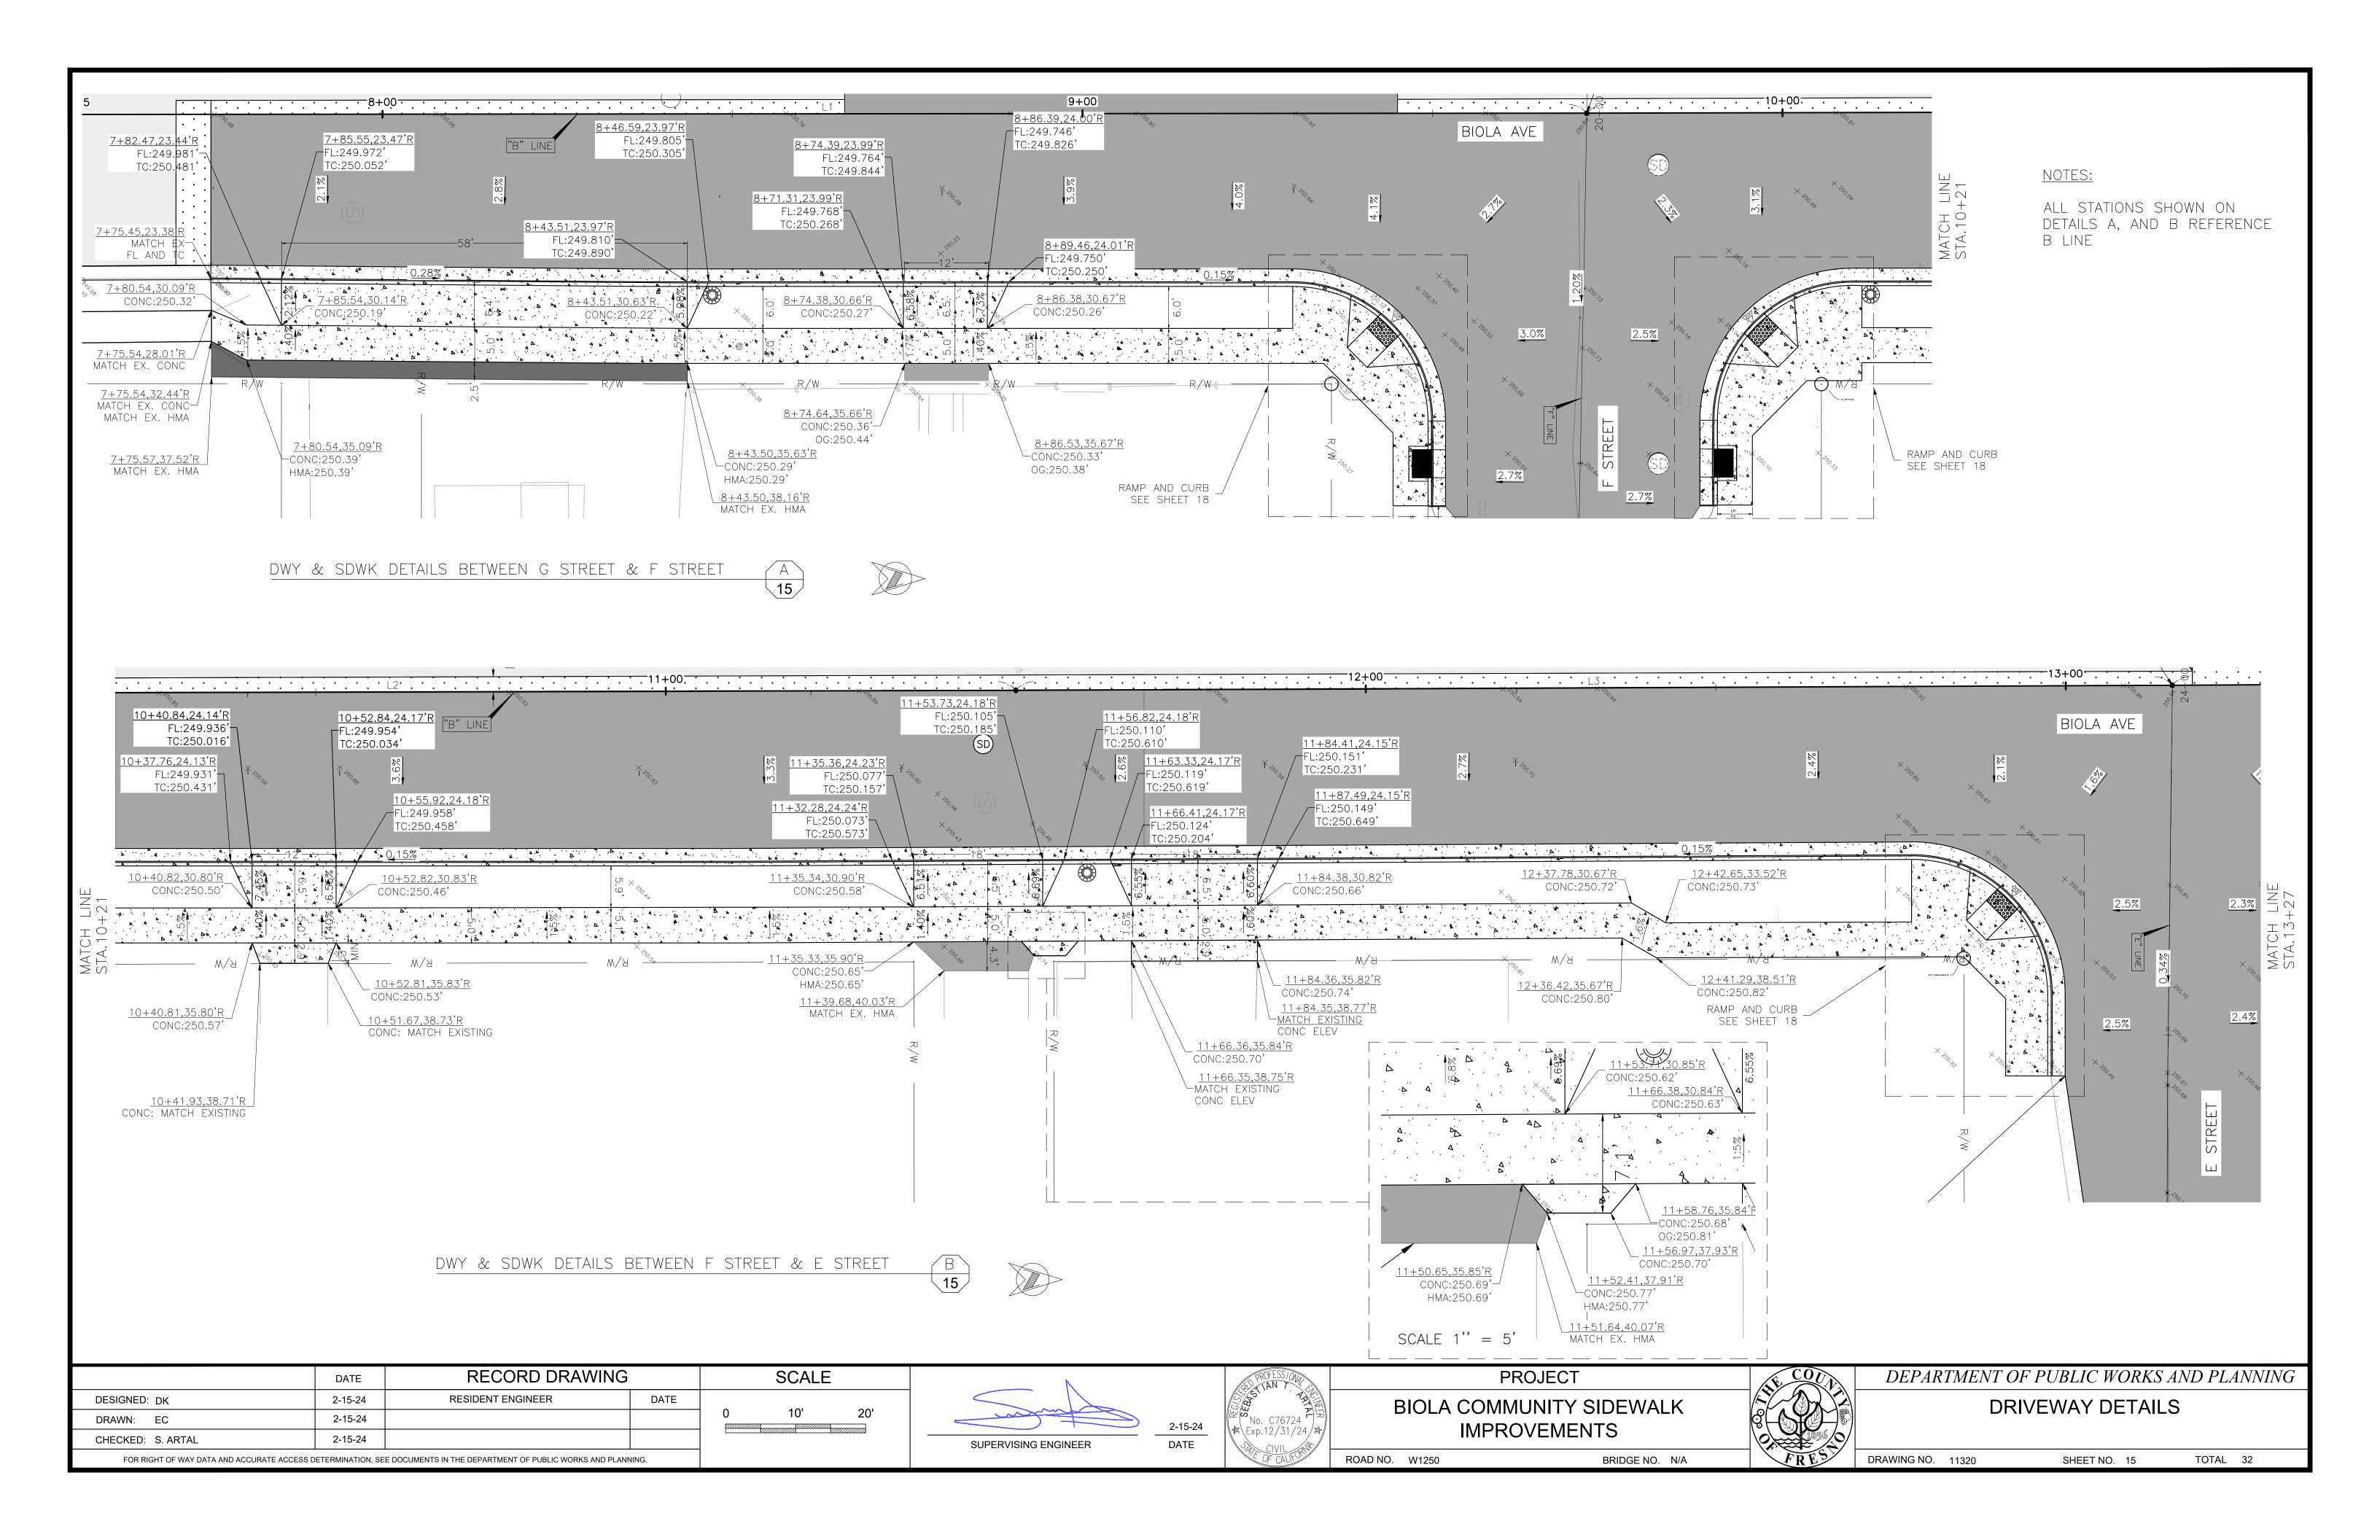



DEPARTMENT OF PUBLIC WORKS AND PLANNING


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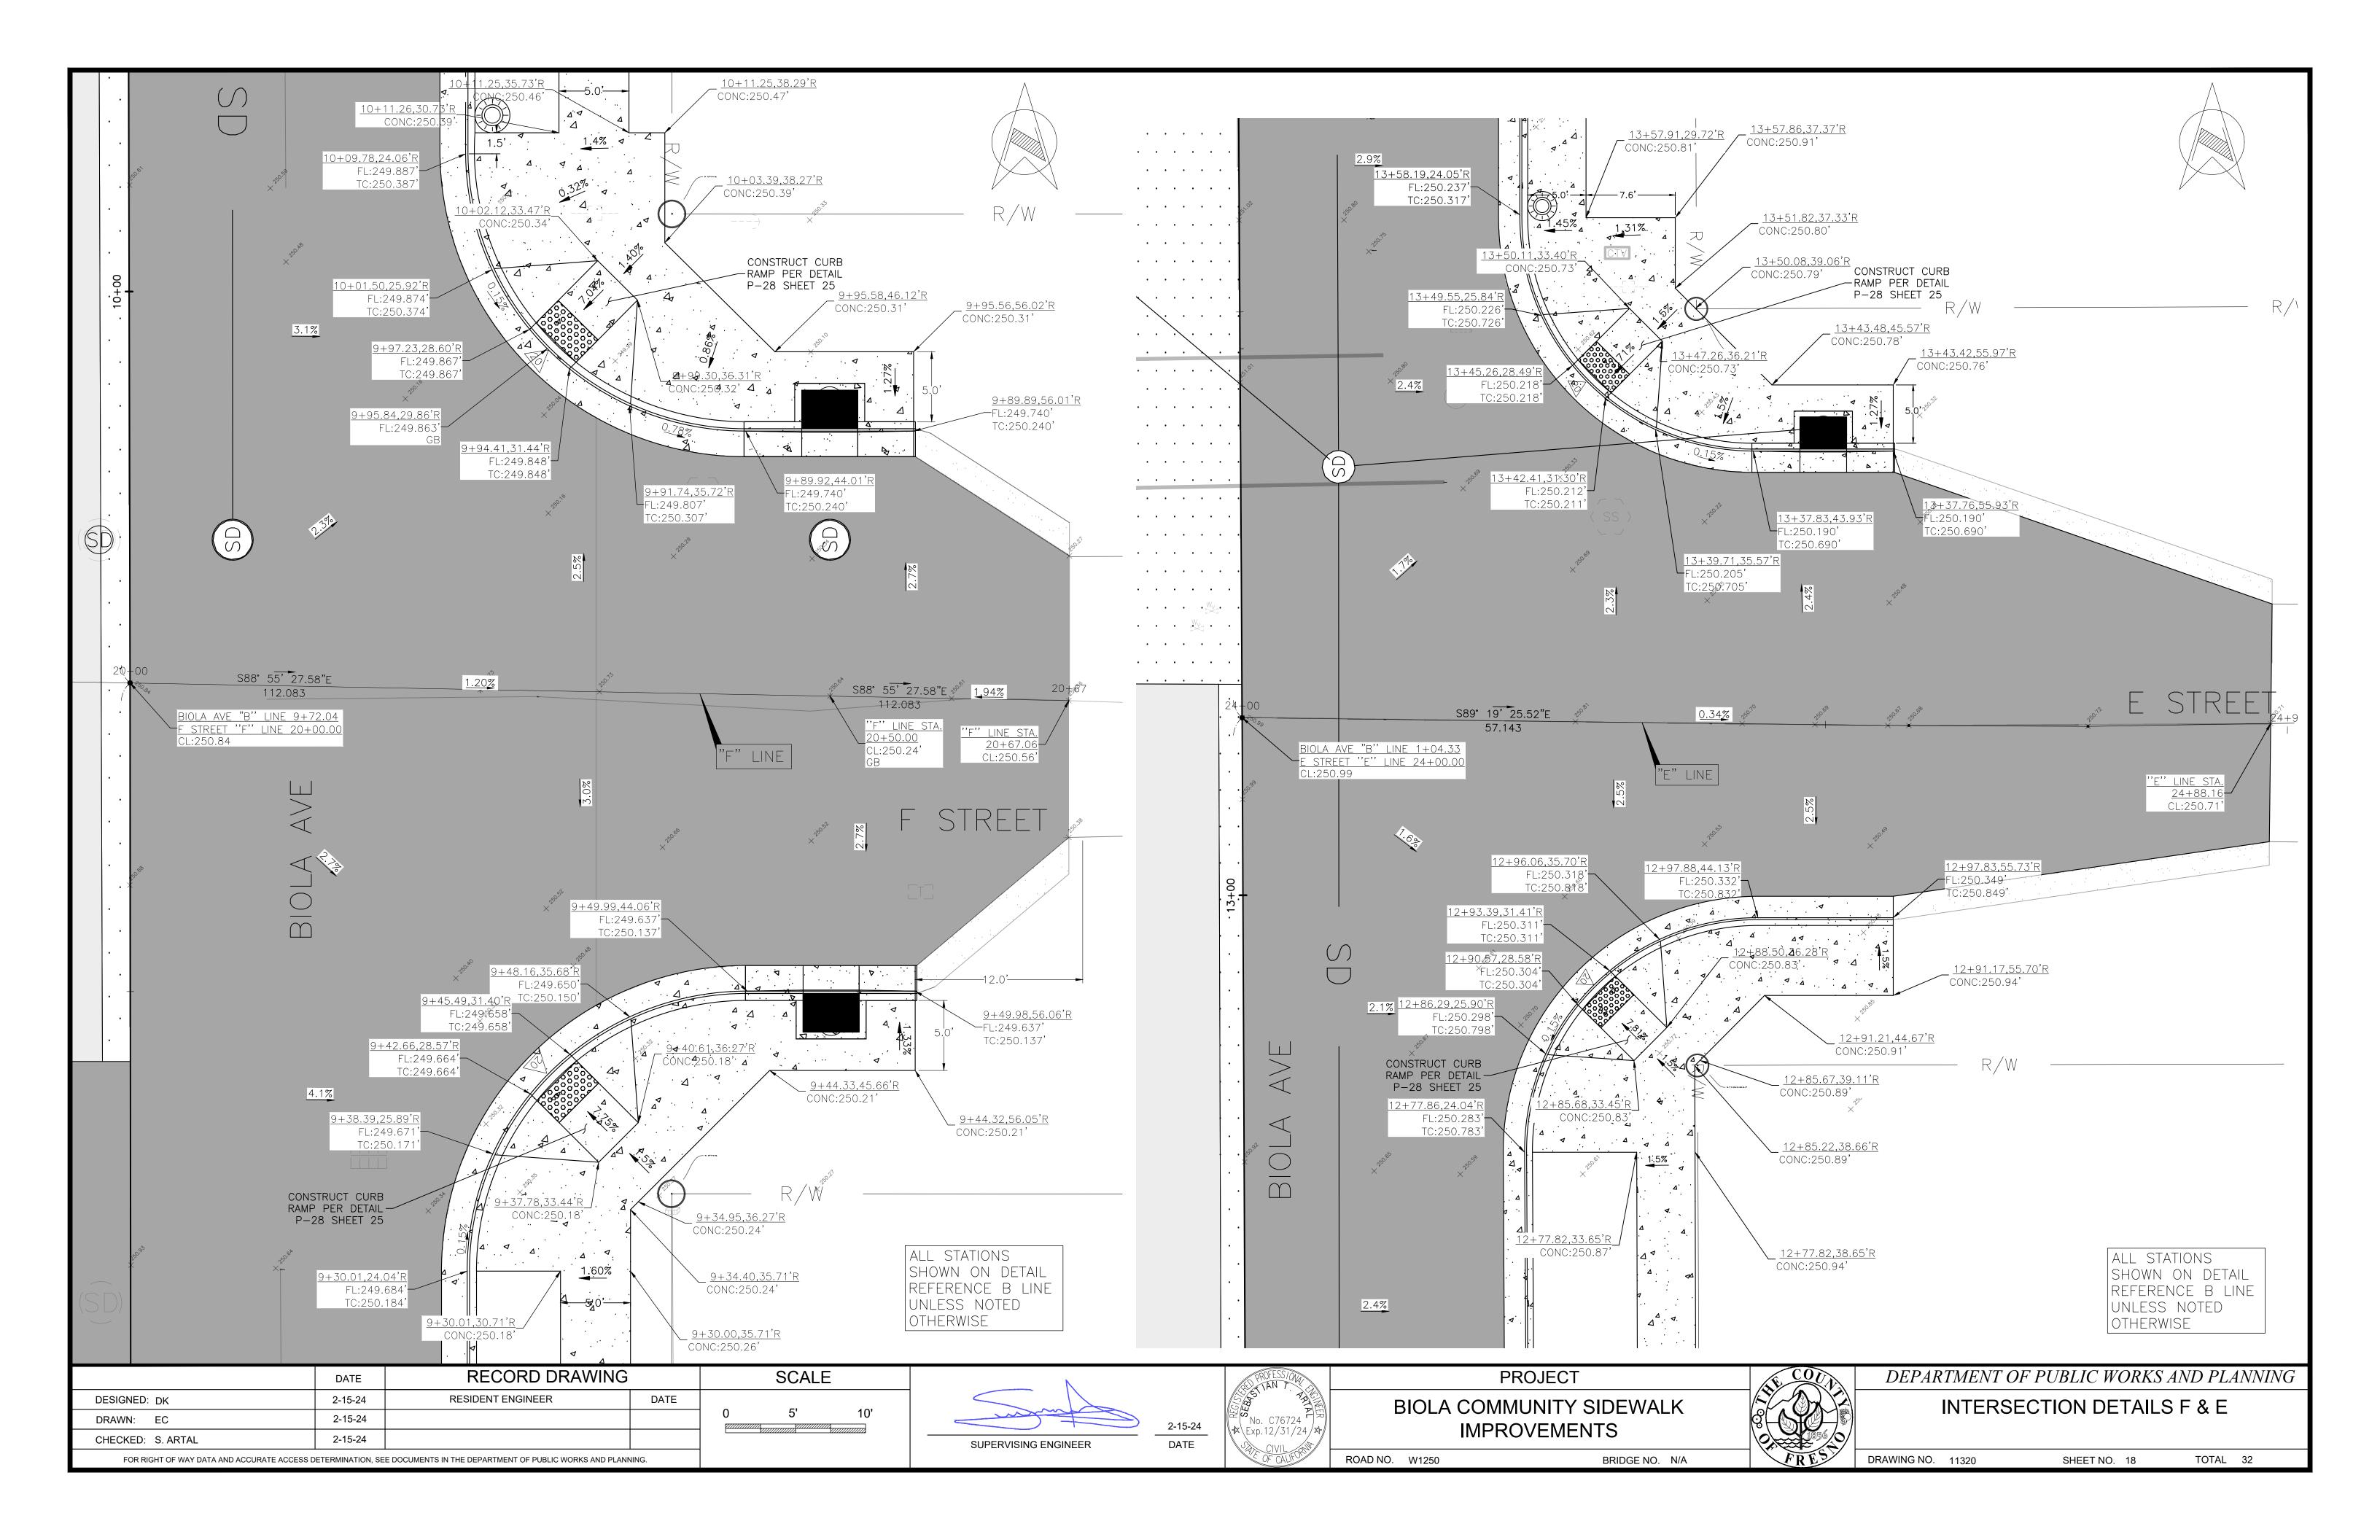
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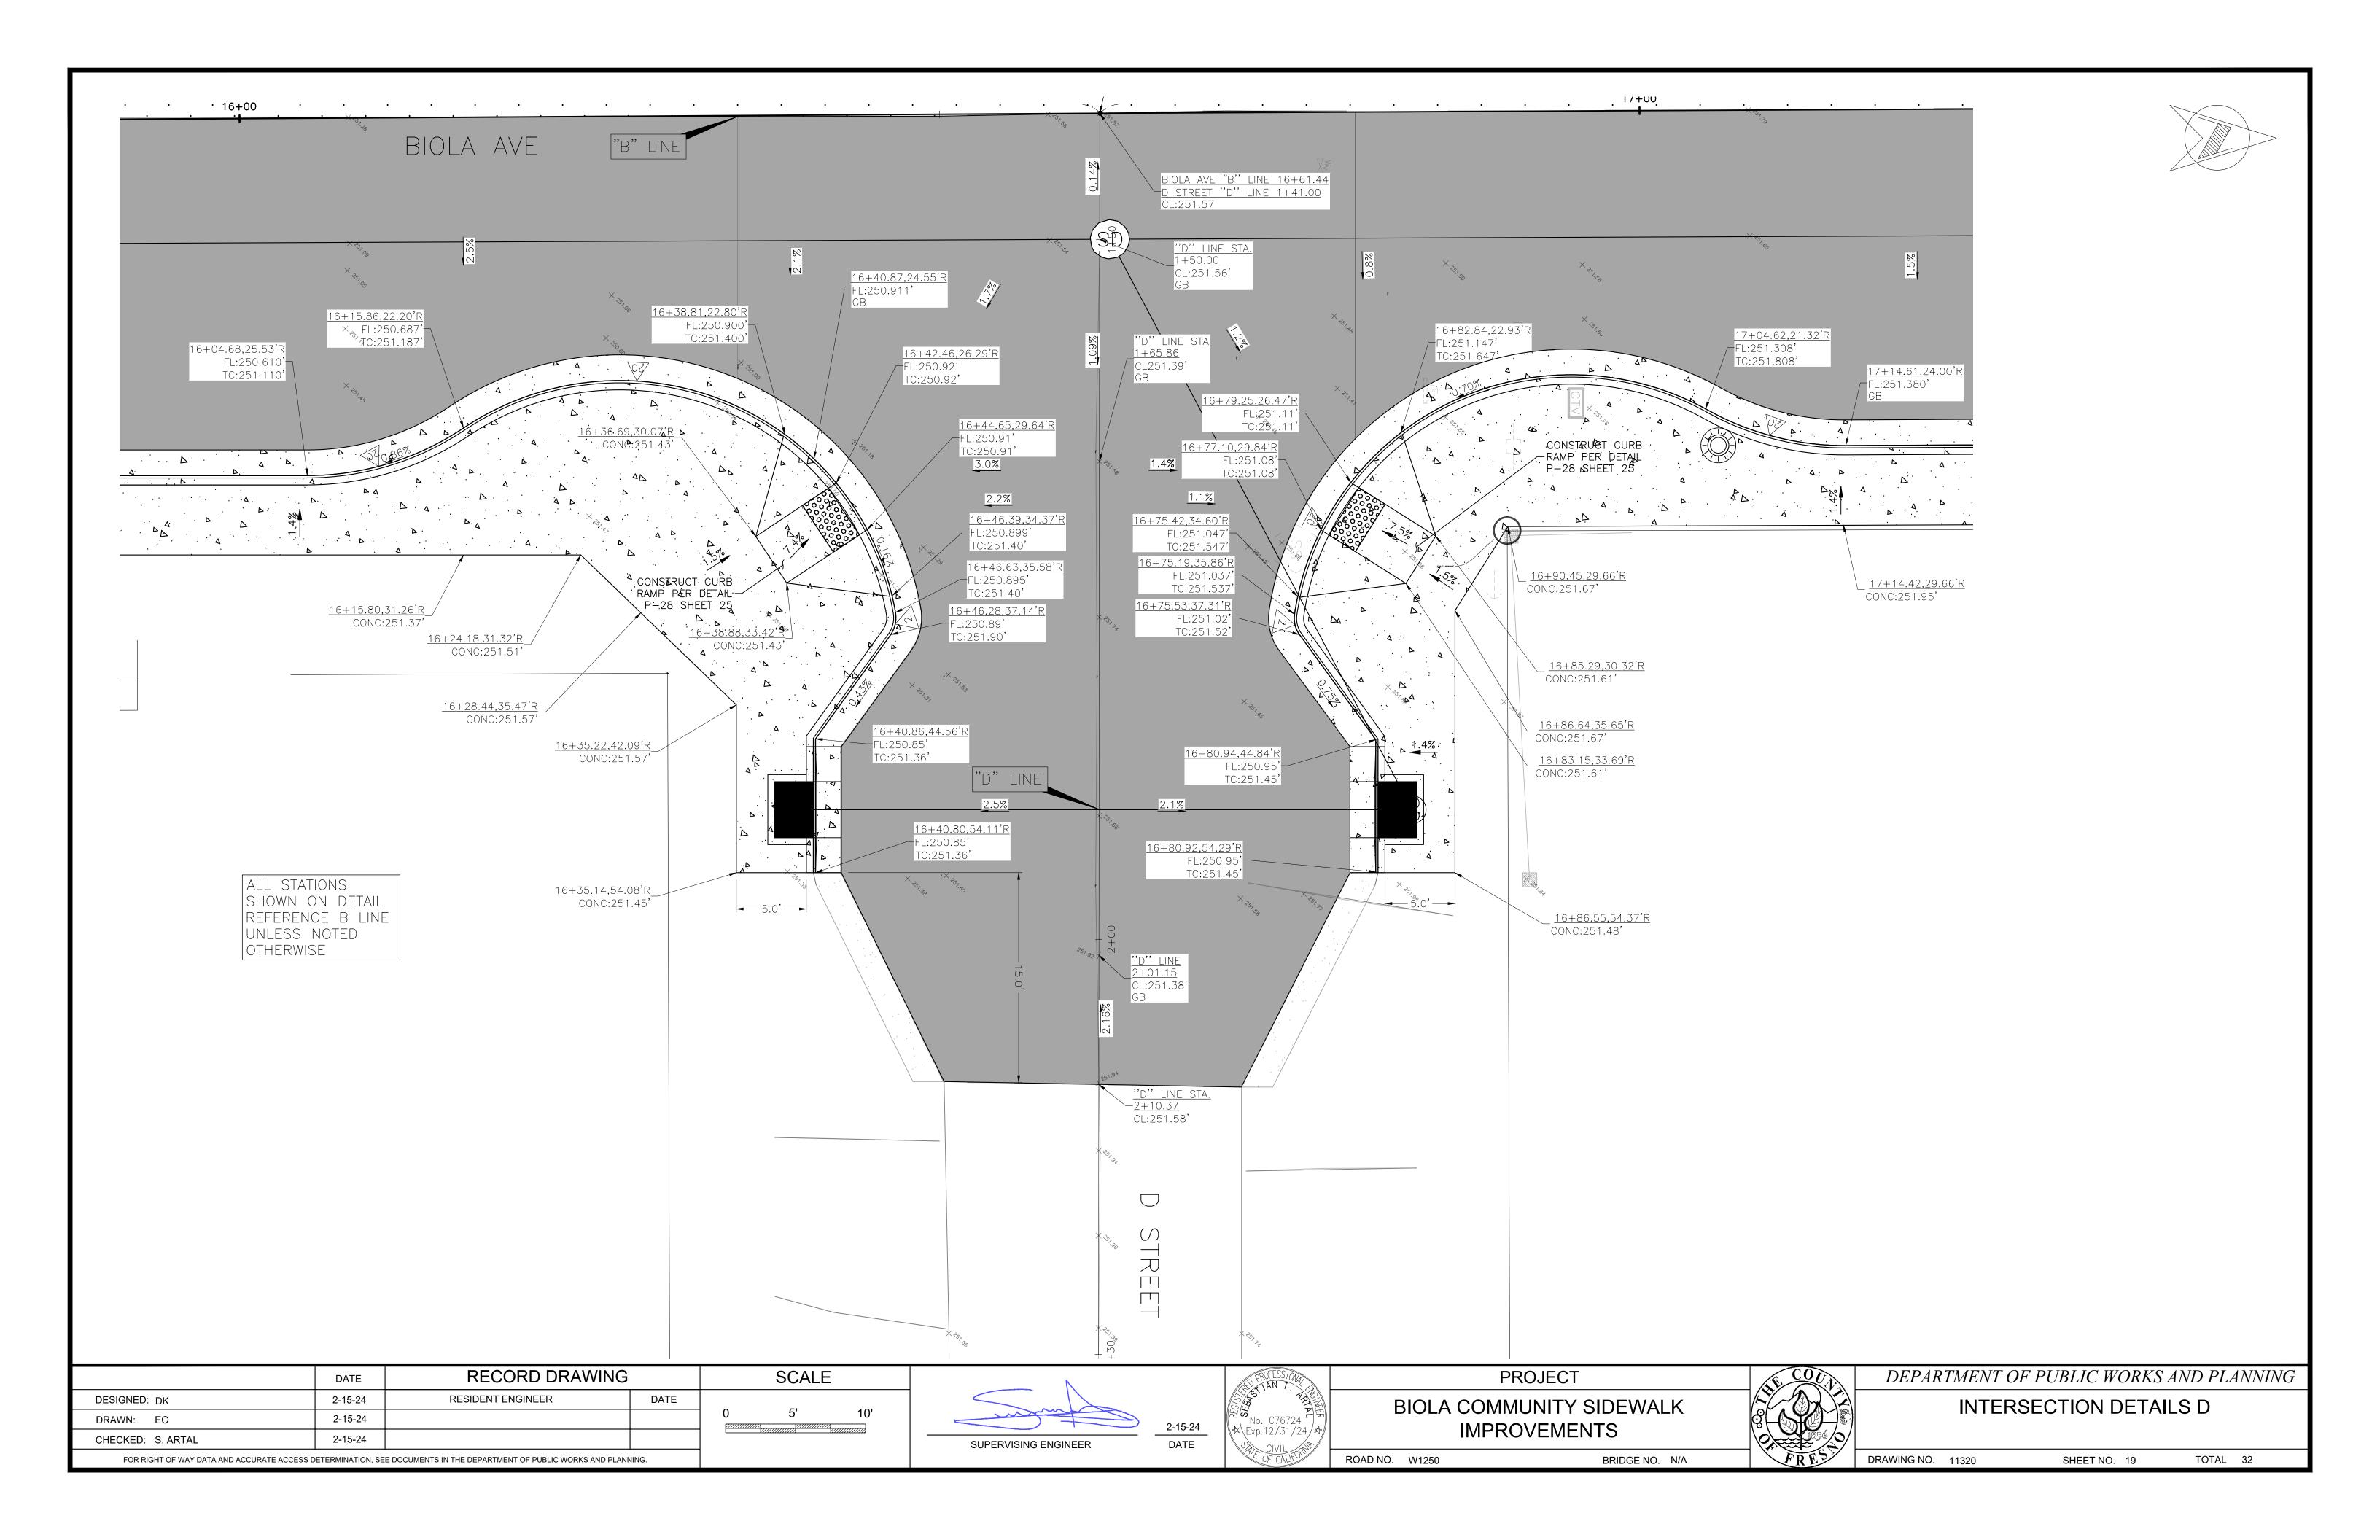








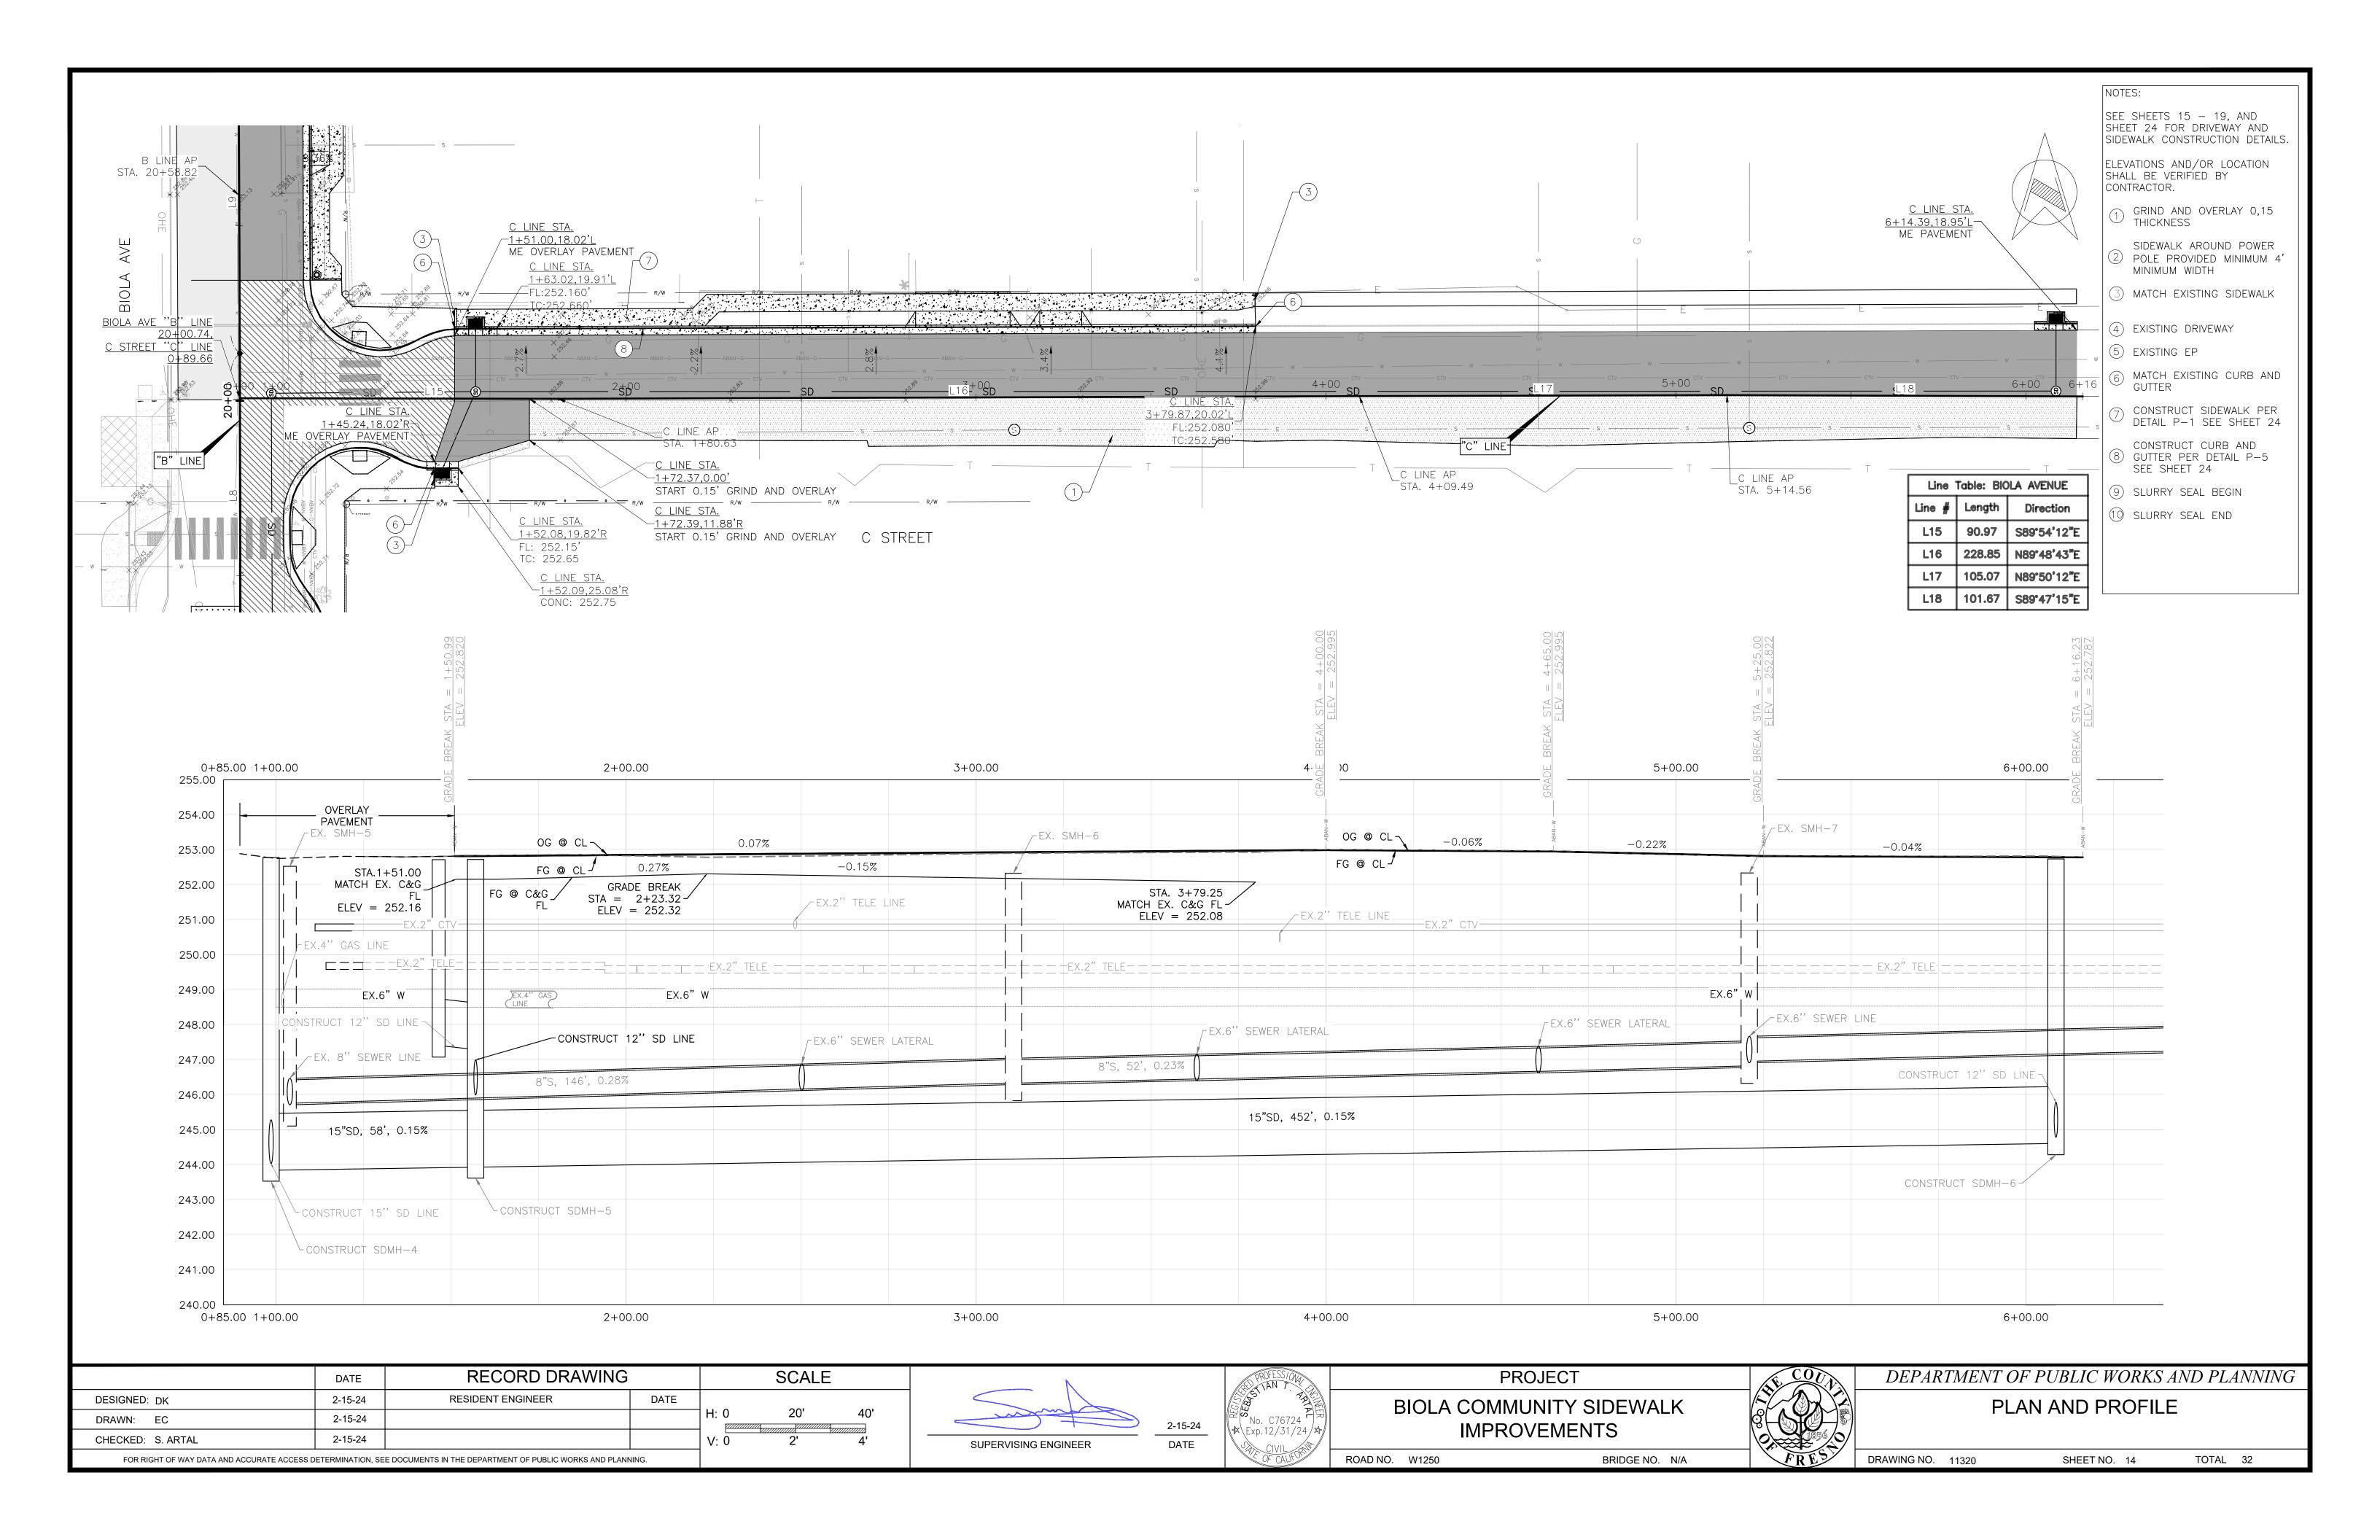


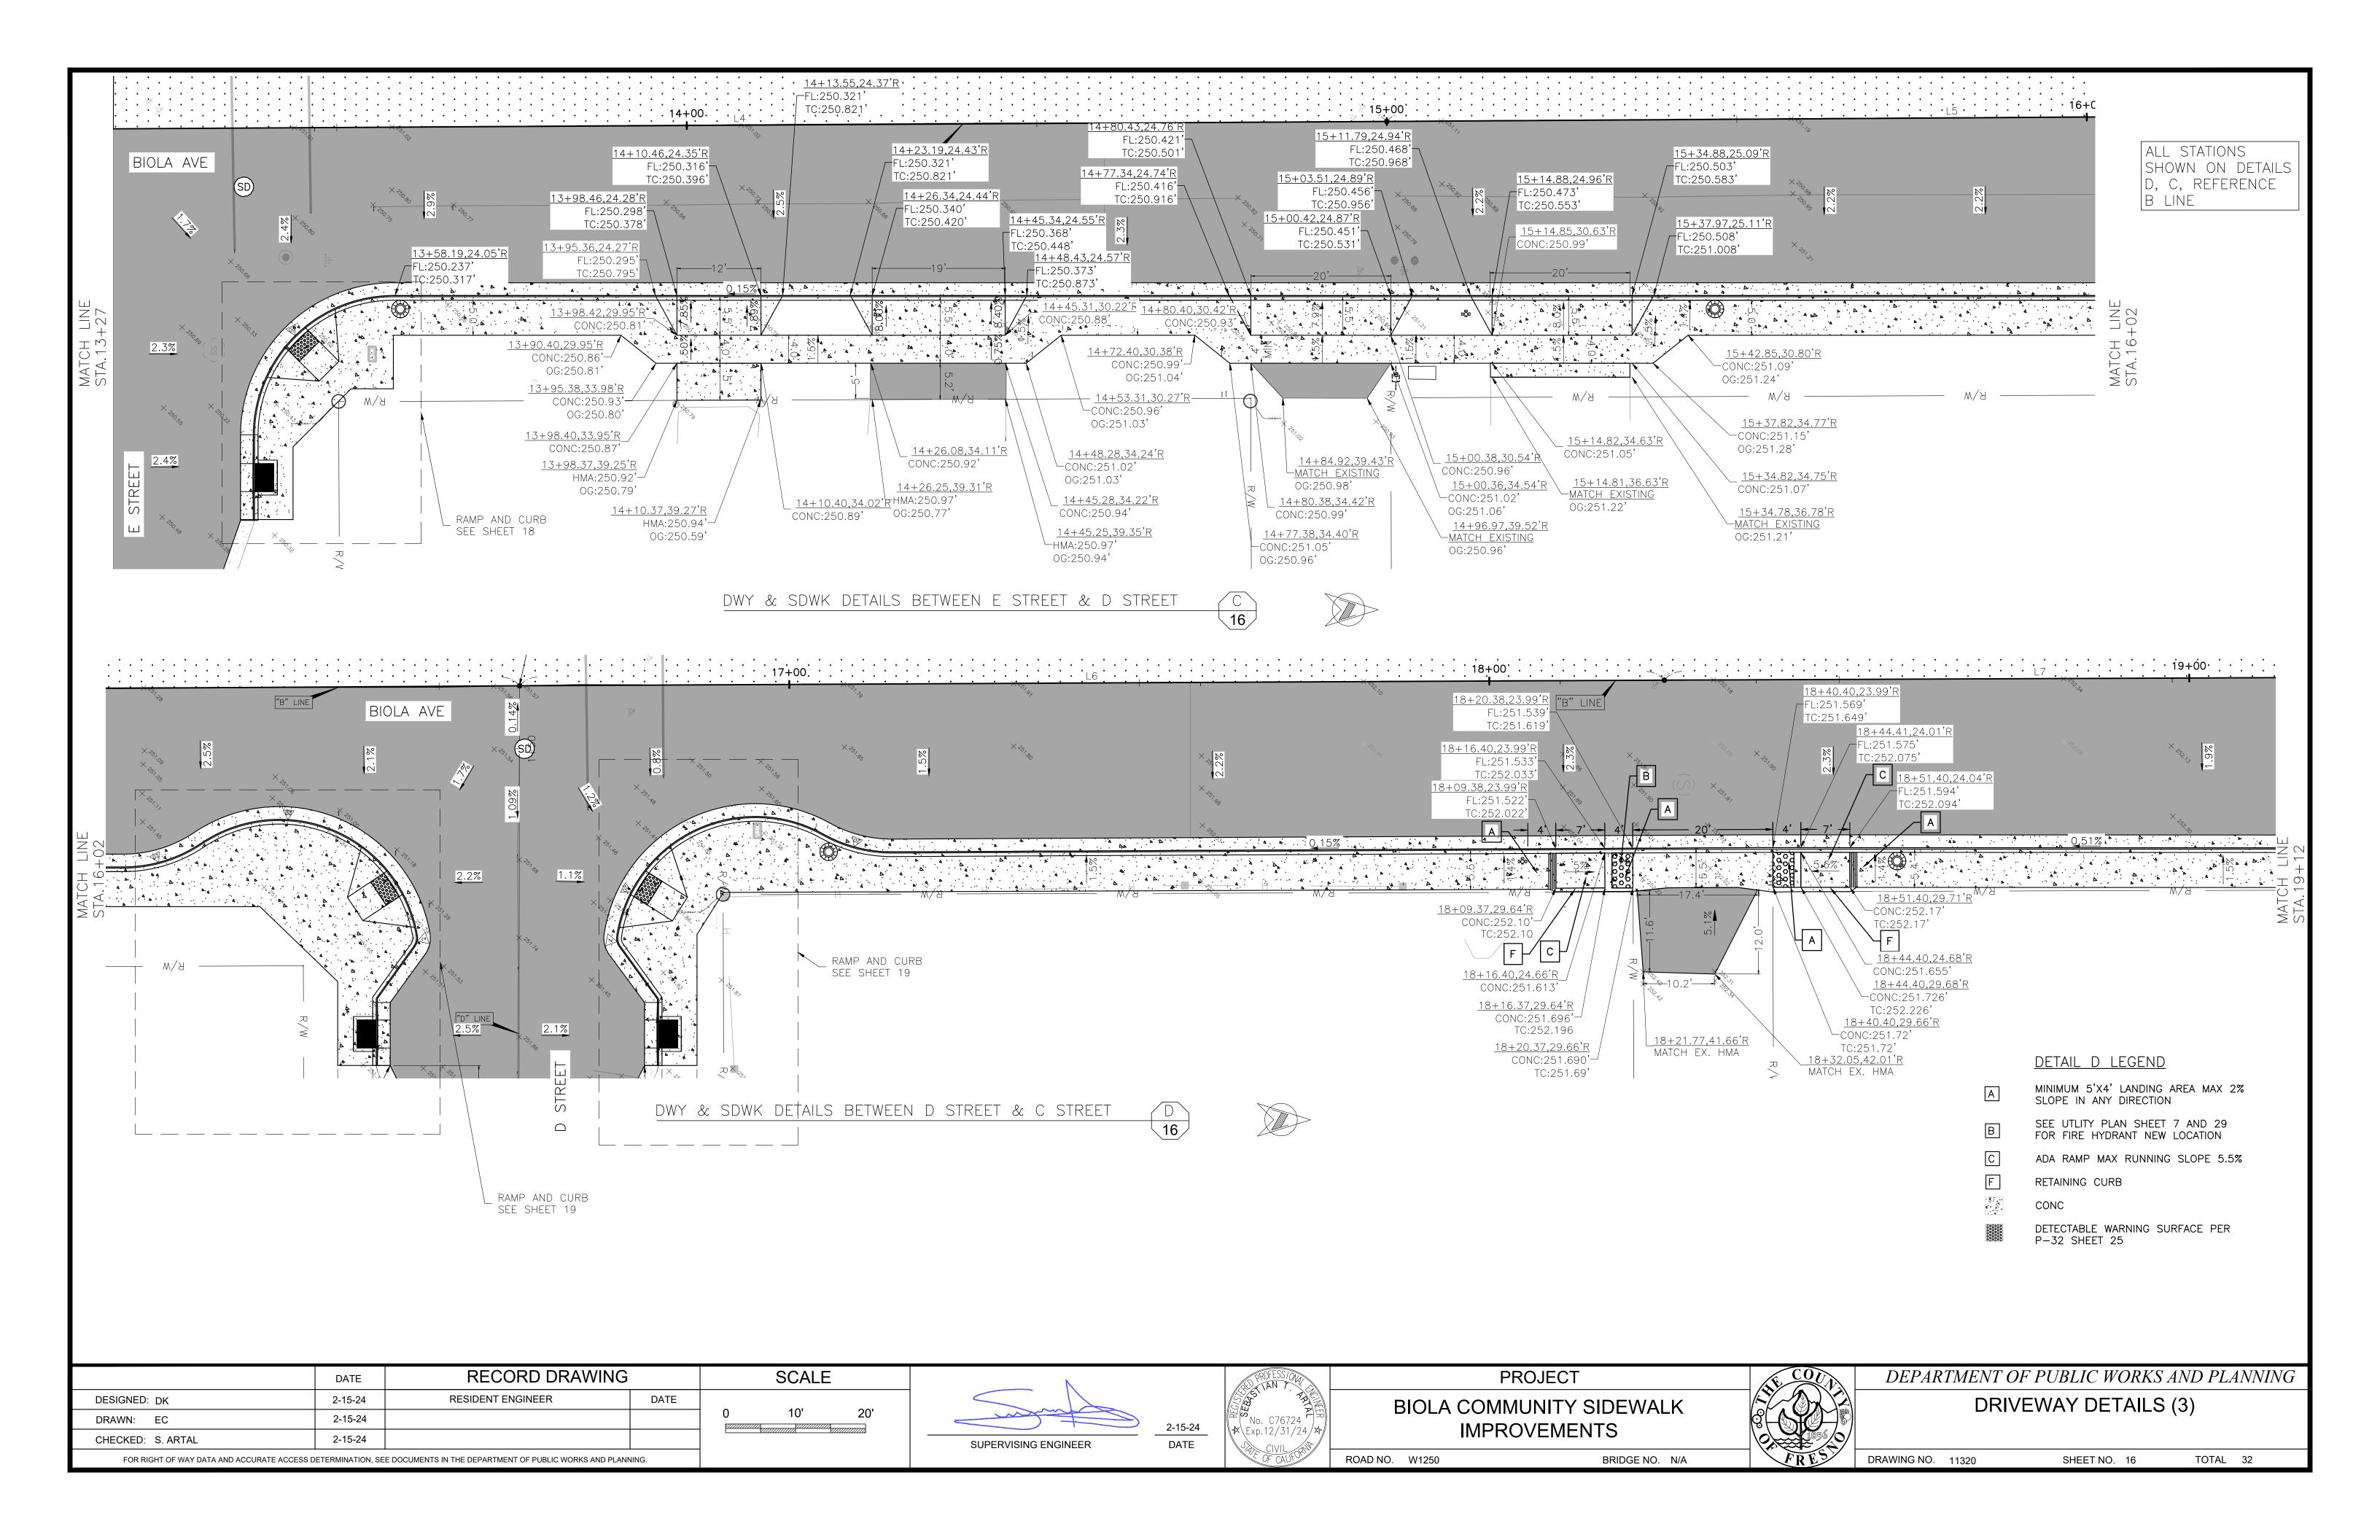


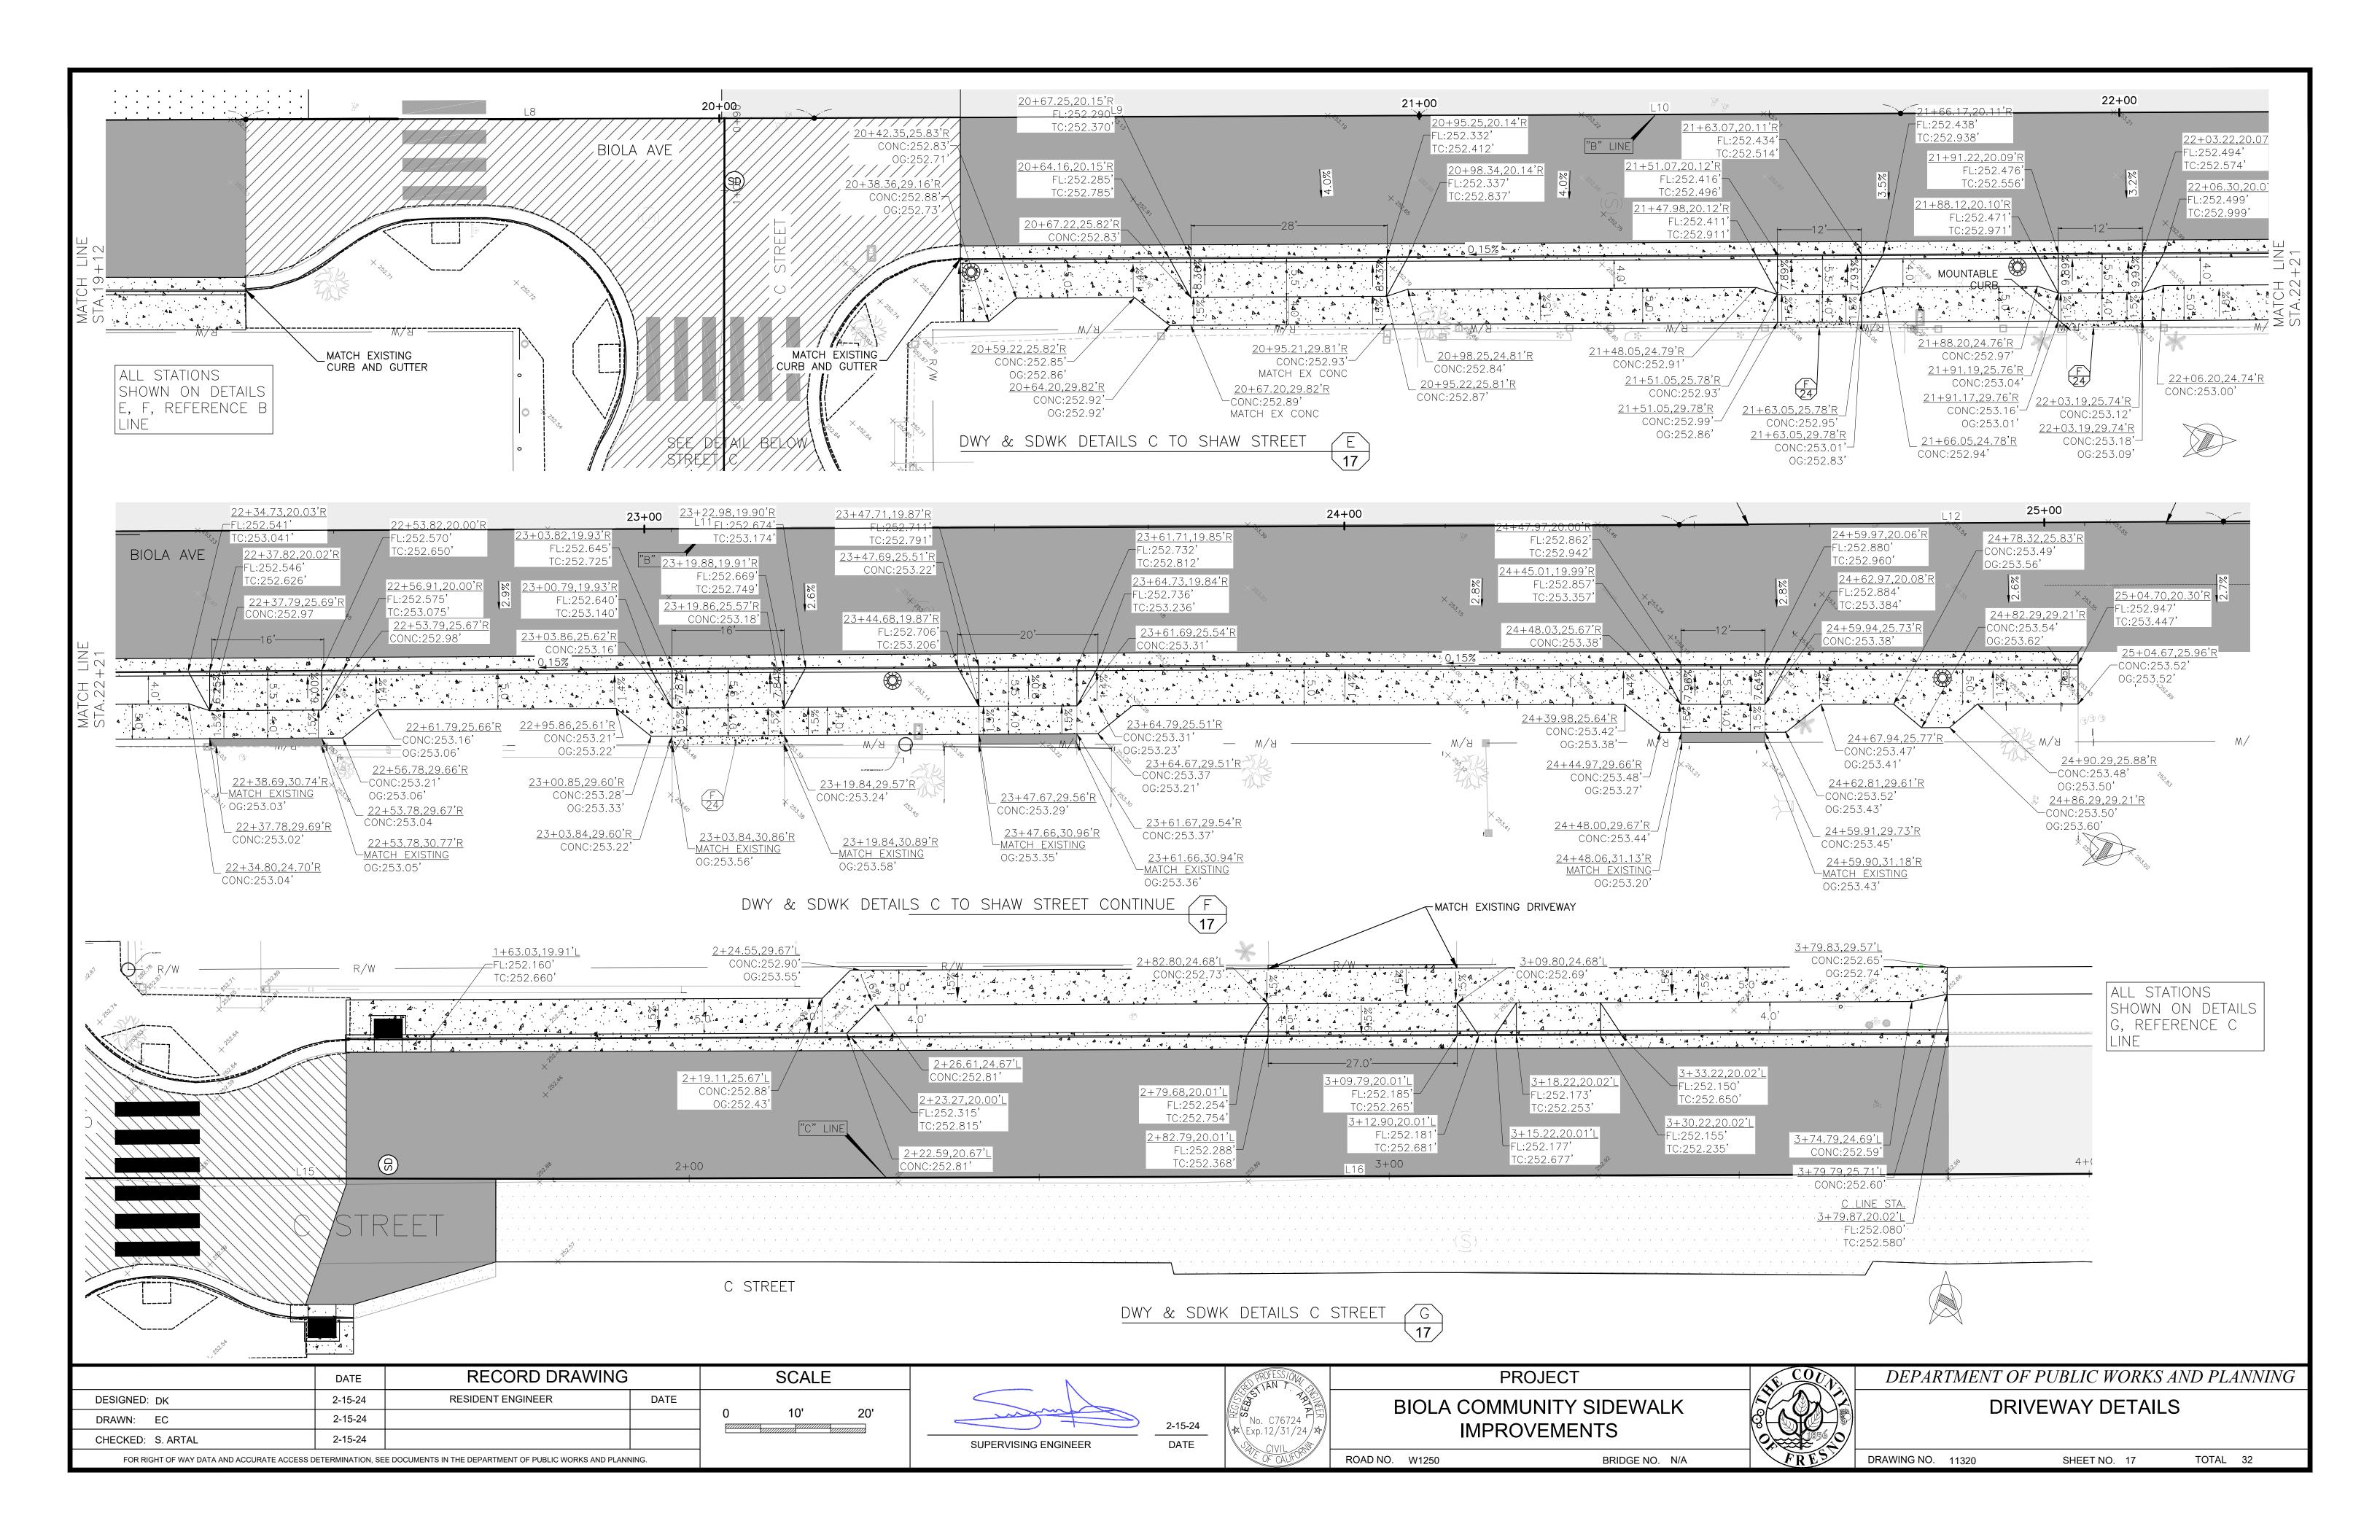


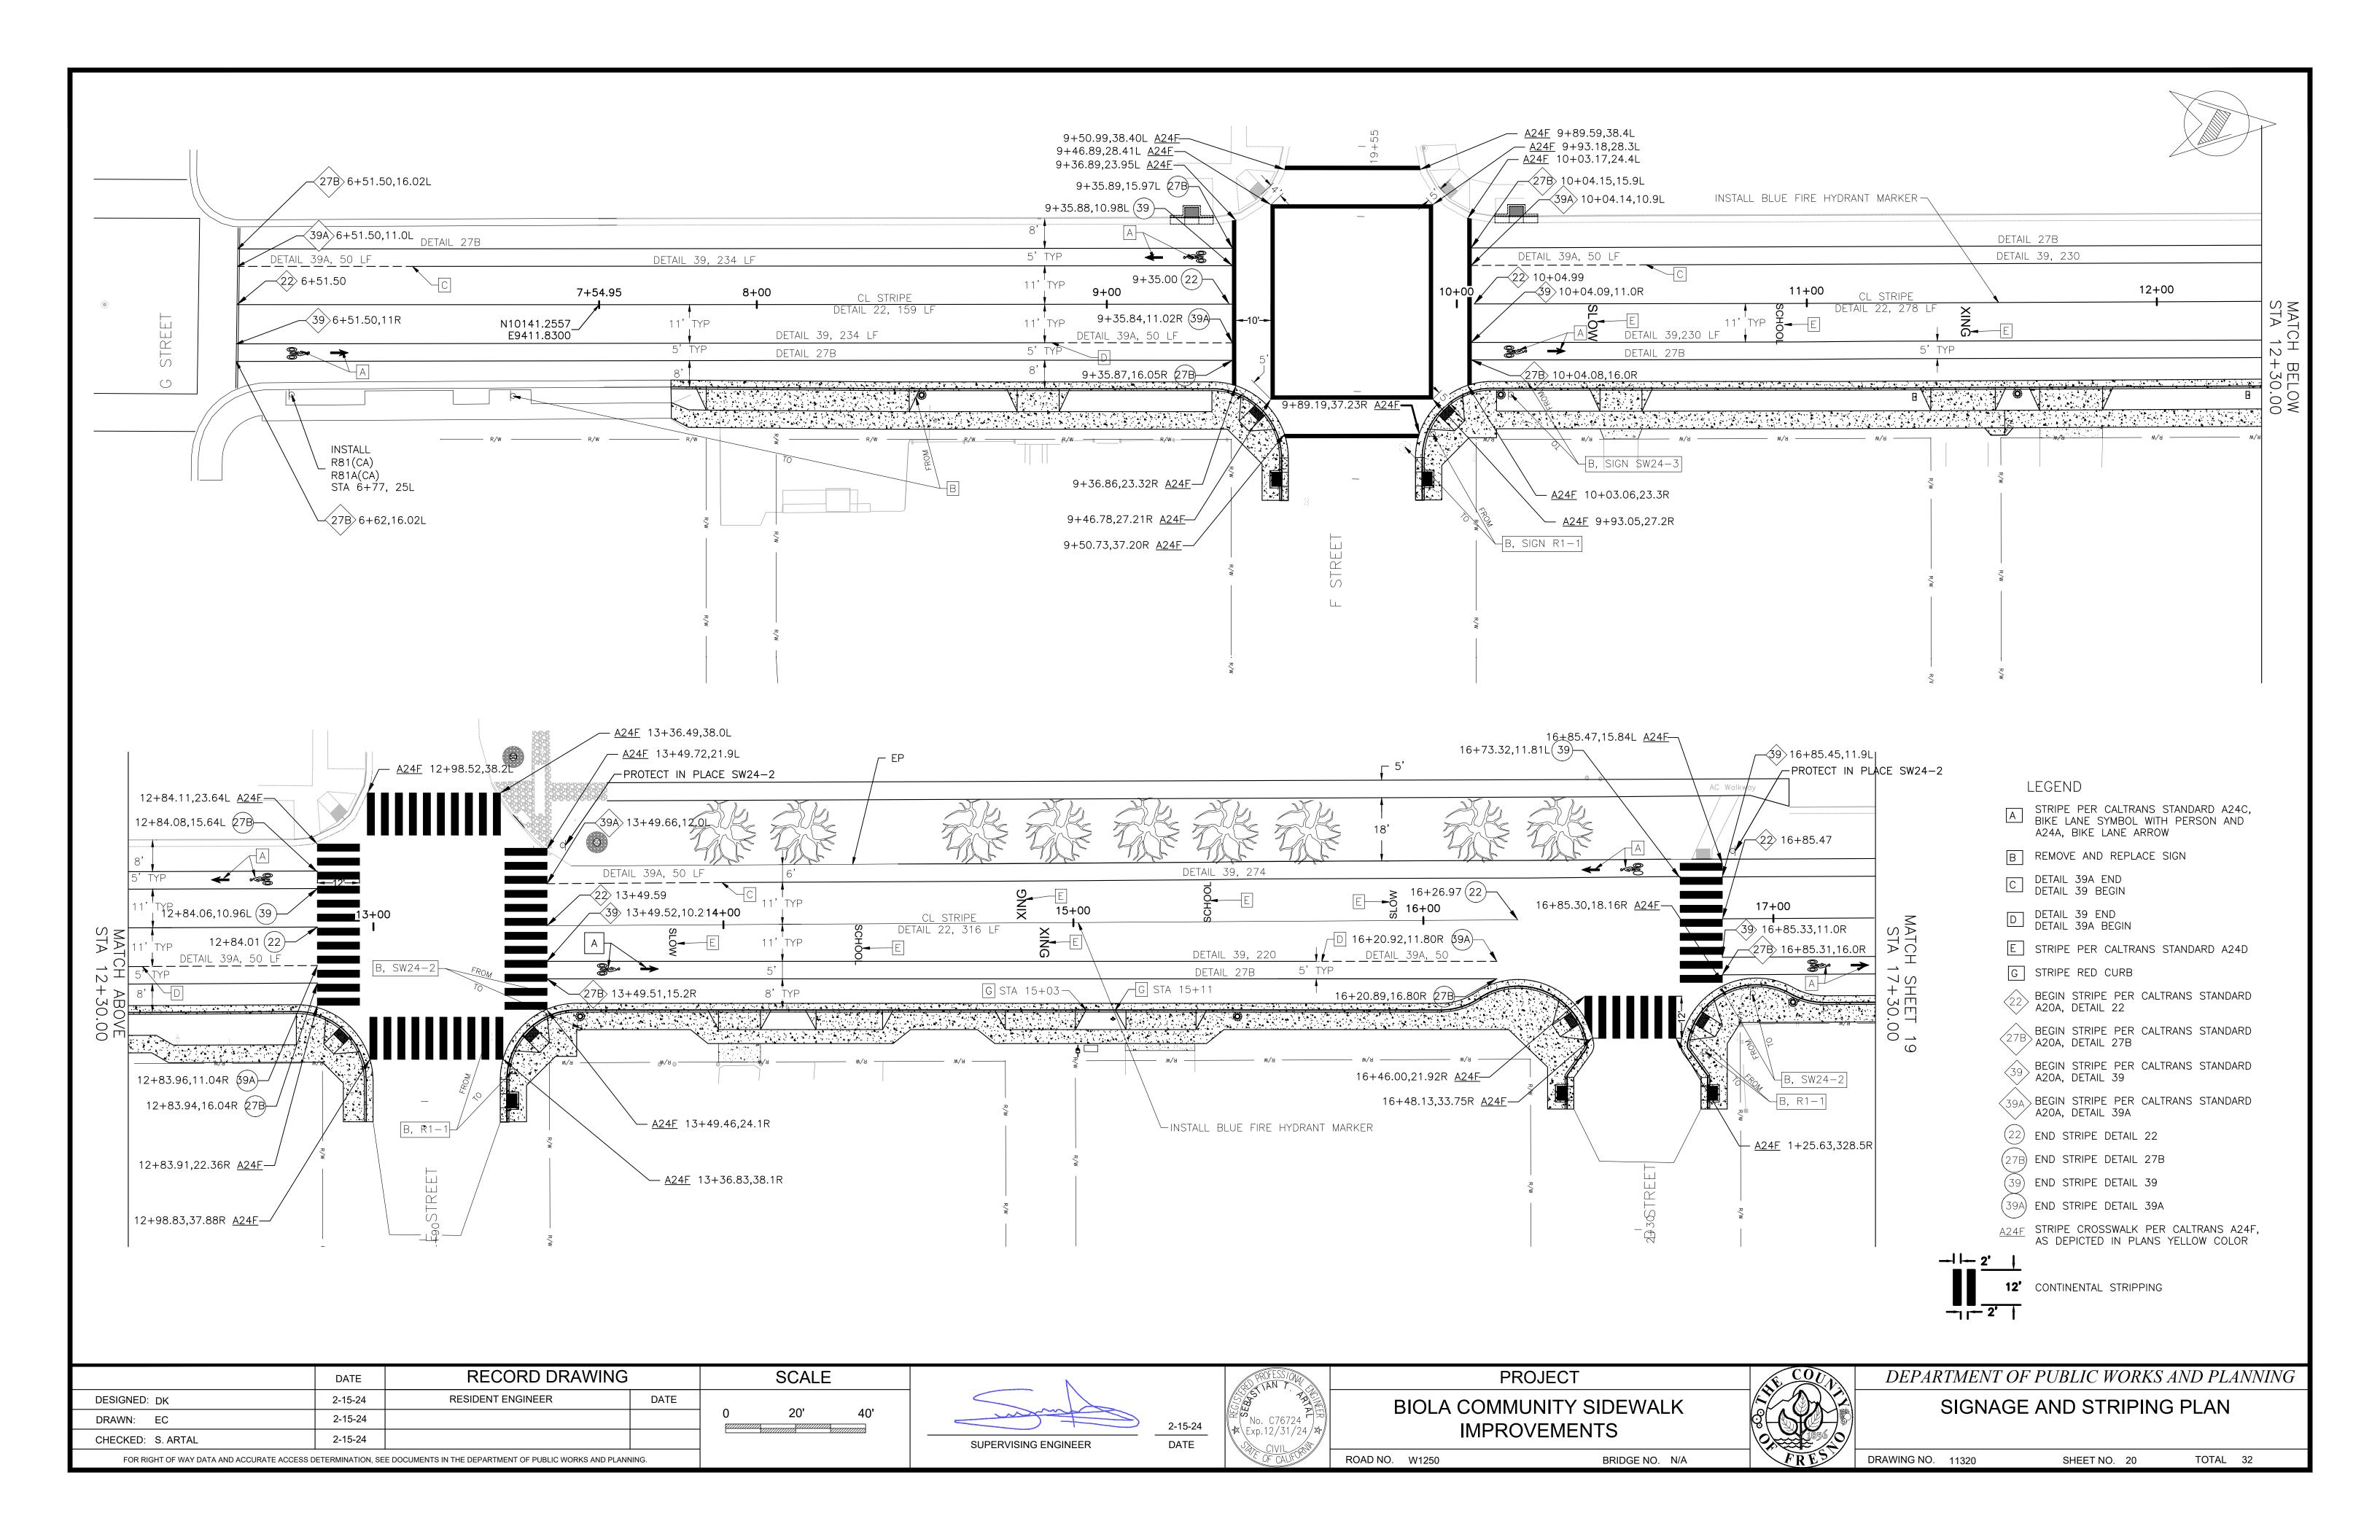


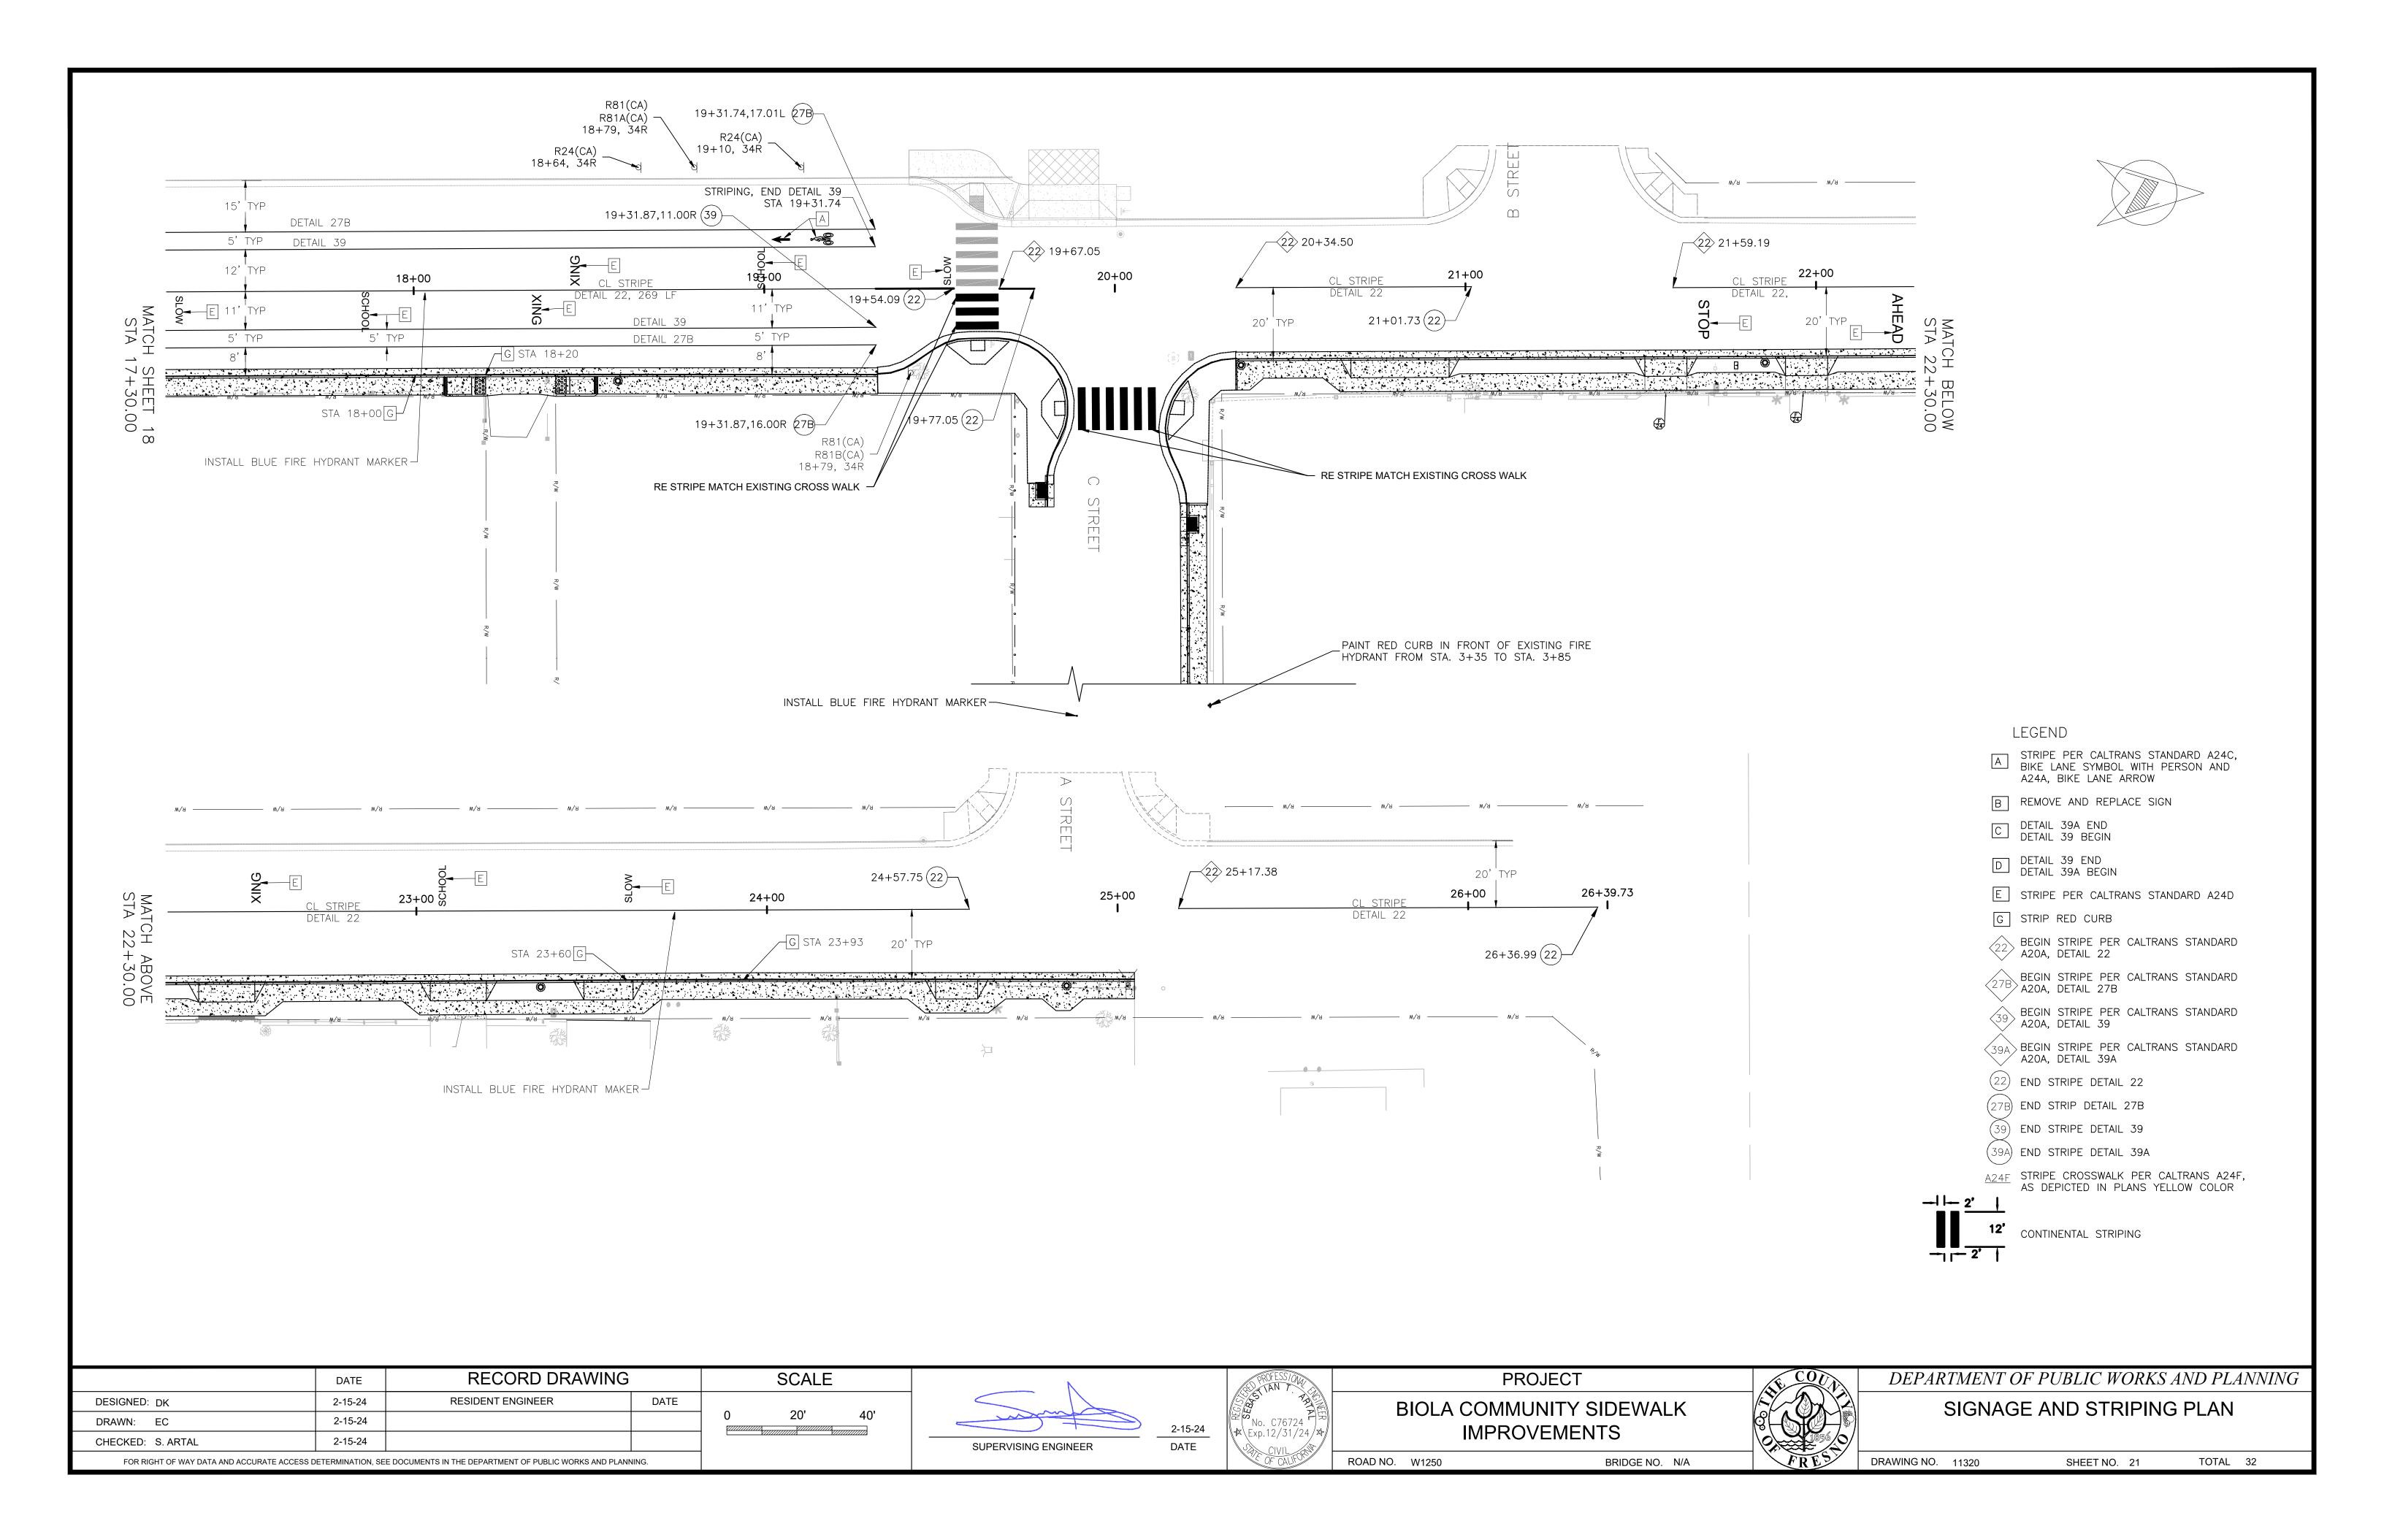


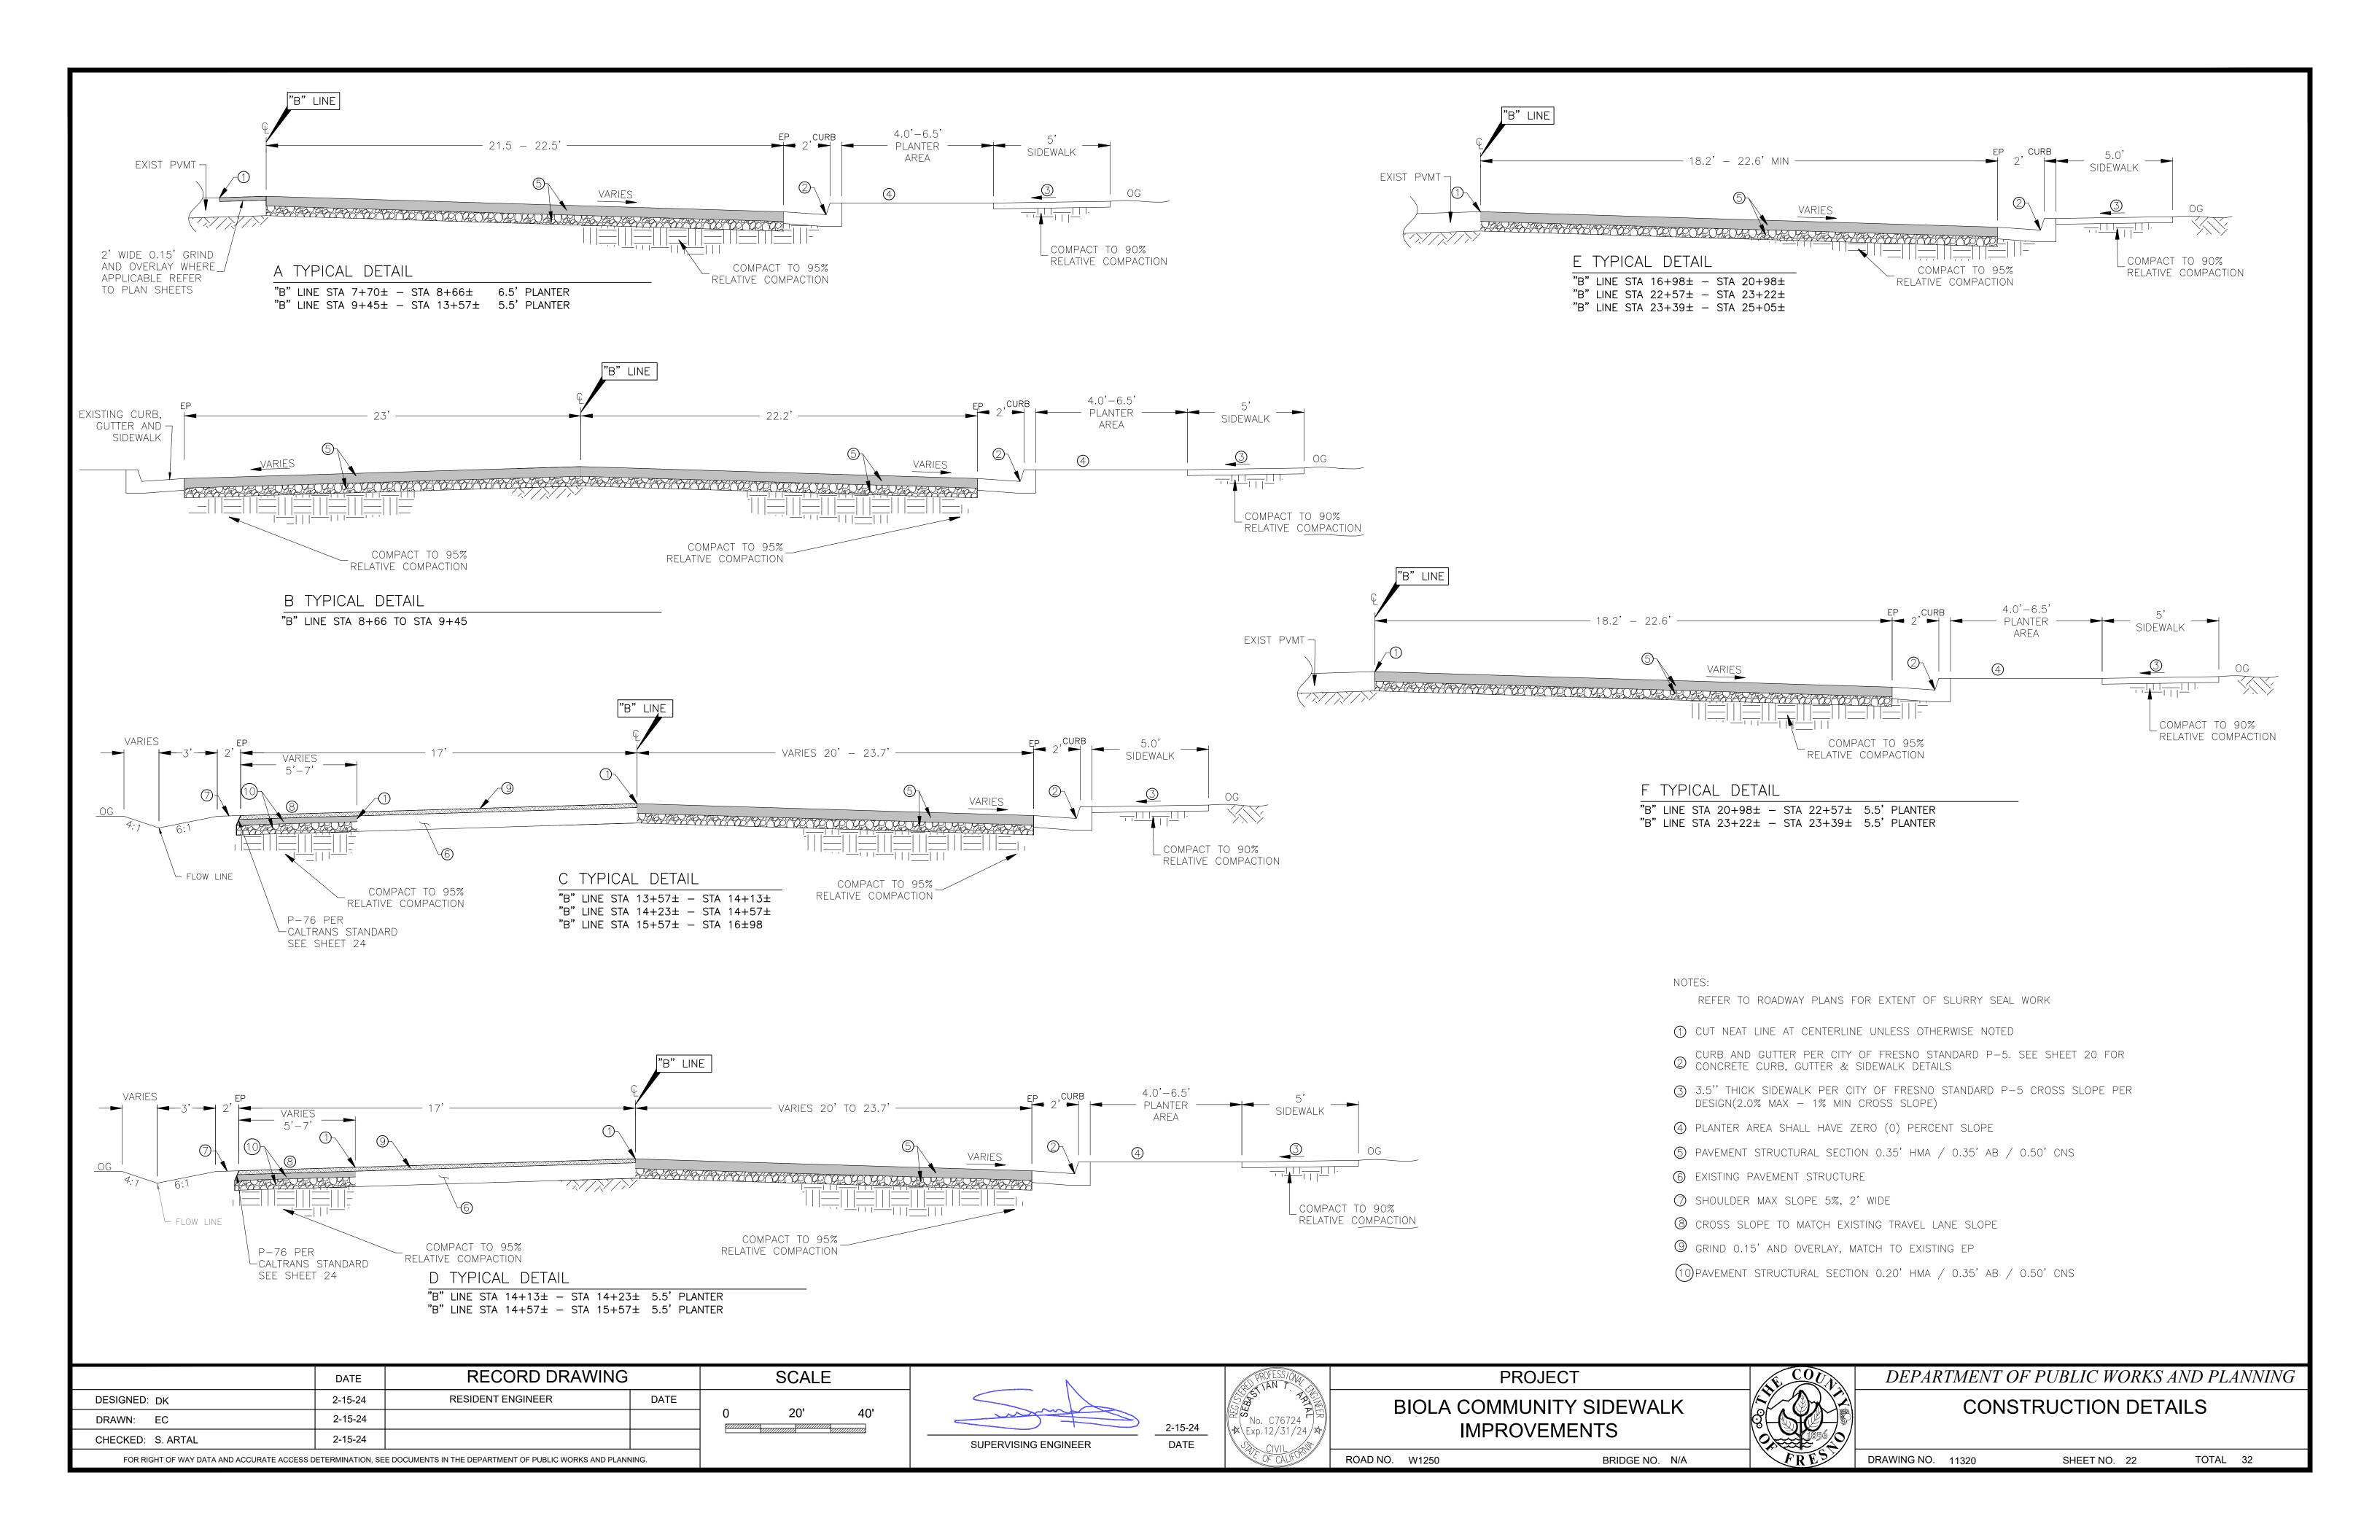


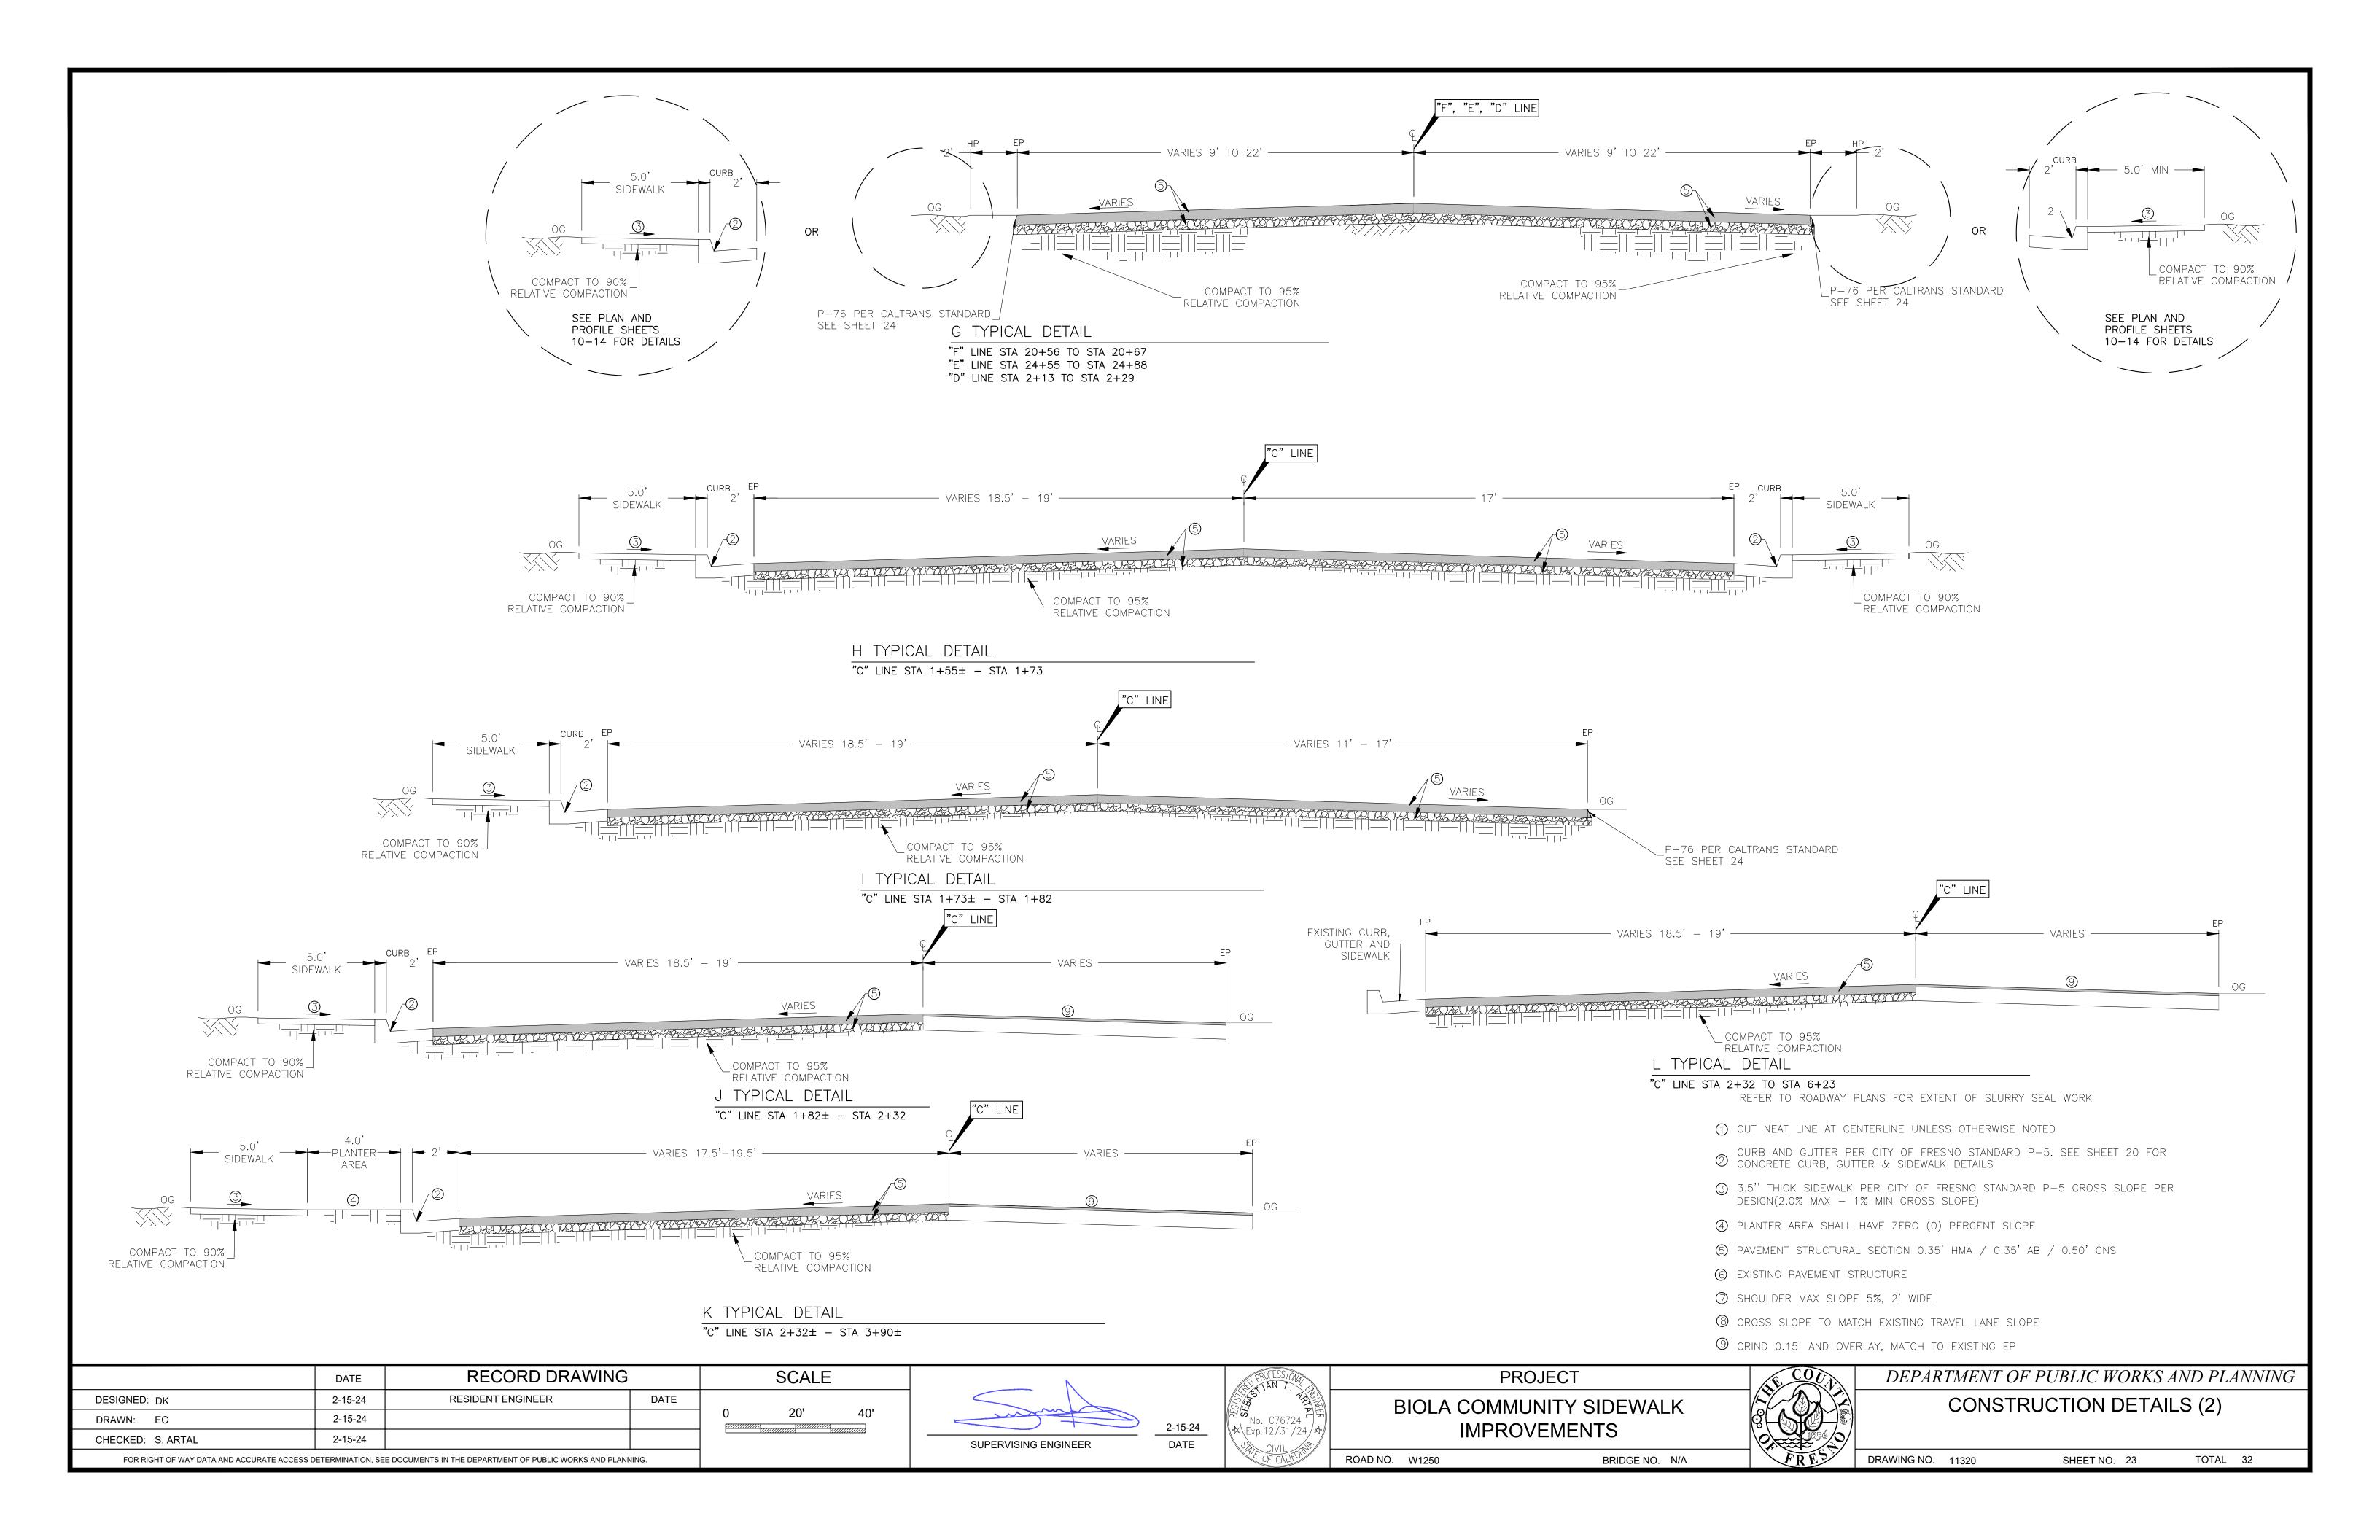

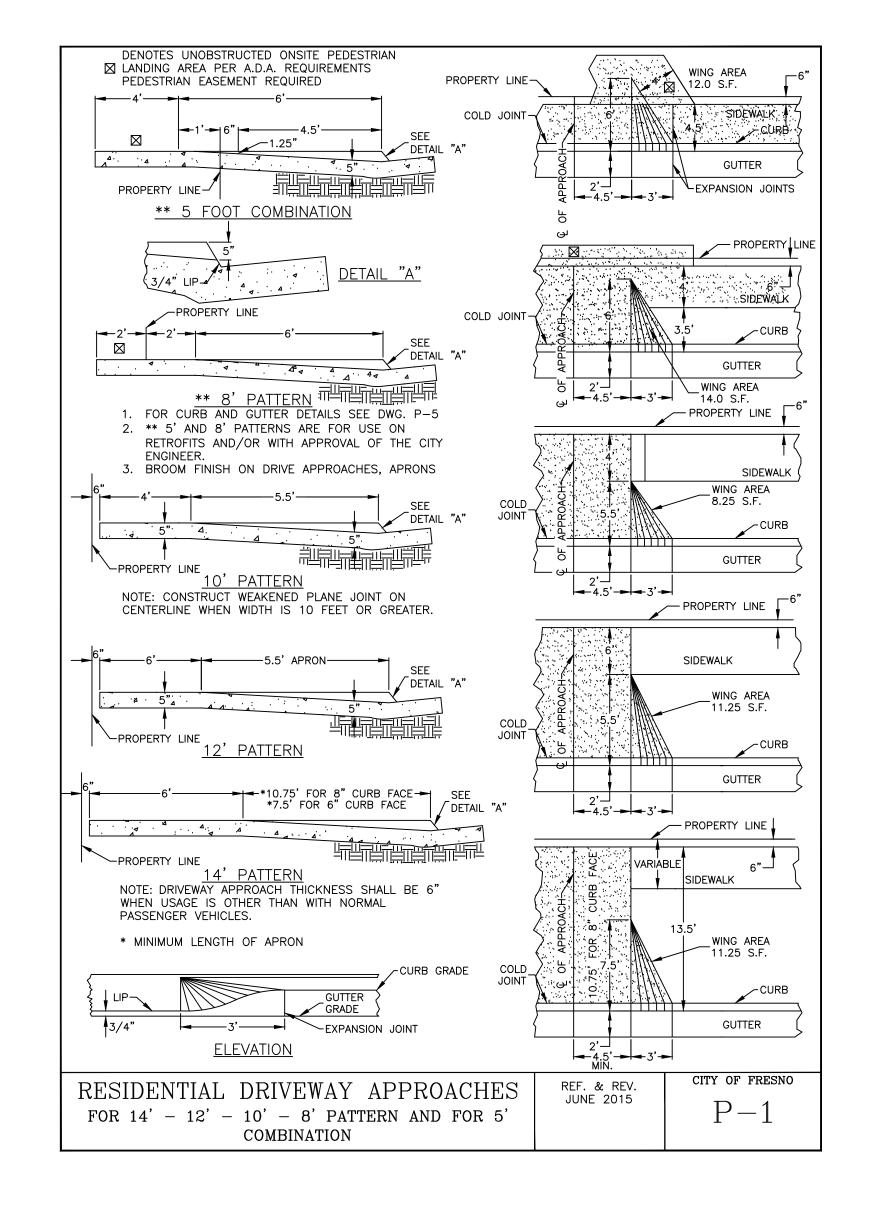

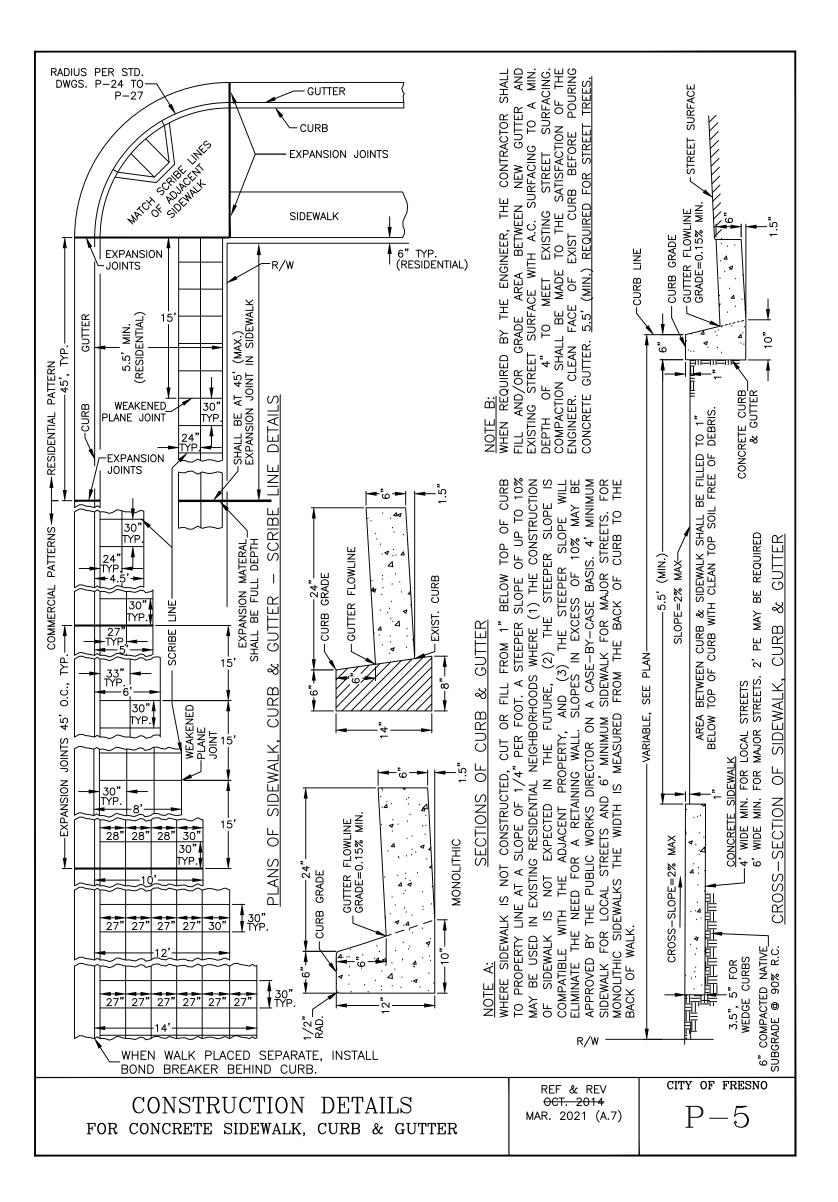


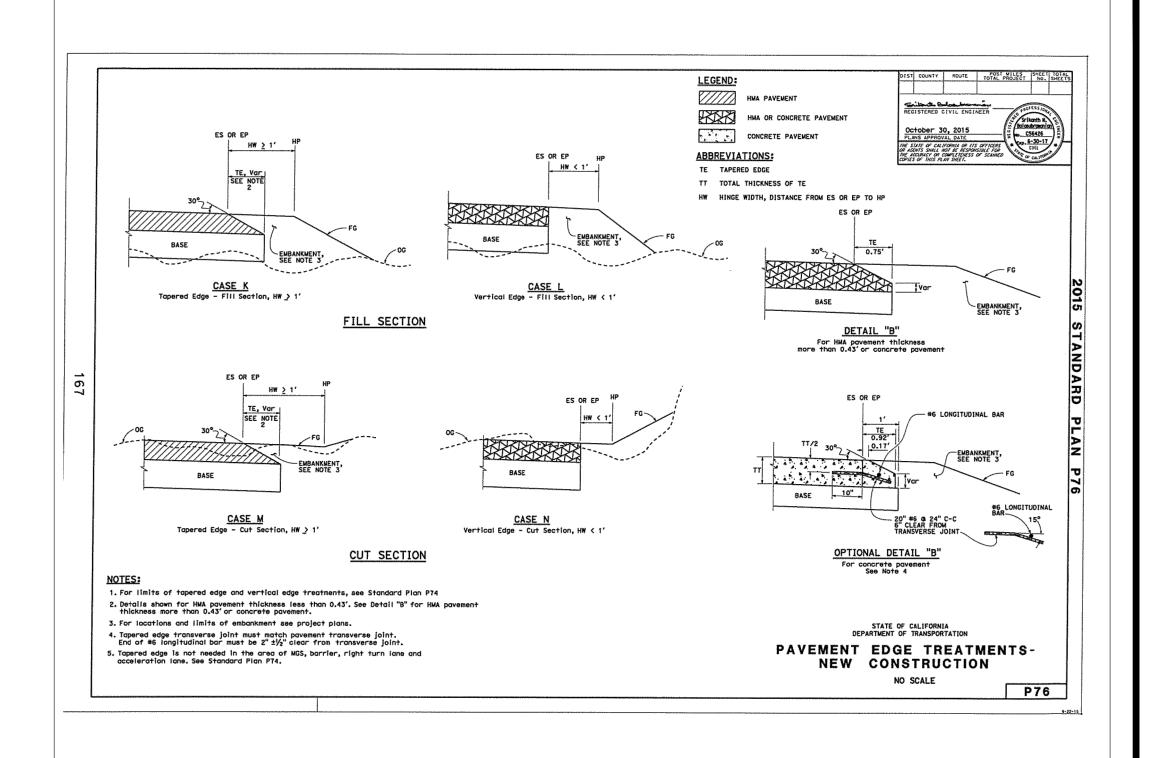


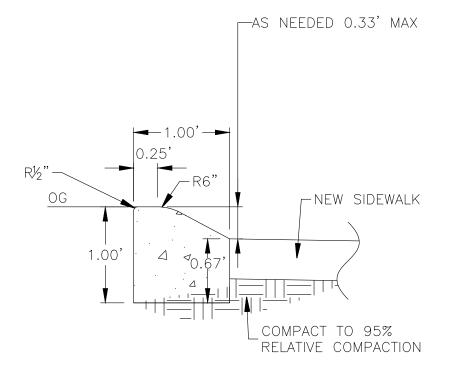


MOUNTABLE CURB BEHIND SIDEWALK F
SHEETS 12, 13 & 17 24

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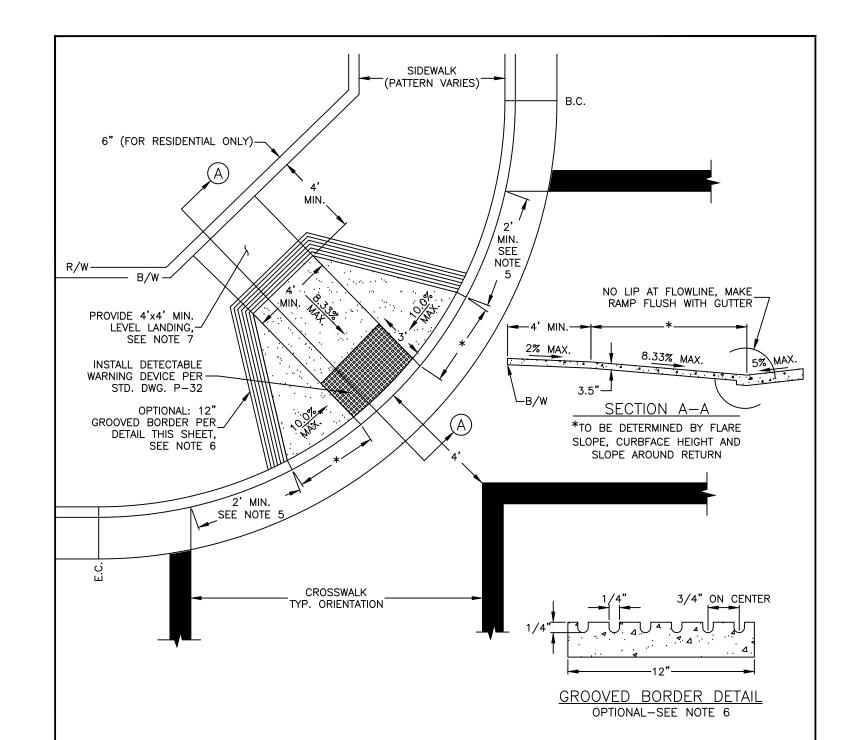


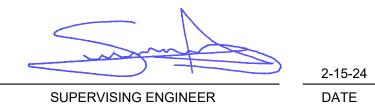BRIDGE NO. N/A

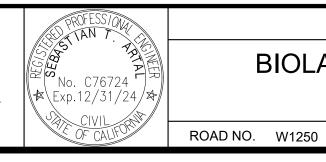0 1856 FRES DEPARTMENT OF PUBLIC WORKS AND PLANNING

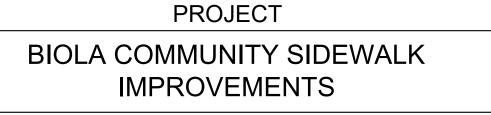CONSTRUCTION DETAIL CG & SDWK

DRAWING NO. 11320 SHEET NO. 24 TOTAL 32




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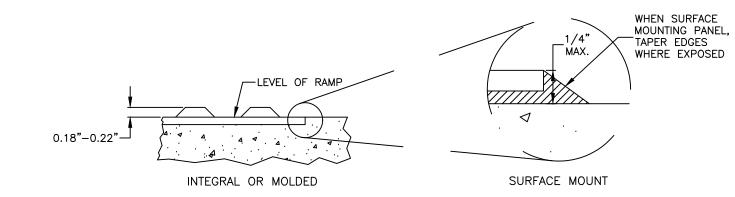
- 1. TRANSITIONS FROM RAMPS AND LANDING TO WALK, GUTTERS OR STREETS SHALL BE FLUSH AND FREE OF
- SURFACE OF CURB RAMP AND FLARED SIDES SHALL HAVE A MEDIUM BROOM FINISH TRANSVERSE TO PATH OF TRAVEL AND SHALL BE OF CONTRASTING FINISH TO THAT OF ADJACENT SIDEWALK.
 RAMP SLOPE SHALL NEVER EXCEED 8.33% AND THE FLARED SIDES SHALL NOT EXCEED 10%.
- 4. THE SLOPE OF ADJOINING GUTTERS, ROAD SURFACE OR ACCESSIBLE ROUTE WITHIN 4' OF THE BOTTOM OF THE RAMP SHALL NOT EXCEED 5% SLOPE.
- THERE SHALL BE A SEGMENT OF STRAIGHT CURB, AT LEAST 2.0' FEET LONG, ON EACH SIDE OF THE CURB RAMP, AS MEASURED FROM WITHIN THE MARKED CROSSWALK.
 (OPTIONAL) PROVIDE A 12" WIDE, GROOVED, BORDER AT THE LEVEL SURFACE OF THE SIDEWALK ALONG THE TOP
- OF THE RAMP AND EACH FLARE. GROOVES SHALL BE APPROX. 1/4" DEEP, 1/4" WIDE AND SPACED 3/4" ON CENTER.
- 7. PROVIDE A MINIMUM 4' DEEP LEVEL LANDING ON UPPER END AND OVER FULL WIDTH OF RAMP. MAINTAIN A 2% MAX. SLOPE, ANY DIRECTION.
- 8. THE 4' CLEAR SPACE AT BOTTOM OF RAMP SHALL BE WITHIN THE MARKED CROSSINGS.
 9. RAMP SHALL BE MINIMUM OF 4' WIDE AND SHALL LIE GENERALLY IN A SINGLE SLOPED PLANE WITH A MINIMUM
- OF SURFACE WARPING AND CROSS SLOPE.

 10. CURB RAMPS SHALL BE LOCATED OR PROTECTED TO PREVENT THEIR OBSTRUCTION BY PARKED CARS.

	REF. & REV.	CITY OF FRESNO
DIAGONAL CURB RAMP	AUG. 2010 MAR. 2021 (A.7)	D_98
(USE ONLY WHEN NECESSARY)	, ,	1 -20

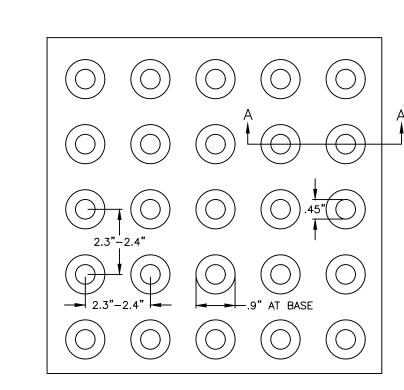

DOME PATTERN



TYPICAL SECTION A-A

NOTES:

SCALE

- 1. THE DETECTABLE WARNING SHALL VISUALLY CONTRAST PER THE CALIFORNIA BUILDING CODE, LATEST REVISION. THE MATERIAL USED SHALL BE AN INTEGRAL PART OF THE WALKING SURFACE. THE COLOR SHALL BE YELLOW AND APPROXIMATE FS 33538 OF SAE AMS—STD—595A.
- 2. THE DOMES MAY BE CONSTRUCTED IN A VARIETY OF METHODS INCLUDING CAST—IN—PLACE OR STAMPED. IT MAY ALSO BE PART OF A PREFABRICATED SURFACE TREATMENT, SEE SURFACE MOUNT DETAIL.
- 3. ONLY APPROVED DSA/AC DETECTABLE WARNING PRODUCTS AND DIRECTIONAL SURFACES SHALL BE INSTALLED AS PROVIDED IN THE CALIFORNIA CODE OF REGULATIONS (CCR), TITLE 24, PART 1, ARTICLES 2, 3 AND 4. REFER TO CCR TITLE 24, PART 12, CHAPTER 12-11A AND B FOR BUILDING FACILITY ACCESS SPECIFICATIONS FOR PRODUCT APPROVAL FOR DETECTABLE WARNING PRODUCTS AND DIRECTIONAL SURFACES.
- 4. DETECTABLE WARNING PRODUCTS AND DETECTABLE SURFACES SHALL BE EVALUATED BY AN INDEPENDENT ENTITY, SELECTED BY THE DEPARTMENT OF GENERAL SERVICES, DIVISION OF THE STATE ARCHITECT—ACCESS COMPLIANCE FOR ALL OCCUPANCIES, INCLUDING TRANSPORTATION AND OTHER OUTDOOR ENVIRONMENTS. SEE GOVERNMENT CODE SECTION 4460.

	REF. & REV.	CITY OF FRESNO
DETECTABLE WARNING DEVICES	AUG. 2010 JUNE 2014 MAR. 2021 (A.7)	P - 32
	JAN. 2023 (A.8)	


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SUPERVISING ENGINEER



DATE




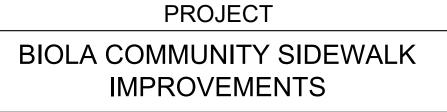



DEPARTMENT OF PUBLIC WORKS AND PLANNING

CONSTRUCTION DETAIL RAMPS


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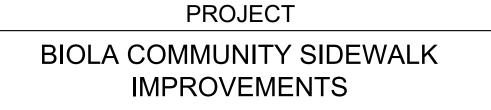

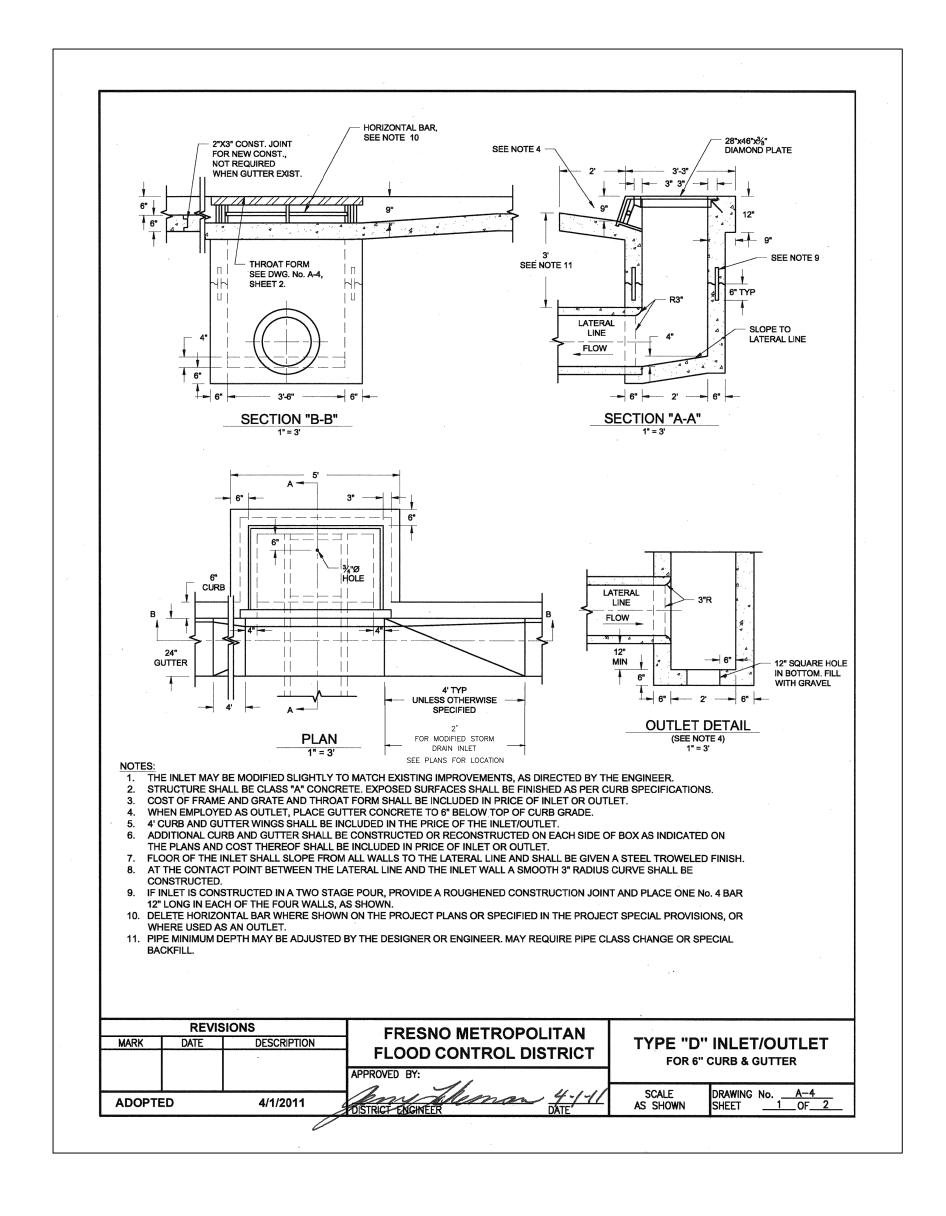
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CHECKED: S. ARTAL	2-15-24				*/////////////////////////////////////	//////////////////////////////////////	
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ROAD NO. W1250

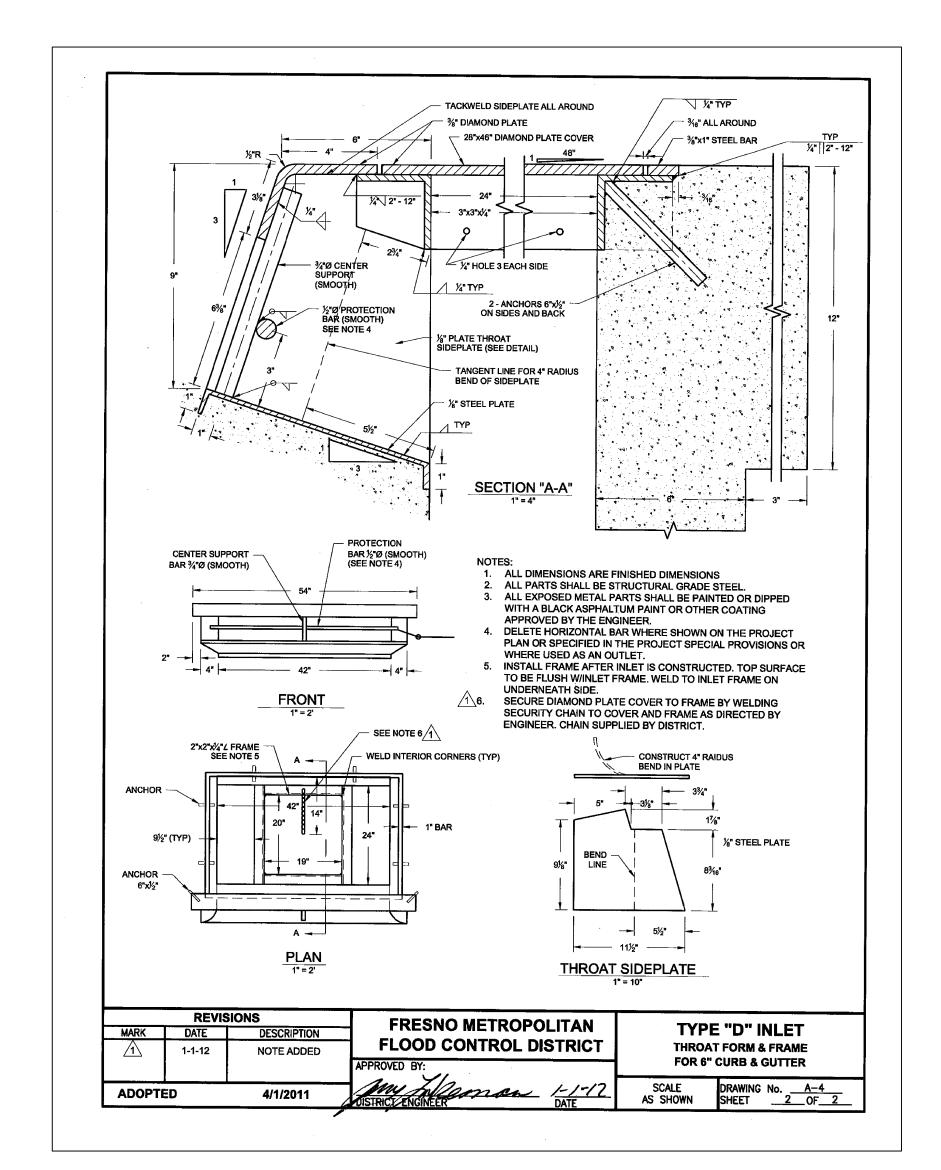

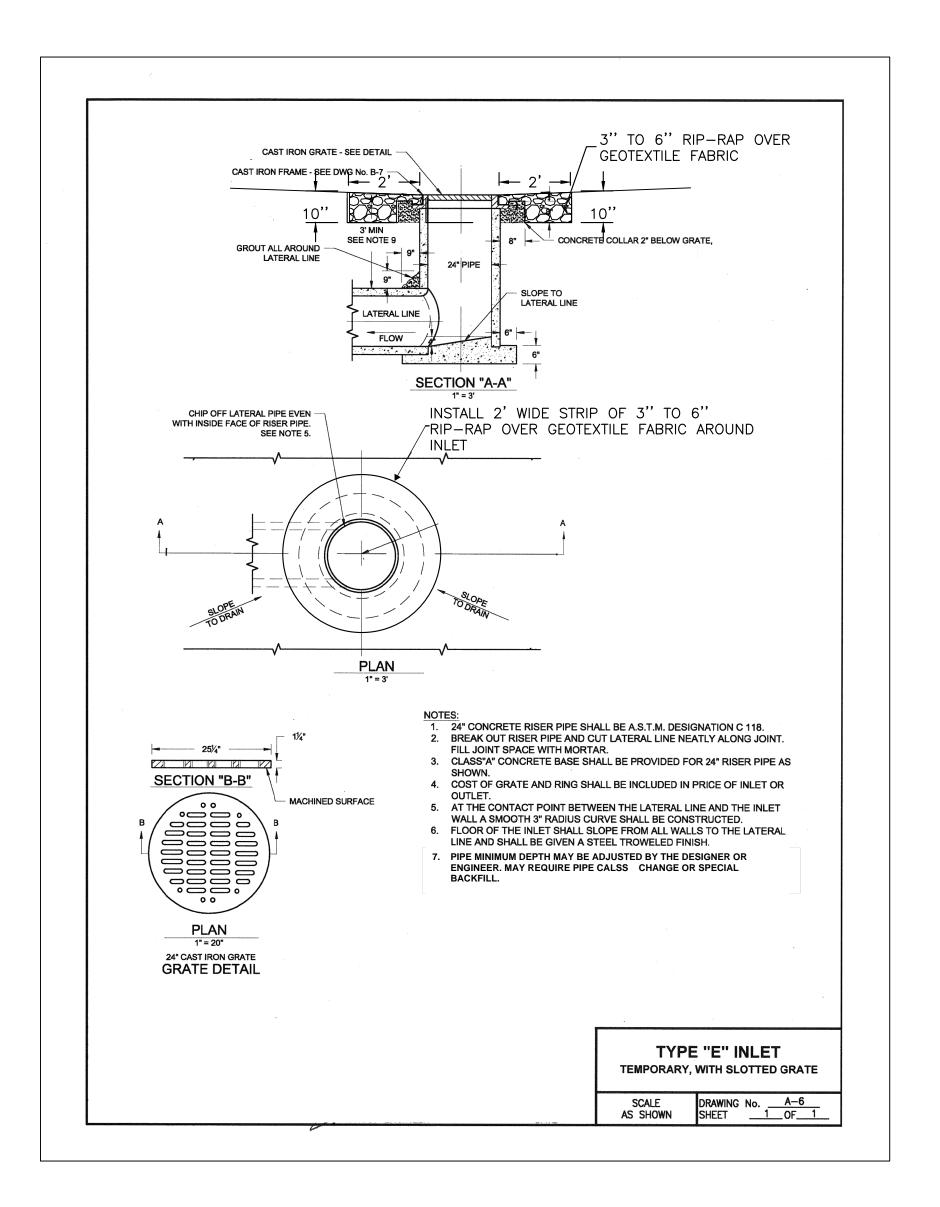BRIDGE NO. N/A

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FRES	

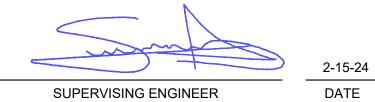
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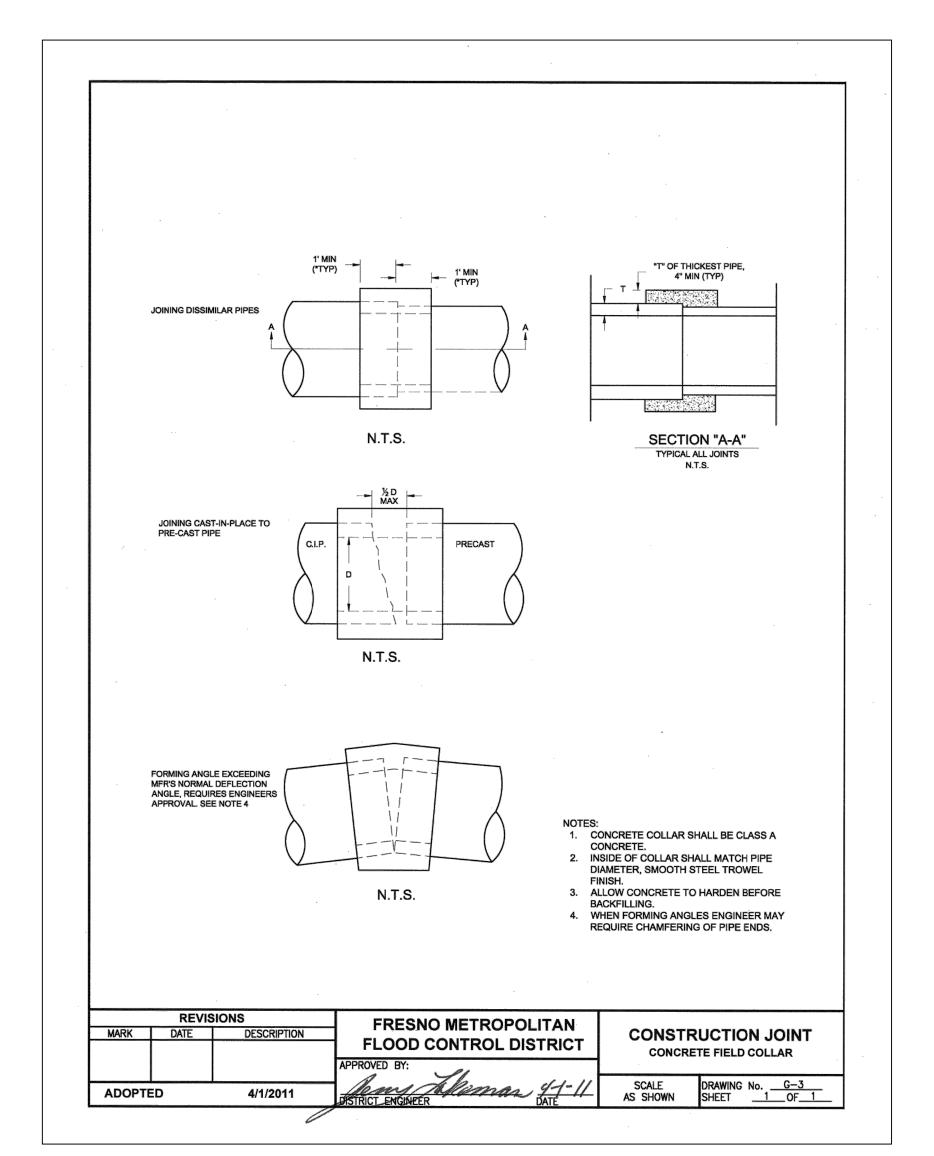
DEPARTMENT OF PUBLIC WORKS AND PLANNING

CONSTRUCTION DETAIL INLETS


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TOTAL 32





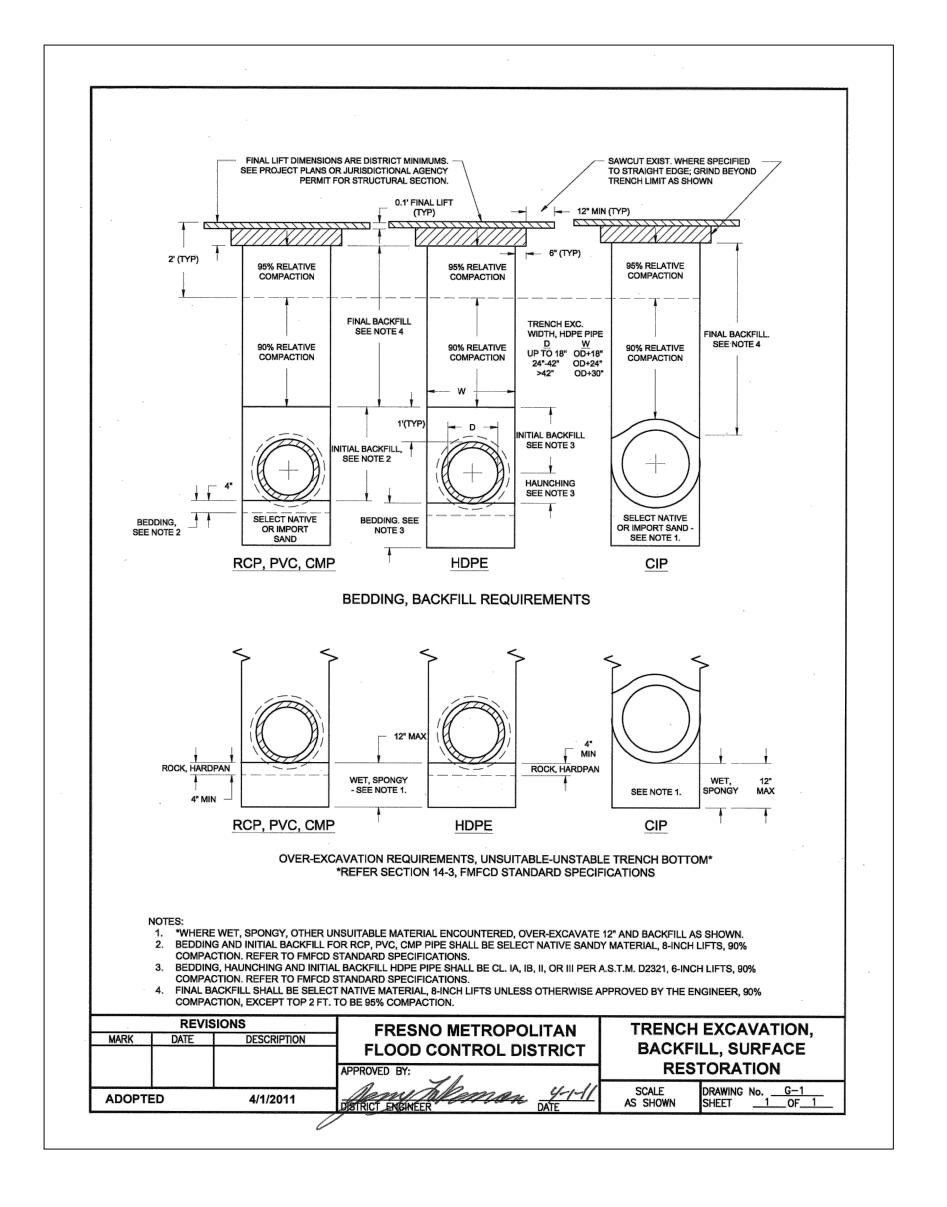

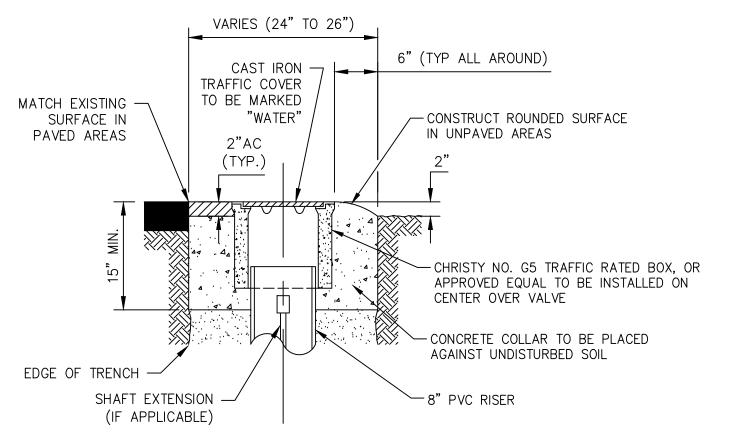


NOTES

1. ADJUST VALVE BOX AND COVER TO FINISHED GRADE.

- 2. CONCRETE COLLAR SHALL BE CONSTRUCTED USING
- CLASS "A" CONCRETE.

 3. APPLY PAINT BINDER TO EXPOSED SIDE OF VALVE BOX
- PRIOR TO PAVING.

WATER VALVE BOX

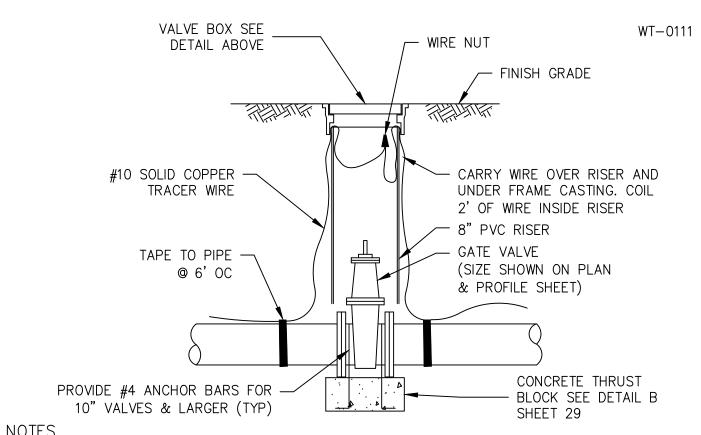

NOTES

- 1. EXTENSION ROD REQUIRED WHEN DISTANCE FROM FINISHED GRADE IS GREATER THAN 36"
- CONSTRUCT CONCRETE COLLAR.

 2. PROVIDE AT LEAST 6" OF OVERLAP BETWEEN RISER PIPES.

NOT TO SCALE


- 3. THRUST BLOCK ANCHORAGE REQUIRED FOR NON-FLANGED FITTINGS. ASSUME DEAD END CONDITION
- 4. THRUST BLOCK SHALL EXTEND A MINIMUM OF 6" BEYOND THE EDGE OF THE VALVE BODY ON EACH SIDE.

NOT TO SCALE

VALVE & VALVE BOX INSTALLATION

W-7

	DATE RECORD DRAWING		SCALE				
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CHECKED: S. ARTAL	2-15-24				<i>VIIIIIIIII</i>		
FOR RIGHT OF WAY DATA AND ACCURATE ACCESS DETERMINATION, SEE DOCUMENTS IN THE DEPARTMENT OF PUBLIC WORKS AND PLANNING.							

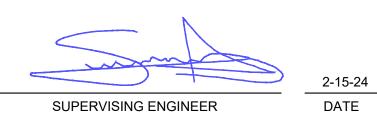


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Exp.12/31/24







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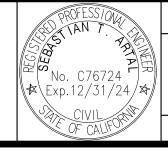
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ROAD NO. W1250

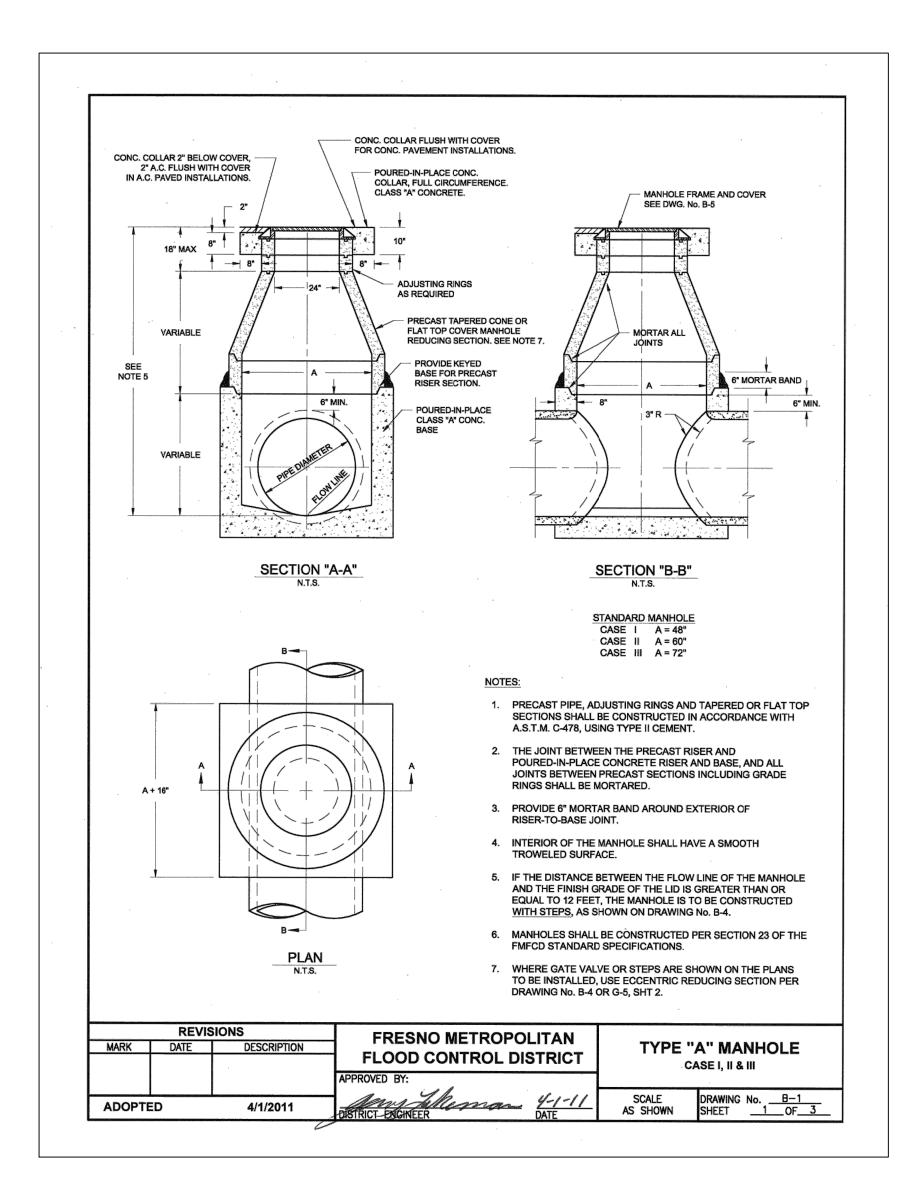


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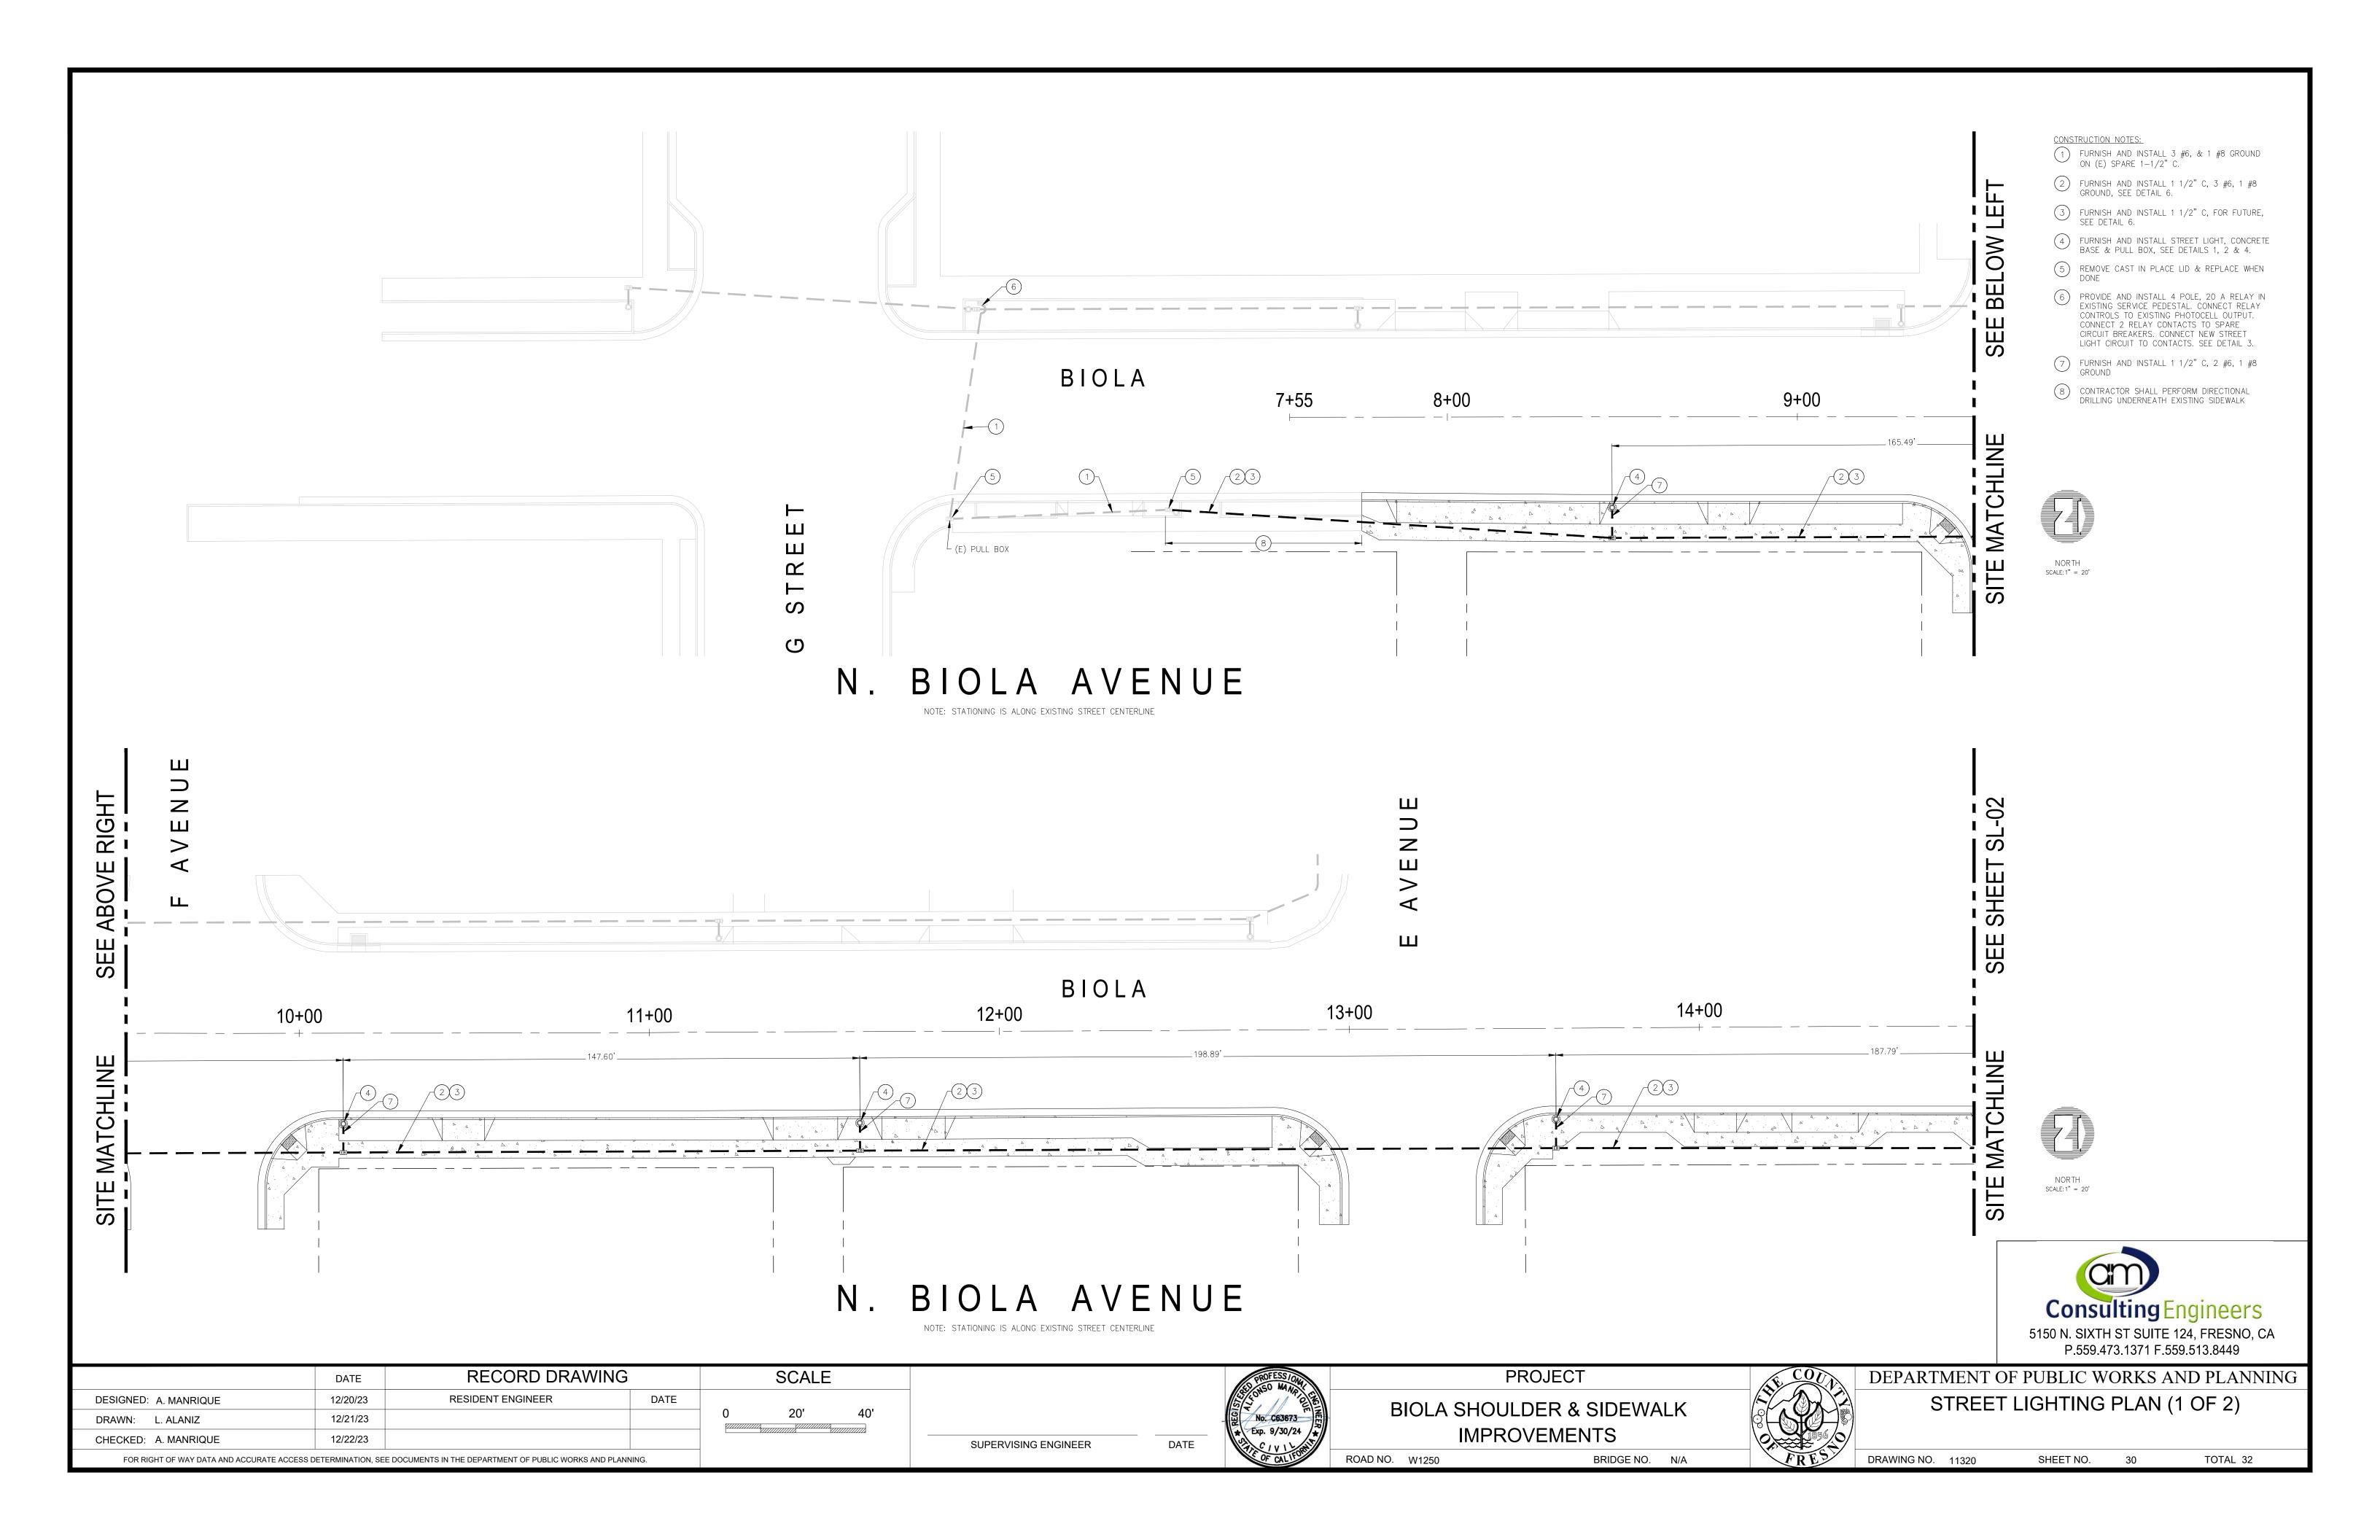
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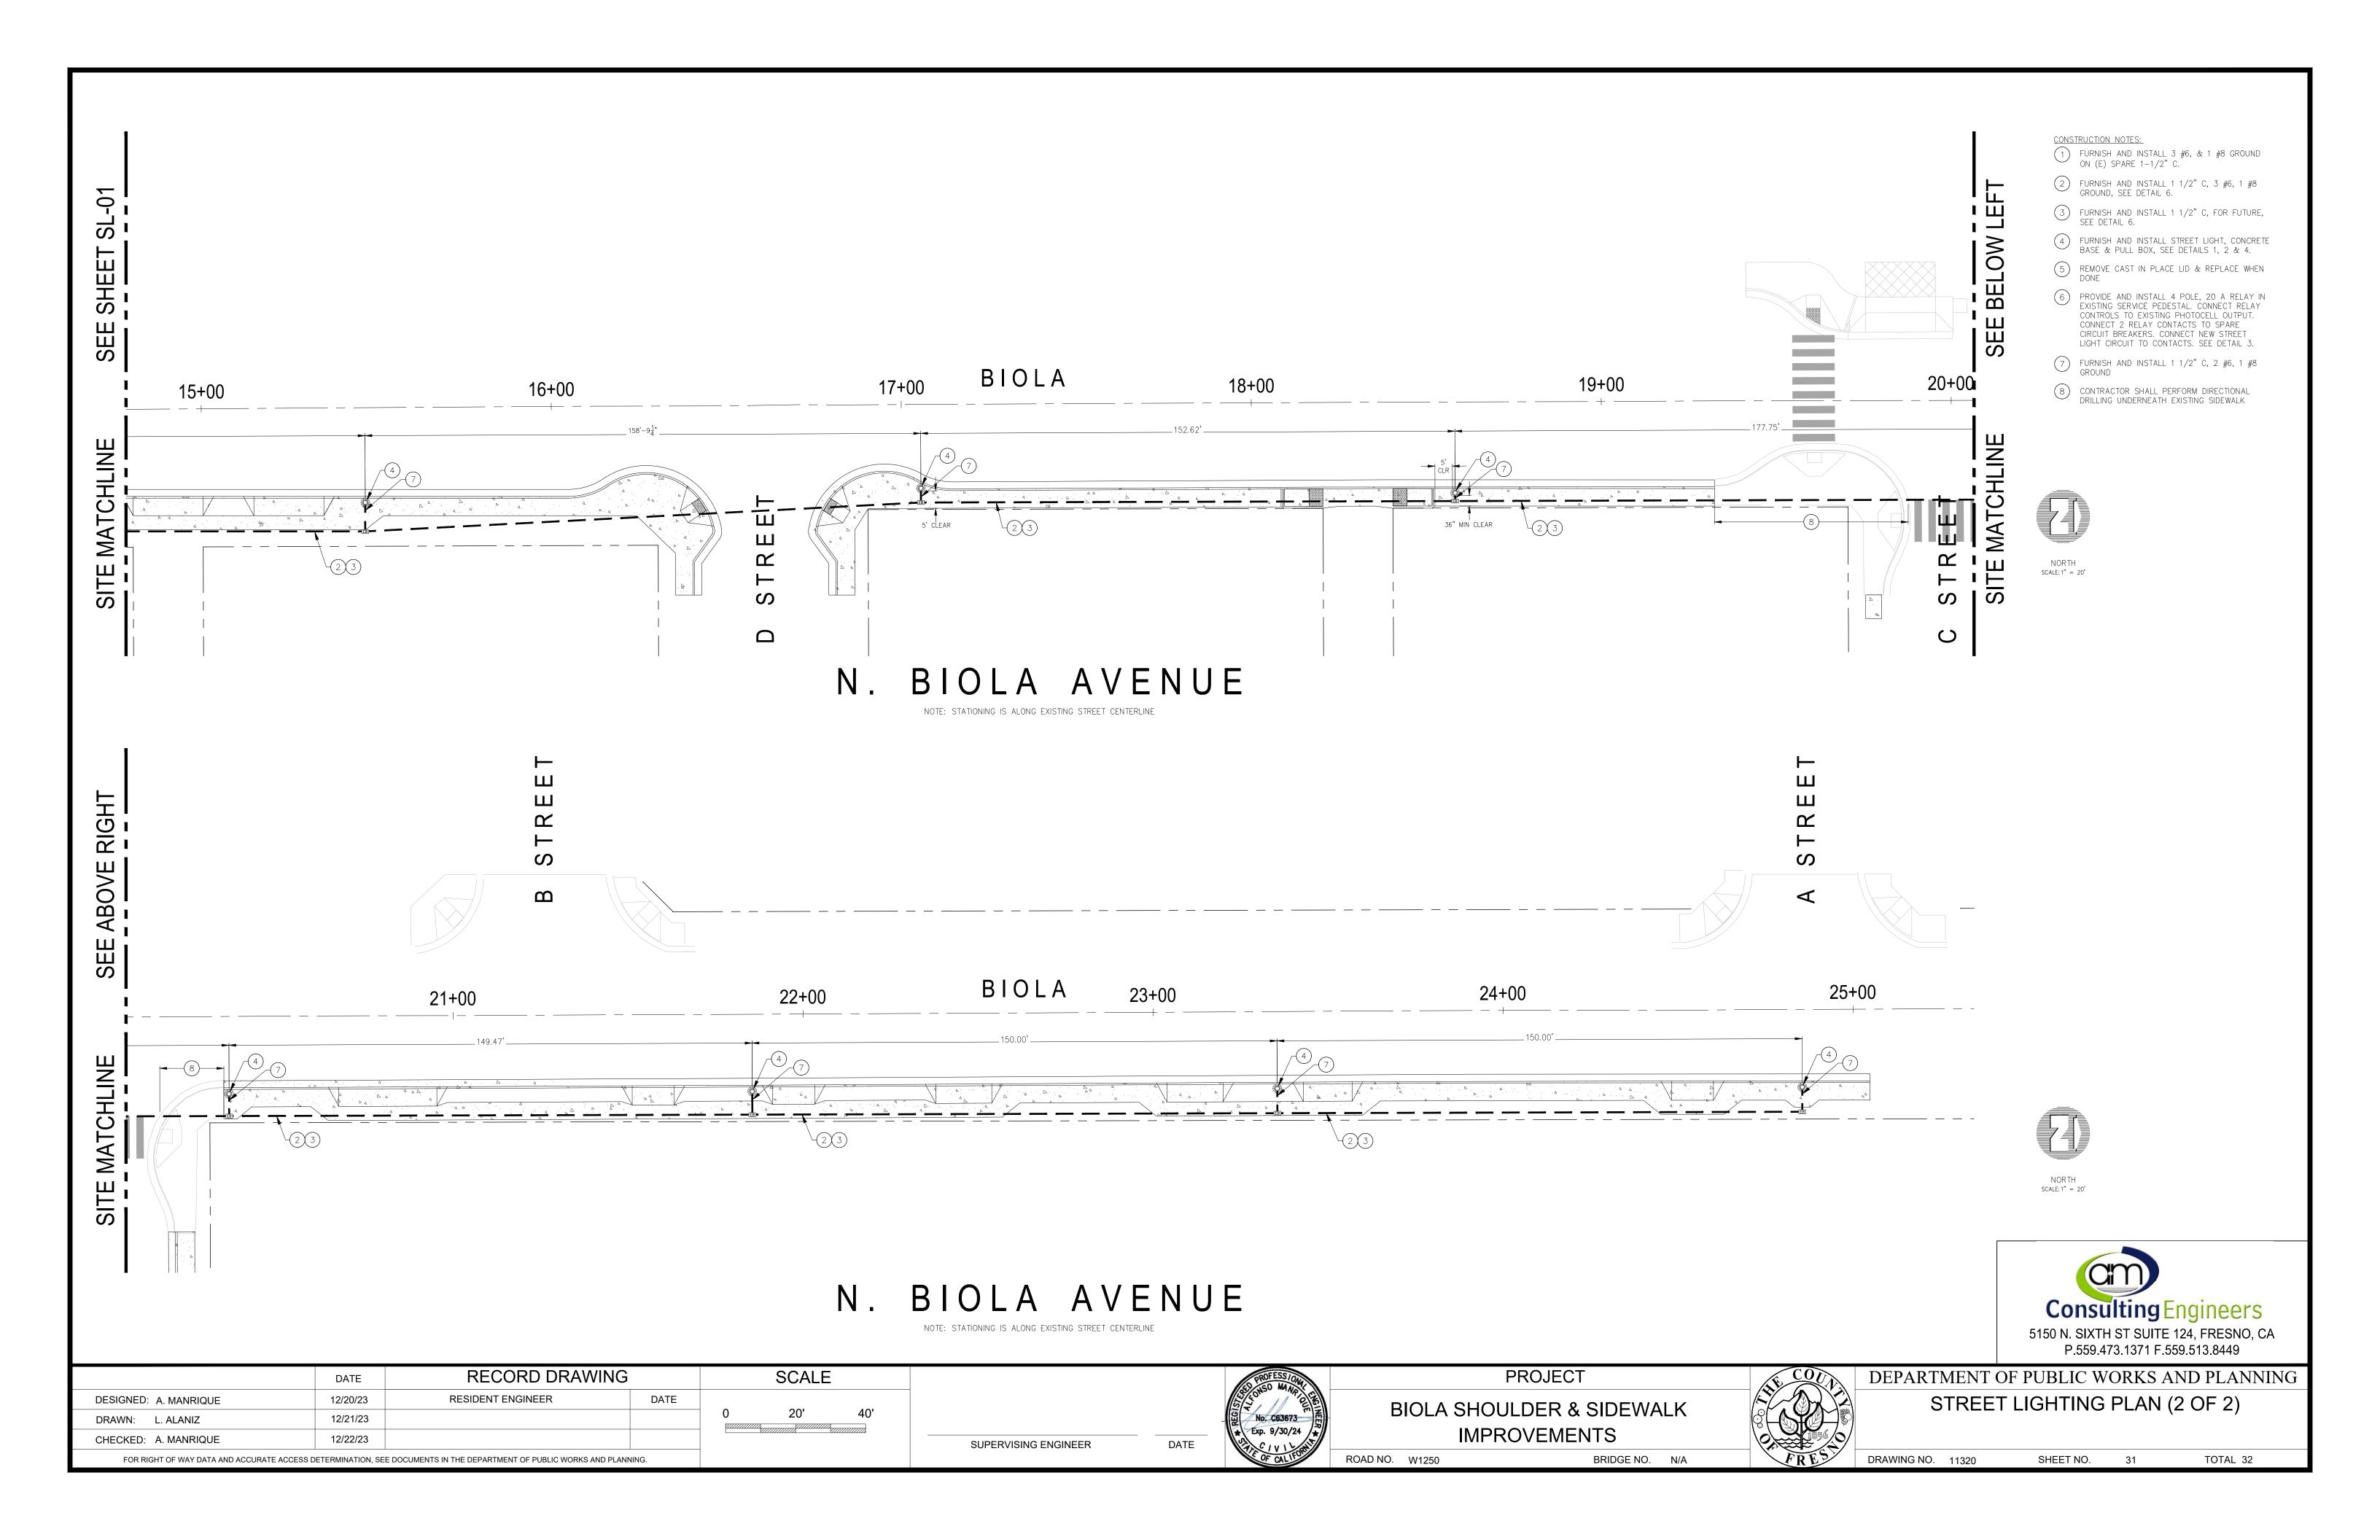
DEPARTMENT OF PUBLIC WORKS AND PLANNING

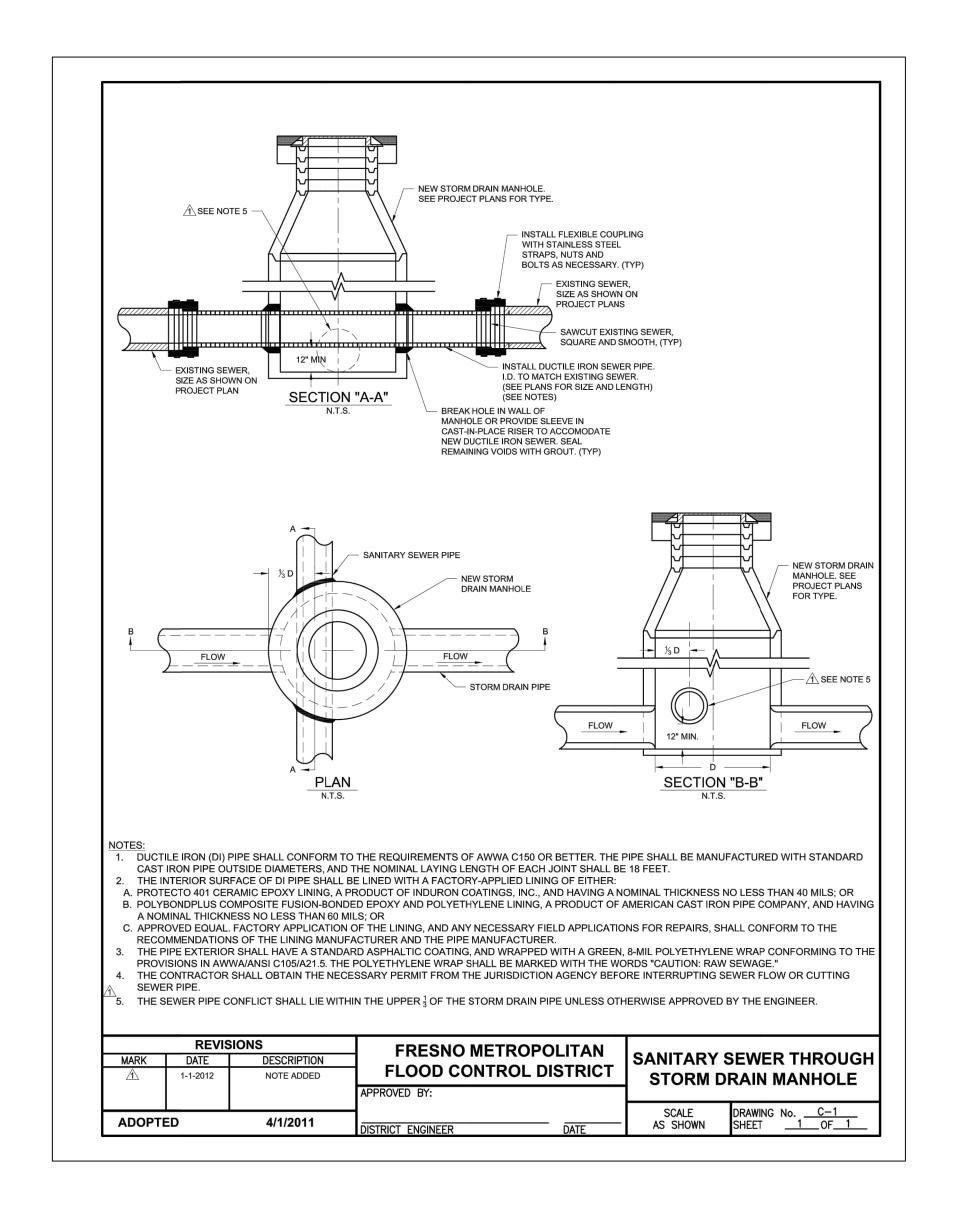
CONSTRUCTION DETAIL MANHOLES


DRAWING NO. 11320 SHEET NO. 28 TOTAL 32

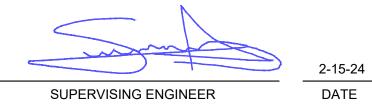



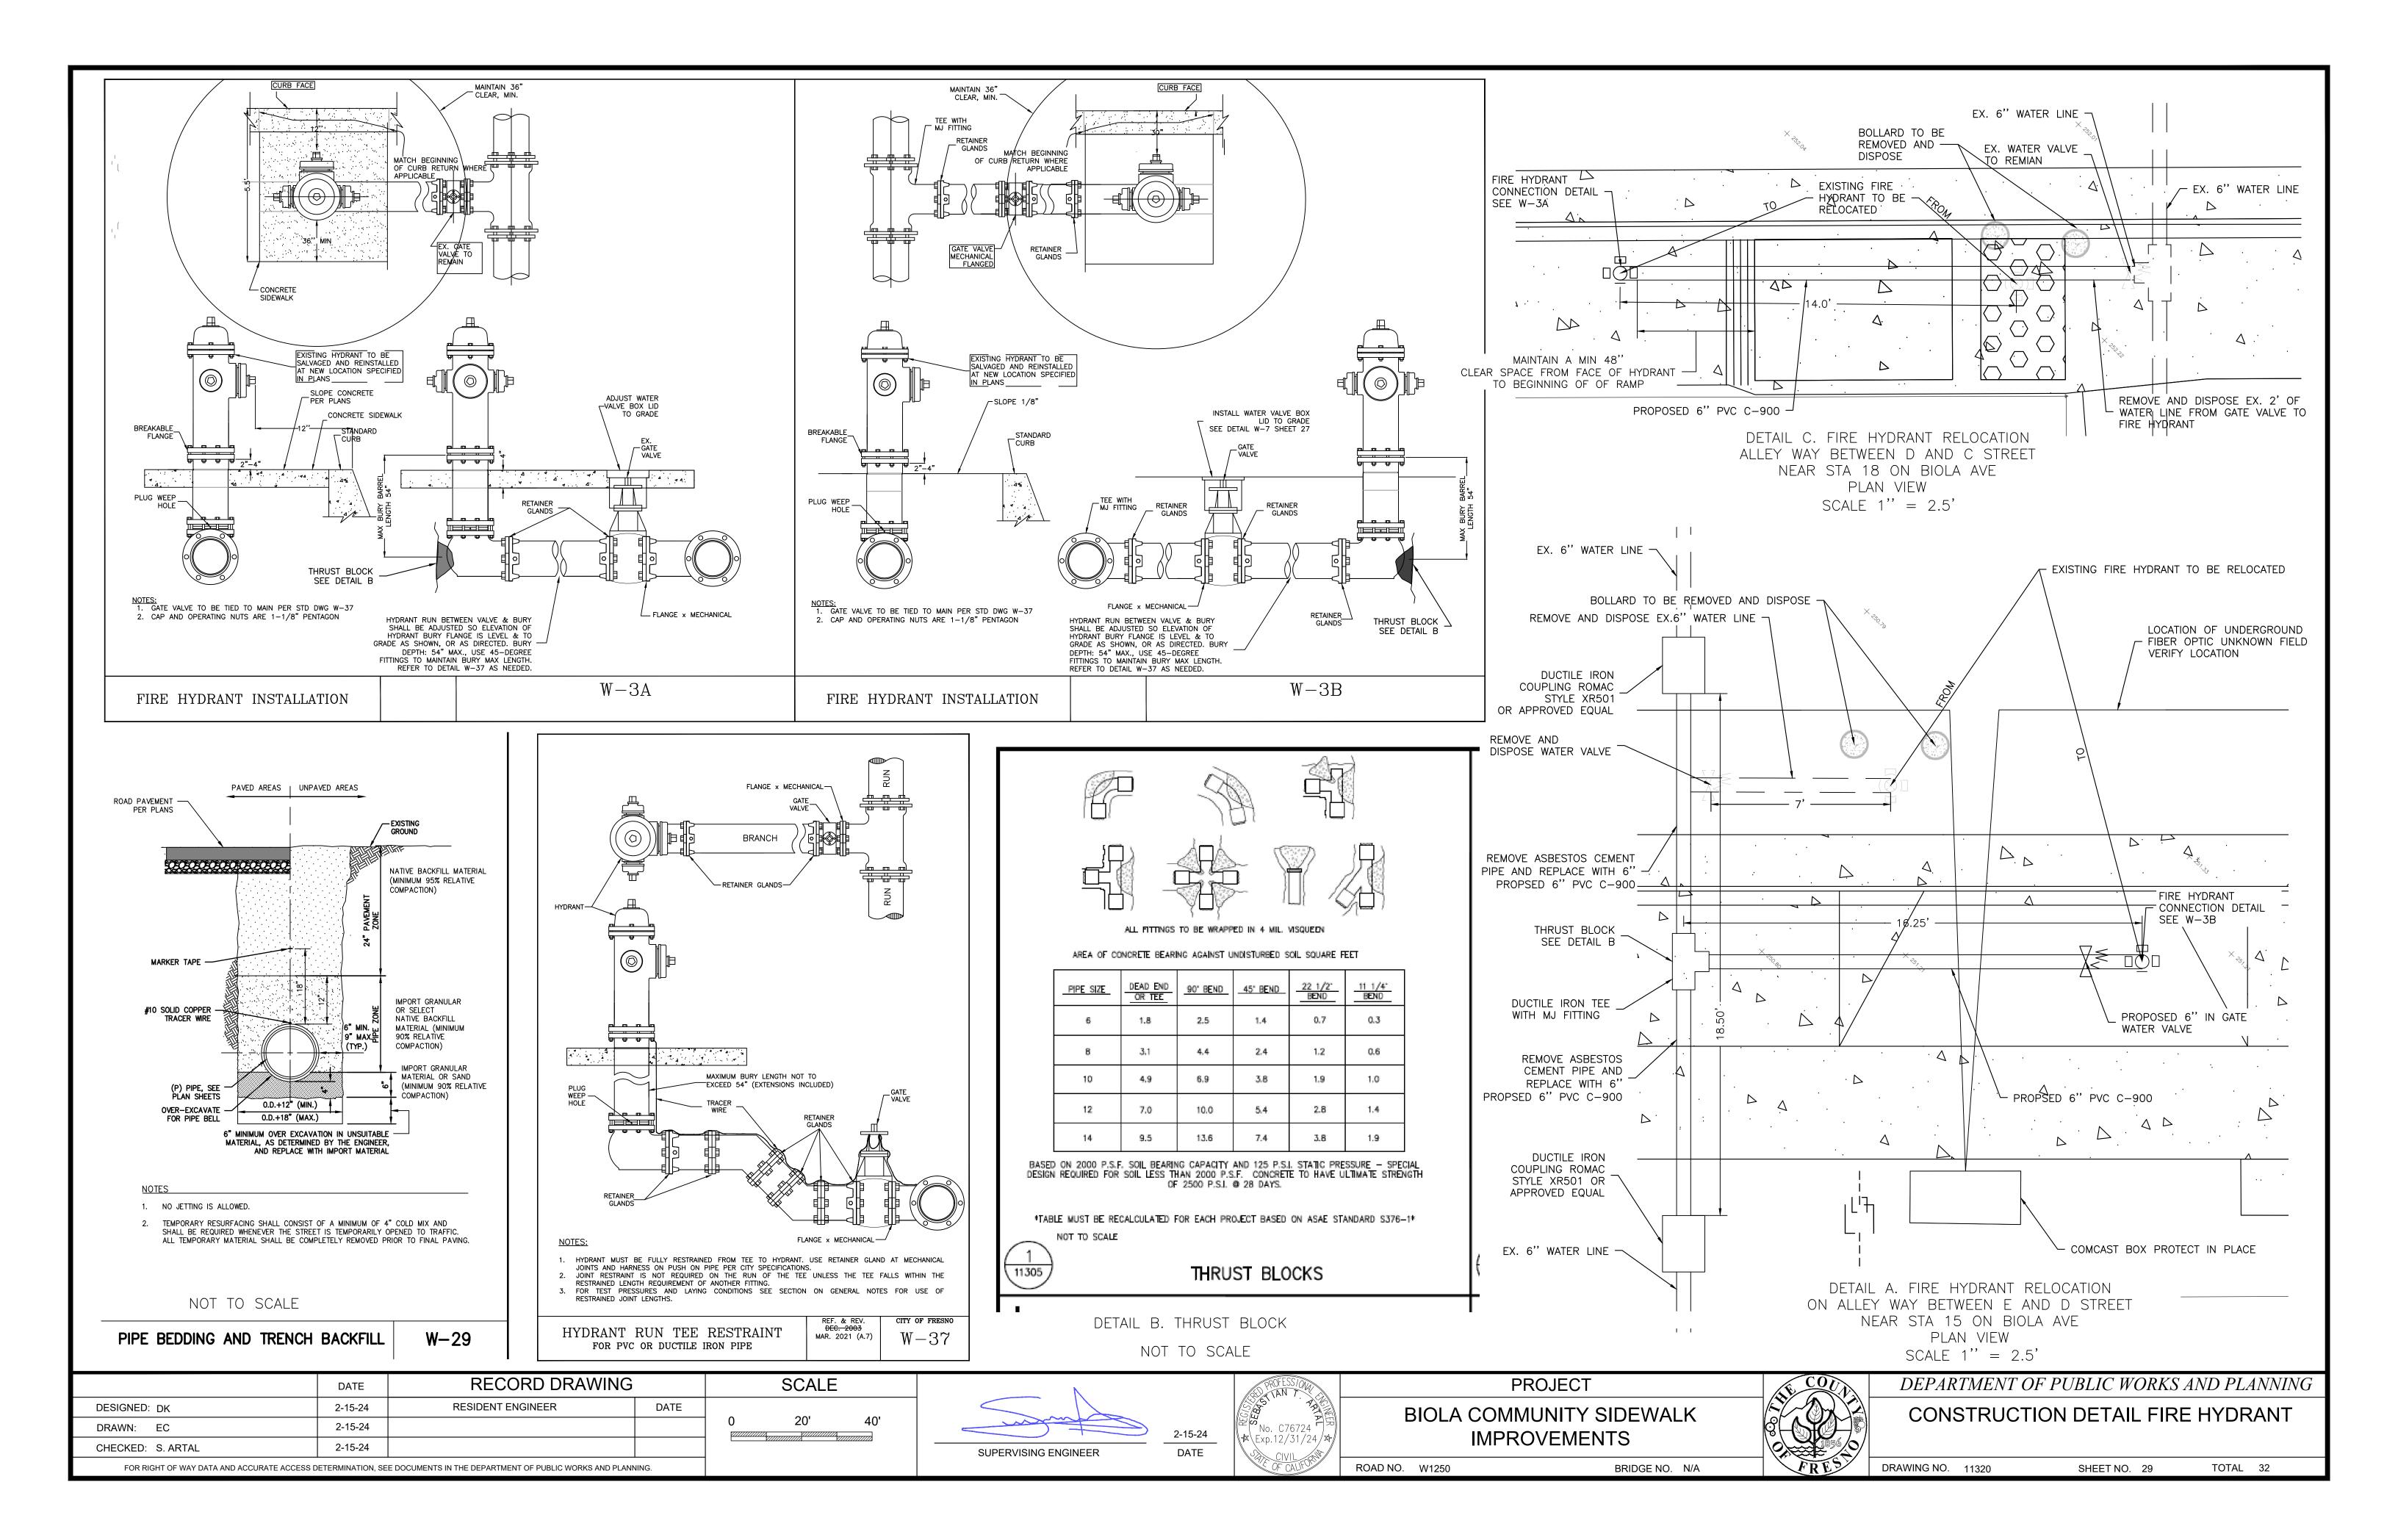

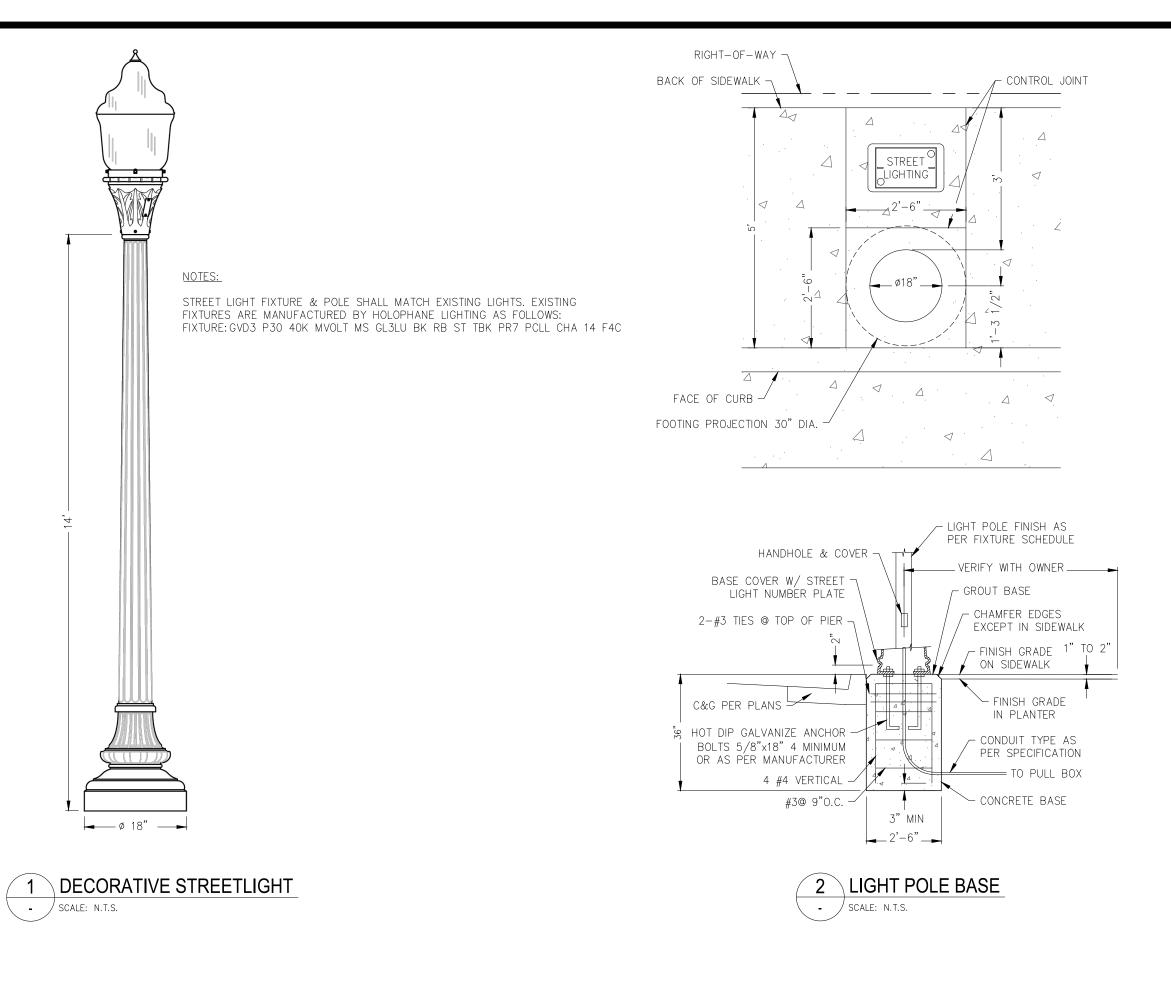

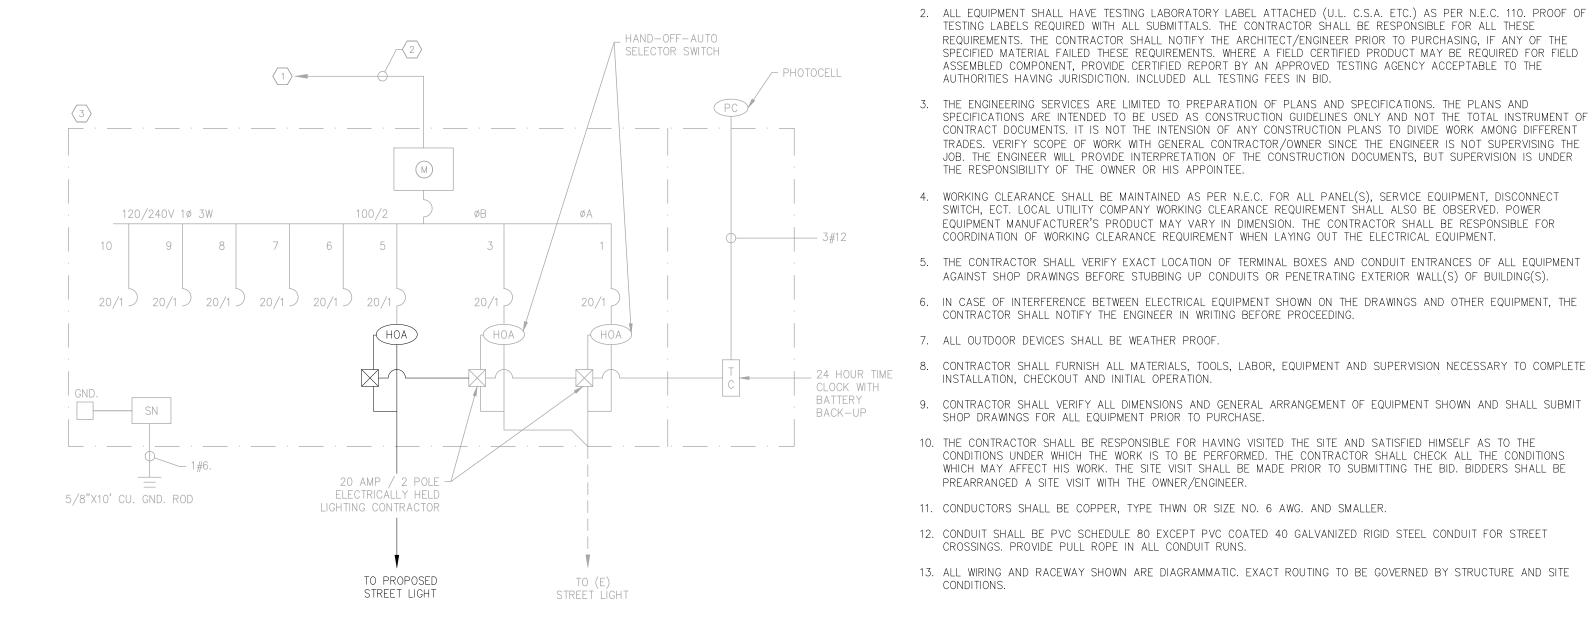

PANEL LINE DIAGRAM

- / SCALE: N.T.S.

∠ 2-NO. 10 TO FIXTURE

SPLICES

- STREET LIGHT POLE

POLE GND -

NO. 8 COPPER -

CONDUCTOR



GENERAL NOTES:

1. IT SHALL BE THE CONTRACTORS RESPONSIBILITY TO CALL UNDERGROUND SERVICE ALERT "USA" BEFORE THE COMMENCEMENT OF ANY EXCAVATION. EACH CONTRACTOR SHALL HAVE THEIR OWN USA TICKET NUMBER FOR EACH PROJECT LOCATION AND SHALL NOT RIDE ON ANY OTHER CONTRACTORS TICKET. CONTRACTOR SHALL NOTIFY THE OWNER 72 HOURS PRIOR TO EXCAVATION.

1. ALL WORK AND MATERIAL SHALL CONFORM TO LATEST CODES AND ORDINANCES. IT IS THE INTENSION OF THESE PLANS AND SPECIFICATIONS TO COVER ALL THINGS REQUIRED TO PROVIDE COMPLETE AND OPERATIVE SYSTEMS. THE CONTRACTOR SHALL FURNISH LABOR, MATERIAL, TRANSPORTATION, EQUIPMENT, MISCELLANEOUS SERVICES, ECT. REQUIRED TO ACCOMPLISH THIS RESULT. ANYTHING WHICH MAY BE REASONABLY CONSTRUED AS A NECESSARY PART OF THE INSTALLATION SHALL BE INCLUDED. NOTHING IN THESE PLANS OR SPECIFICATIONS MAY BE CONSTRUED TO


PERMIT WORK NOT CONFORMING TO ANY CONSTRUCTION CODES.

- 2. THIS CONTRACTOR SHALL PERFORM ALL CUTTING AND PATCHING NECESSARY FOR THE INSTALLATION OF EQUIPMENT AND MATERIALS. ALL PATCHING SHALL ACCURATELY MATCH THE ADJOINING WORK.
- 3. THIS CONTRACTOR SHALL DO EXCAVATING REQUIRED FOR THE INSTALLATION OF THE WORK. UNDERGROUND LINES OUTSIDE THE BUILDINGS SHALL BE INSTALLED WITH A MINIMUM OF 36" OF COVER, EXCEPT DEPTH OF UTILITY SERVICES SHALL COMPLY WITH RESPECTIVE UTILITY COMPANY REQUIREMENTS.
- 4. BEFORE COMPACTION, MOISTEN OR AERATE EACH LAYER AS NECESSARY TO PROVIDE OPTIMUM MOISTER CONTENT. COMPACT EACH LAYER TO REQUIRED PERCENTAGE OF MAXIMUM DRY DENSITY OR RELATIVE DRY DENSITY FOR EACH AREA CLASSIFICATION. DO NOT PLACE BACKFILL OR FILL MATERIAL ON SURFACES THAT ARE MUDDY, FROZEN, OR
- 5. STRUCTURES, BUILDING SLABS, WALKWAYS, AND STEPS: COMPACT TOP 6" OF SUBGRADE AND EACH LAYER OF BACKFILL OR FILL MATERIAL AT 92% MAXIMUM RELATIVE COMPACTION.
- 6. COMPACT TOP 6" OF SUBGRADE MATERIAL AT 85% RELATIVE COMPACTION IN PLANTERS.
- 7. COMPACT TOP 24" OF SUBGRADE IMMEDIATELY BENEATH THE BASE COARSE AT 95% MINIMUM RELATIVE COMPACTION IN STREET AREAS.
- 8. ANY SURPLUS EXCAVATION RESULTING FROM THESE EXCAVATIONS SHALL BE HAULED OFF.
- 9. AFTER ALL TRENCHES HAVE BEEN TAMPED IN, RAKE OUT ALL HIGH AND LOW AREAS ALONG THE TRENCH LINE. ALL CLODS AND SOLID ROCKS EXPOSED ON THE SURFACE AS A RESULT OF THE EXCAVATION SHALL BE BROKEN DOWN AND OR CLEANED UP. ALL TRENCH LINES SHALL BE RAKED LEVEL WITH EXISTING GRADE.
- 10. ELECTRICAL, NETWORK, OR DATA CONDUIT SHALL NOT BE RUN IN EXCAVATIONS PROVIDED FOR PLUMBING OR HEATING PIPES, UNLESS SEPARATED BY A MINIMUM OF 12 INCHES.
- 11. PATCH ALL TRENCHED AREAS TO MATCH EXISTING.
- 12. HAND EXCAVATE IN AREAS WHERE TRENCHING IS DIFFICULT DUE TO STRUCTURAL OBSTRUCTIONS OR EXISTING UNDERGROUND CONDUIT.
- 13. THE CONTRACTOR SHALL WALK THE SITE WITH THE DISTRICT TO IDENTIFY ALL EXISTING CONDUITS AND PIPES.
- 14. UNDERGROUND ELECTRICAL CONDUIT SHALL HAVE MINIMUM 36" COVER. SAND FILL 4" ABOVE AND BELOW CONDUIT IF NATURE SOIL IS NOT ACCEPTABLE FOR BACKFILL. COMPACTION AND TEST REQUIRED AS PER GENERAL CONDITION SPECIFICATIONS OF EARTH WORK SECTION OR MINIMUM OF 95% COMPACTION REQUIRED.







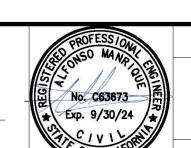

HAND HOLE

POLE GND

ALTERNATE

NO. 3 1/2 PULLBOX PHASE A

PHASES

── TO END OF

PROJECT BIOLA SHOULDER & SIDEWALK IMPROVEMENTS

∠ 2-NO. 10 TO FIXTURE

- STREET LIGHT POLE

AFTER INSPECTION,

NO. 6 CONDUCTORS

→ FROM SERVICE POINT

NO. 6 COPPER CONDUCTOR (120 VAC) BLK

NO. 6 COPPER CONDUCTOR (NEUTRAL) WHT

NO. 6 COPPER CONDUCTOR (120 VAC) RED NO. 8 COPPER CONDUCTOR GREEN

- SPLICES

- HAND HOLE (WELD COVER

DEPARTMENT OF PUBLIC WORKS AND PLANNING

ELECTRICAL DETAILS

Consulting Engineers

5150 N. SIXTH ST SUITE 124, FRESNO, CA P.559.473.1371 F.559.513.8449

DRAWING NO. 11320 SHEET NO. TOTAL 32 32

RECORD DRAWING SCALE DATE RESIDENT ENGINEER DATE DESIGNED: A. MANRIQUE 12/20/23 12/21/23 DRAWN: L. ALANIZ CHECKED: A. MANRIQUE 12/22/23 FOR RIGHT OF WAY DATA AND ACCURATE ACCESS DETERMINATION, SEE DOCUMENTS IN THE DEPARTMENT OF PUBLIC WORKS AND PLANNING

CURB GRADE OR FLUSH

TREADED GROUNDED BUSHING

SEAL AROUND CONDUIT, BOX AND EXTENSION JUNCTION W/ MORTAR

PRECAST REINFORCED EXTENSION

AWG THROUGHOUT THE SYSTEM.

BONDING JUMPER SHALL BE #8 BARE SOLID COPPER FOR PVC-GREEN #8

\$15 ROOFING PAPER BETWEEN GROUT

IN WALK

CONCRETE BOX

5/8" X 8' COPPER CLAD GROUND ROD WITH GROUNDING

CLAMP "AT PULL BOX W/ SERVICE FUSE".

GRC ONLY)

STREET

LIGHTING

PEA GRAVEL

PULL BOXES SHALL BE #3 1/2 AS PER CAL TRANS STANDARD SPECIFICATION OR CHRISTY N-9
OR APPROVED EQUAL. LIDS SHALL HAVE HOLD DOWN BOLTS.

PULL BOXES SHALL BE GROUTED PRIOR TO INSTALLATION OF CONDUCTORS, SLOPED TOWARD THE DRAIN HOLE. PLACE A LAYER OF ROOFING PAPER BETWEEN THE CRUSHING ROCK AND THE GROUT

5. FUSE AT POINT OF SERVICE SHALL BE 60A IF #6 CONDUCTOR AND 40A IF #8 CONDUCTOR AND SHALL HAVE A TRON TYPE FUSE HOLDER. (SINGLE POLE)

4 STREETLIGHT PULLBOX

6. INSTALL A ONE—FOOT RING OF CONCRETE, FOUR INCHES DEEP, AROUND THE WRAPPED PULL BOXES INSTALLED IN DIRT AREAS. SLOPED TO DRAIN AWAY FROM THE PULL BOX.

WHEN PULL BOXES ARE LOCATED ADJACENT TO STREET LIGHT, EXTEND CONCRETE RING TO INCLUDE 12" CIRCUMFERENCE AROUND POLE.

8. PULL BOXES TO BE INSTALLED PARALLEL TO STREET AND/OR CURB OR GUTTER.

- / SCALE: N.T.S.

9. EACH PULL BOX WILL HAVE A LOCKABLE CAST IRON CHRISTY BOX LID.

TYPE "LFNC" FLEX-CONDUIT RATED

FOR DIRECT BURIAL

(NOT TO EXCEED 6')

GROUT

6"

3. PULL LIDS BEFORE POURING CONCRETE AROUND PULL BOXES. 4. WRAP PULL BOX WITH ROOFING PAPER BEFORE BACKFILLING.

> DATE SUPERVISING ENGINEER

- SPARE CONDUIT

FINISH GRADE

TRENCH SECTION

LIGHTING CIRCUIT CONDUIT

SHALL BE BELOW 36"

NO. 3 1/2 PULLBOX

PHASE B

ROAD NO. W1250 BRIDGE NO. N/A