
SANTIAGO

PANEL MARK NO. KEY PLAN

NOTES

- 1. BUILDING IS DESIGNED TO COMPLY WITH THE 2019 CALIFORNIA BUILDING STANDARDS CODE (CBSC).
- 2. DESIGN COMPLIES WITH THE PROVISIONS OF THE 2019 CBSC CODE FOR THE FOLLOWING LOADS: GROUND SNOW LOAD = 220 PSF $FLOOR\ LOAD\ =\ 400\ PSF$ IBC DESIGN SPECTRAL RESPONSE $S_S = 1.309$, $S_1 = 1.088$ SITE CLASS D RISK CATEGORY: II SEISMIC DESIGN CATEGORY: E BEARING WALL SYSTEM R = 4.0BASIC WIND SPEED = 150 MPH (3-SECOND GUST) WIND EXPOSURE C
- 3. CONSTRUCTION TYPE: V-B EXTERIOR WALLS: 1-HR RATED PER IBC TABLE 721.1(2), ITEM 4-1.1 MINIMUM FIRE SEPARATION DISTANCE: 10'
- 4. CONCRETE STRENGTH f'ci = 2500 PSI INITIAL f'c = 5000 PSI FINAL AIR ENTRAINMENT $6\% \pm 1 \frac{1}{2}\%$ IN PLASTIC CONCRETE. REINFORCING STEEL: #3 GRADE 40, #4 AND LARGER GRADE 60 MINIMUM LAP 18" AT SPLICES. TIE BARS WITH DOUBLE ANNEALED 16 GA IRON WIRE. REINFORCING TO BE PLACED IN CENTER OF PANEL UNO. WELDED WIRE FABRIC(W.W.F.): 4x4xW8xW8, Fy=65 KSI (OR EQUIVAL). COMPLY WITH ASTM A82, SMOOTH WIRE, MIN, LAP 2 SQUARES.
- 5. EMBEDDED ITEMS IDENTIFIED ON DRAWINGS (i.e. PS-2, R301) REFER TO CXT STANDARD EMBEDMENT CATALOG.
- 6. BACK OF PANELS TO HAVE SMOOTH TROWEL FINISH UNO. ALL SURFACES TO BE TEXTURED ARE NOTED ON PANEL DWG'S
- 7. REFER TO SEPARATE CXT INCORPORATED SPECIFICATIONS COVERING DESIGN, MATERIALS, PRODUCTION, AND INSTALLATION CRITERIA FOR SPECIFIC STYLE OF BUILDING.
- 8. ALL REBAR BENDS ARE TO HAVE A MINIMUM RADIUS OF 6x THE BAR DIAMETER
- 9. INSTALLATION TO MEET APPLICABLE LOCAL, STATE & FEDERAL CODES, BY OTHERS.
- 10. ADEQUATE PLUMBING FACILITIES MUST BE PROVIDED IN ACCORDANCE WITH 2019 CBSC (NOT BY CXT)
- 11. ACCESSIBLE ROUTE TO BE PROVIDE BY OTHER ON SITE (NOT BY CXT).

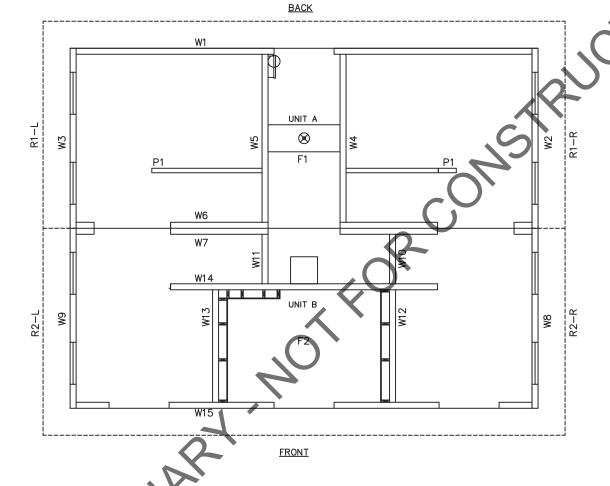

2019 CALIFORNIA BUILDING STANDARDS CODE CALIFORNIA CODE OF REGULATIONS, TITLE 24

SPECIAL CONDITIONS AND/OR LIMITATIONS

ACCESSIBILITY TO THIS BUILDING, INCLUDING PARKING, IS TO BE PROVIDED BY OTHERS AND CONSTRUCTED IN ACCORDANCE WITH THE LOCAL BUILDING CODES.

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STATE OF CALIFORNIA DESIGN APPROVAL AGENCY

PEI 20-4411

08/24/2020

11/24/2021

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PLAN APPROVAL NO.: APPROVED BY: DATE APPROVED: DATE OF EXPIRATION:

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NDEX OF DRAWINGS

TITLE COVER SHEET HANDLING INSTRUCTIONS S-03 FLOOR PLAN **BUILDING ELEVATIONS** S-04 S-05 **BUILDING ELEVATIONS** INTERIOR RESTROOM ELEVATIONS S-06 S-07 **DETAILS** S-08 WALL PANEL MARK W1 WALL PANEL MARK W2 S-09 WALL PANEL MARK W3 S-10 WALL PANEL MARK W4 S-12 WALL PANEL MARK W5 S-13 WALL PANEL MARK W6 WALL PANEL MARK W7 S-14 WALL PANEL MARK W8 S-15 WALL PANEL MARK W9 S-16 WALL PANEL MARK W10 & W11 S-17 S-18 WALL PANEL MARK W12 WALL PANEL MARK W13 S-19 WALL PANEL MARK W14 S-20 WALL PANEL MARK W15 S-21 S-22 FLOOR SLAB MARK F1 FLOOR SLAB MARK F2 S-23 S-24 ROOF SLAB MARK R1-R S-25 ROOF SLAB MARK R1-L S-26 ROOF SLAB MARK R2-R ROOF SLAB MARK R2-L S-27 INTERIOR PANEL MARK P1 (2 REQUIRED) S-28 FOUNDATION DETAIL S-29 FLOOR DRAIN LOCATIONS & BELOW FLOOR PIPING S-30 PLUMBING PLANS S-31

S-32 PLUMBING PLAN & DIAGRAMS PLUMBING DETAILS, DIAGRAMS & SCHEDULES S-33

S-34 **ELECTRICAL SCHEDULES** S-35 ELECTRICAL PLAN

MATERIAL LIST S-36 S-37 MATERIAL LIST

OF CALIFO August 23, 2020 Precast Products

6707 E. Flamingo Ave. Bldg 300, Nampa, ID 83687 901 N. Highway 77 Hillsboro, TX 76645 362 Waverly Road Williamstown, WV 26187

> SANTIAGO BUILDING NUMBER S-301

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		CXT Incom	porate	d		
REV.		DESCRIPTION		APPROVA		DATE
SCA	LE	3/16"=1'-0	DAT	Ε	(6-03-20
DRA	WN	FM5	FILE	NO.	5	S-301
CHE	CKED	FM5	PLO [®]	T	-	64
		COVED	CII	ССТ		

COVER SHEET

S-01

DWG NO.

TOTAL THICKNESS = -1/8, +1/4 VARIATION FROM SQUARE = ±1/8 PER 6 FT OF LOCAL SMOOTHNESS = 1/4" IN 10 FT SWEEP = ±1/4" POSITION OF TENDONS = ±1/4" POSITION OF BLOCKOUTS = ±1/4" SIZE OF BLOCKOUTS = ±1/4"

TIPPING AND FLUSHNESS OF PLATES = +1/16, -1/4

CASTING TOLERANCES

BOWING = LENGTH/360 END SQUARENESS = ±1/8' CALIFORNIA STATE TAG, APPROVAL AND PE DRAWINGS REQUIRED

WALL TEXTURE: BARNWOOD WALL COLOR: LIBERTY TAN


ROOF TEXTURE: CEDAR SHAKE ROOF COLOR: HUNTER GREEN

TRIM PAINT:

RICH BROWN

NOTES:

- 1. THE SANTIAGO STYLE BUILDING CONSISTS OF TWO SEPARATE UNITS TO BE PLACED AND JOINED AT THE PROJECT SITE. PROPER SITE PREPARATION AND HANDLING IS ESSENTIAL FOR THE SAFE AND PROPER INSTALLATION OF THE BUILDING.
- 2. PROVIDE SHALLOW TRENCH WITH ROLLED EDGES ALONG BUILDING JOINT LINES TO PREVENT TRAPPING MATERIAL BETWEEN UNITS BEING DRAWN TOGETHER.
- 3. PLACE UNITS AS CLOSE TO ONE ANOTHER AS POSSIBLE.
 SPACE BETWEEN UNITS SHOULD NOT EXCEED 1" AT INITIATION OF POST—TENSIONING. MAXIMUM ALLOWABLE FINISH JOINT SPACE BETWEEN UNITS SHALL BE 1/2".
- 4. POST-TENSIONING TO DRAW UNITS INTO CONTACT SHALL BE ACCOMPLISHED WITH EQUIPMENT PROVIDED BY CXT BY PROPERLY TRAINED PERSONNEL. INSTRUCTIONS PROVIDED BY CXT SHALL BE CAREFULLY ADHERED TO. ALL NECESSARY SAFETY PRECAUTIONS SHALL BE TAKEN BY INSTALLATION PERSONNEL. STRESS TENDONS TO DRAW UNITS TOGETHER AND TO RETAIN A MINIMUM EFFECTIVE FORCE IN EACH TENDON OF 2 KIPS AFTER ALL LOSSES.
- 5. AFTER COMPLETION OF BUILDING PLACEMENT, BLOCKOUTS AT POST-TENSIONING ANCHORAGE POINTS SHALL BE FILLED WITH NON-METALLIC, NON-SHRINK GROUT. PROVIDE SMOOTH, NEAT FINISH COMPATIBLE WITH SURROUNDING CONCRETE SURFACES. MATCH CONCRETE COLOR.
- 6. PROVIDE UTILITY CONNECTIONS (PLUMBING & ELECTRICAL) AS REQUIRED AND/OR AS CALLED FOR ON THE DRAWINGS.
- 7. FILL FLOOR BLOCKOUTS AFTER COMPLETION OF UTILITY HOOKUPS WITH CONCRETE. SLOPE TO DRAIN.

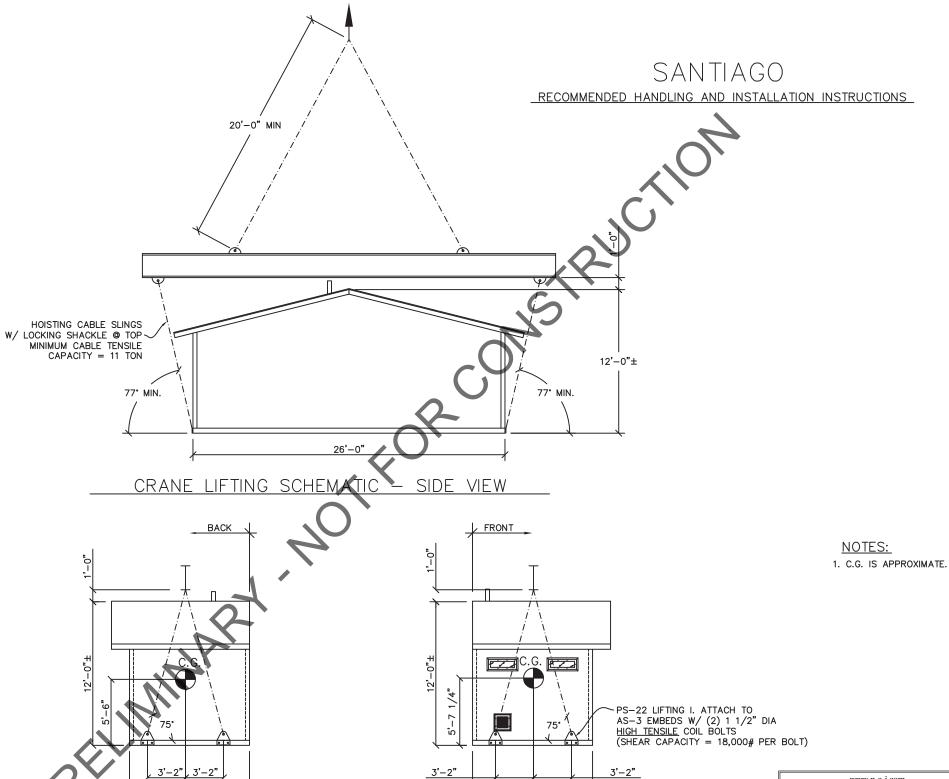

<u>5'-</u>1"

5'-4"

4'-11"

UNIT B

CRANE LIFTING SCHEMATIC - END VIEW

UNIT A

SHIPPING WEIGHTS AND DIMENSIONS S-301 SECTION WEIGHT LENGTH HEIGHT WIDTH 26'-0" 11'-6" 12'-0" A (BACK) 74,700 77,900 26'-0" 11'-6" 12'-0" B (FRONT)

58640 STATE ROAD 15 GOSHEN, INDIANA 46528 (574) 533-0337 - Phone (574) 533-9736 - Fax

STATE OF CALIFORNIA APPROVED

PLAN APPROVAL NO.: APPROVED BY: DATE APPROVED: DATE OF EXPIRATION:

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NOTES:

PEI 20-4411 IPH 08/24/2020 11/24/2021

ITEM QTY P.T. CABLE 26'-0" 4 CHUCKS & WEDGES 8 GROUT I BAGS SQ. FT. W.W.F. CU. FT. CONC.

EMBEDDED MATERIALS

OF CALIFOR

August 23, 2020




6707 E. Flamingo Ave. Bldg 300, Nampa, ID 83687 901 N. Highway 77 Hillsboro, TX 76645 362 Waverly Road Williamstown, WV 26187

> SANTIAGO BUILDING NUMBER S-301

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		CXT Incom	porate	d		
REV.		DESCRIPTION		APPROVA	7	DA
SCA		1/8"=1'-0"	DAT	E	0	7-15
DRA	WN	FM5	FILE	NO.	S	-301
CHE	CKED	FM5	PLO	T	9	16
	НАК	IDLING IN	ISTE	SHCTI	71	12

S-02



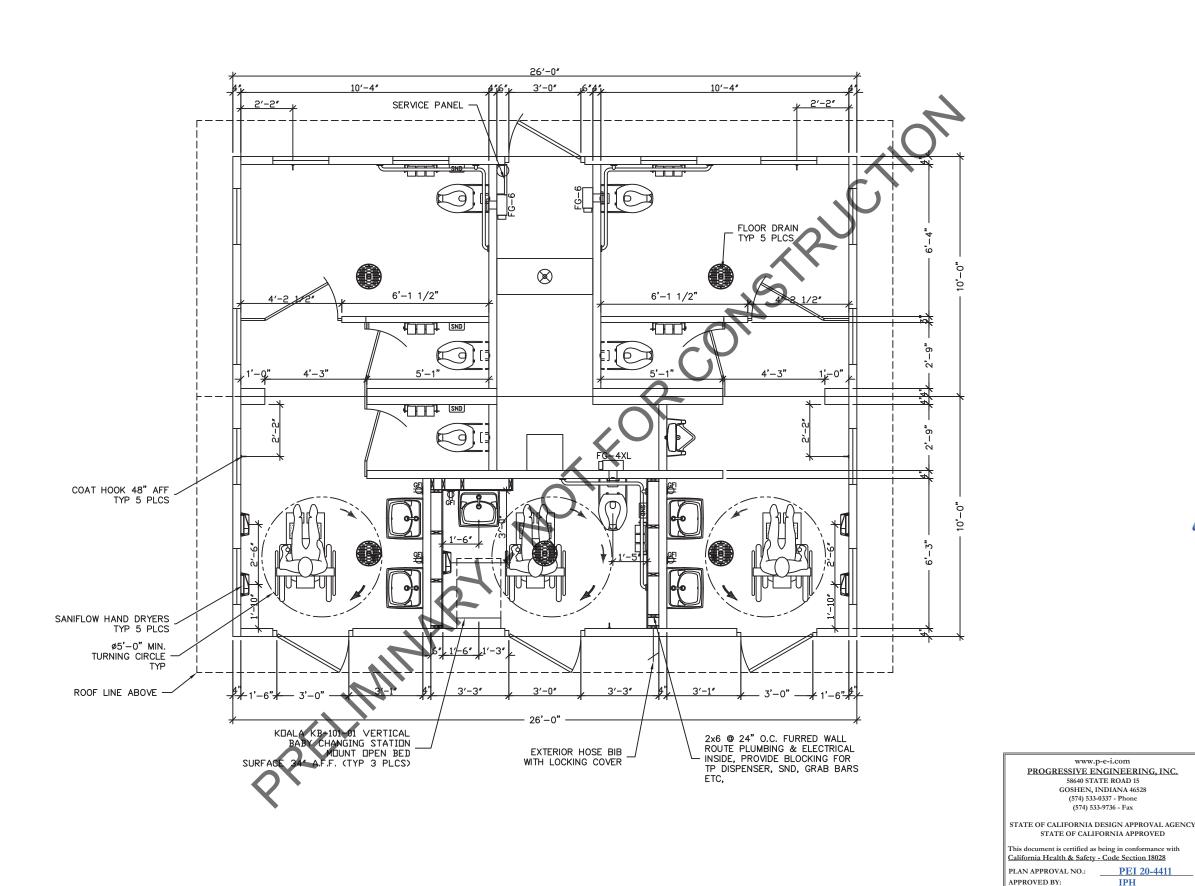

August 23, 2020



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		CXT Inco	porate	d		
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DRA	WN	FM5	FILE	NO.	1	301
CHE	CKED	FM5	PLO.	T	4	18
		FLOOR				

FLOOR PLAN

DWG NO. S-03

(574) 533-9736 - Fax

DATE OF EXPIRATION: 11/24/2021


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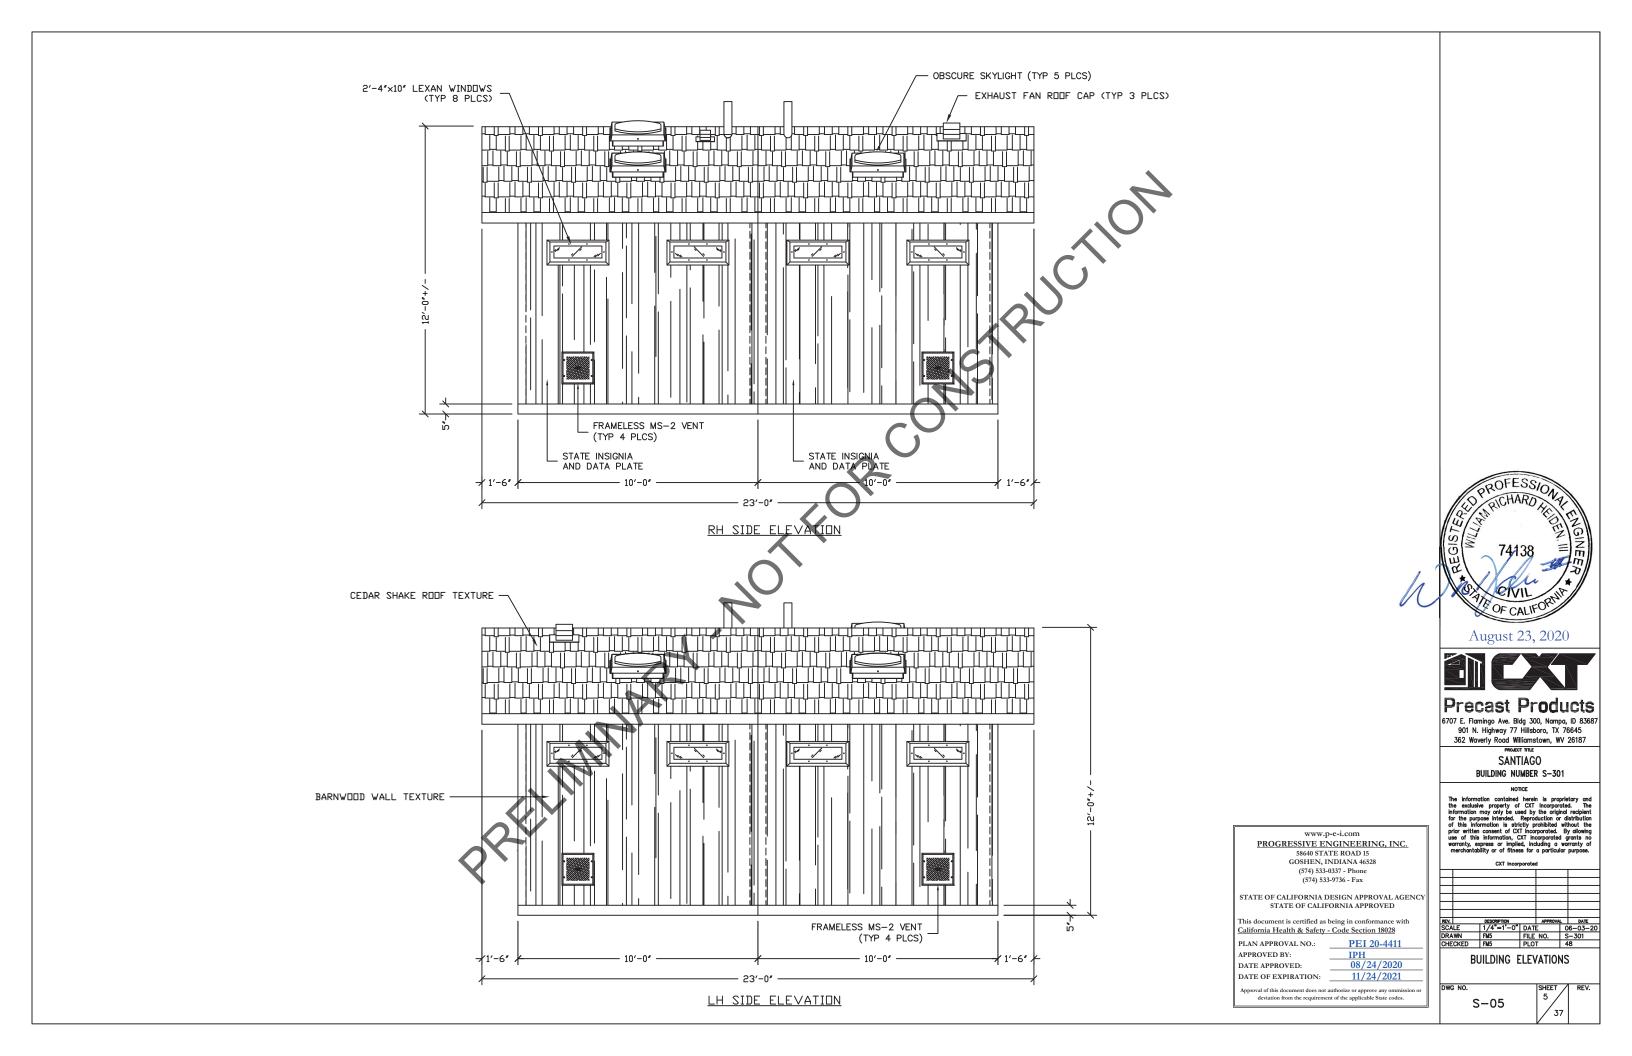
DATE APPROVED:


PEI 20-4411


08/24/2020


IPH




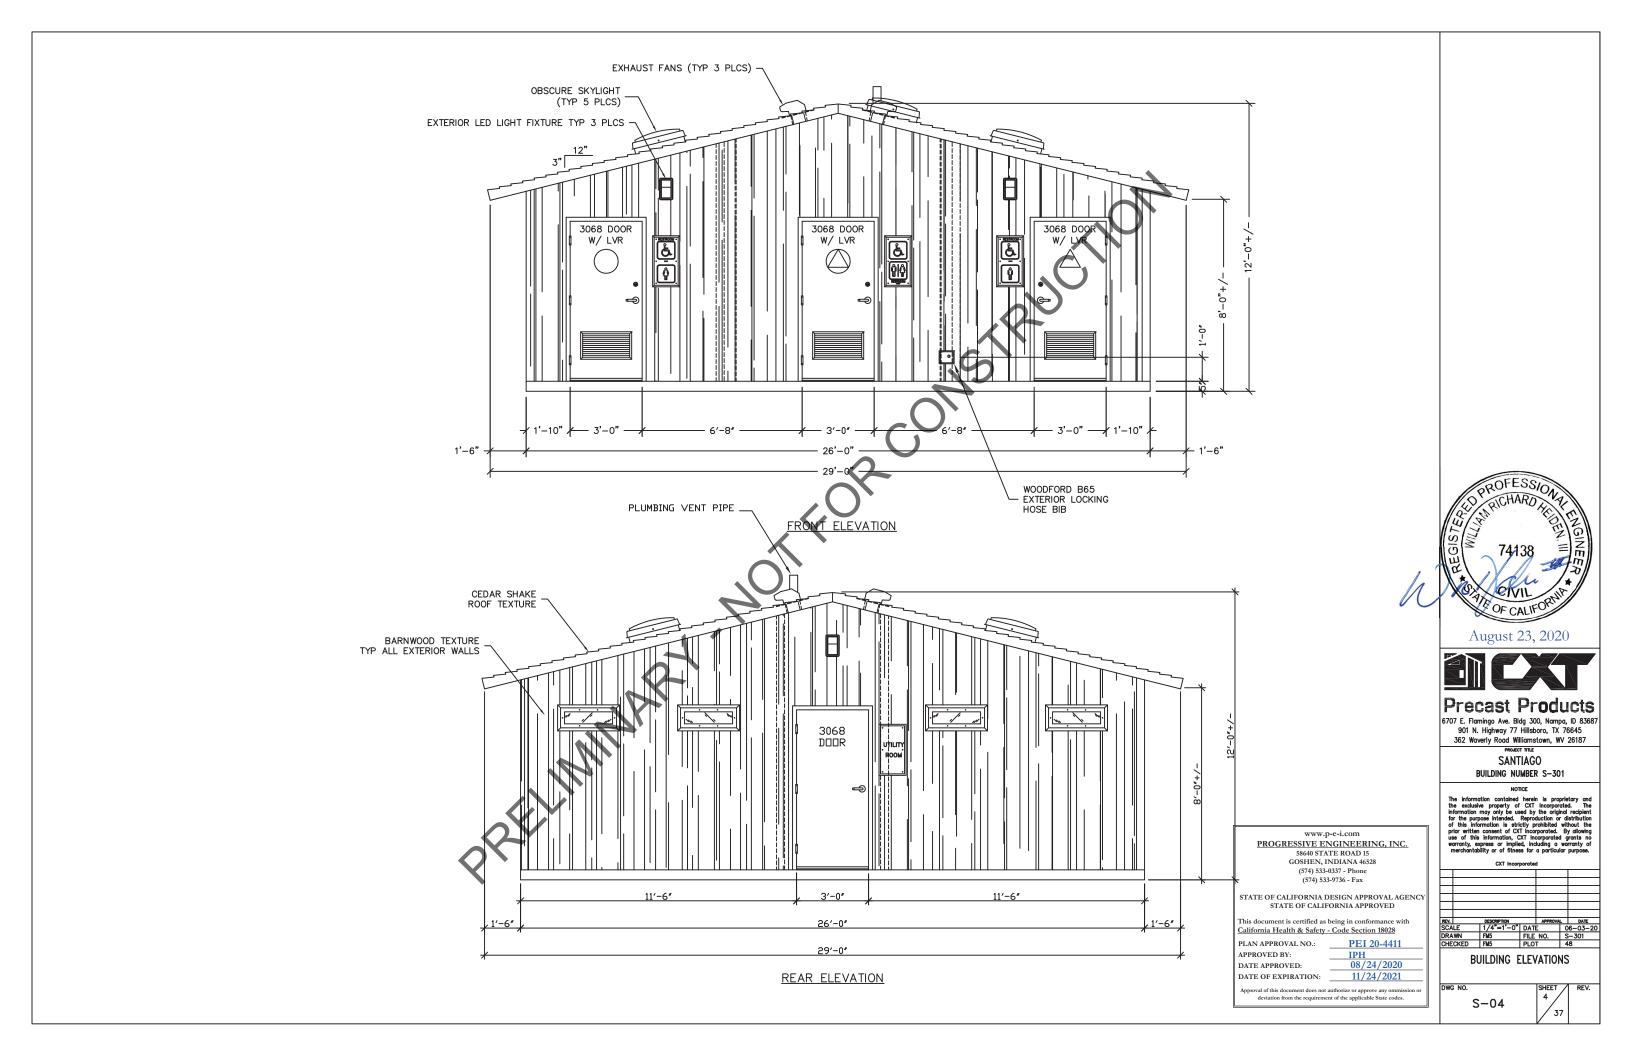

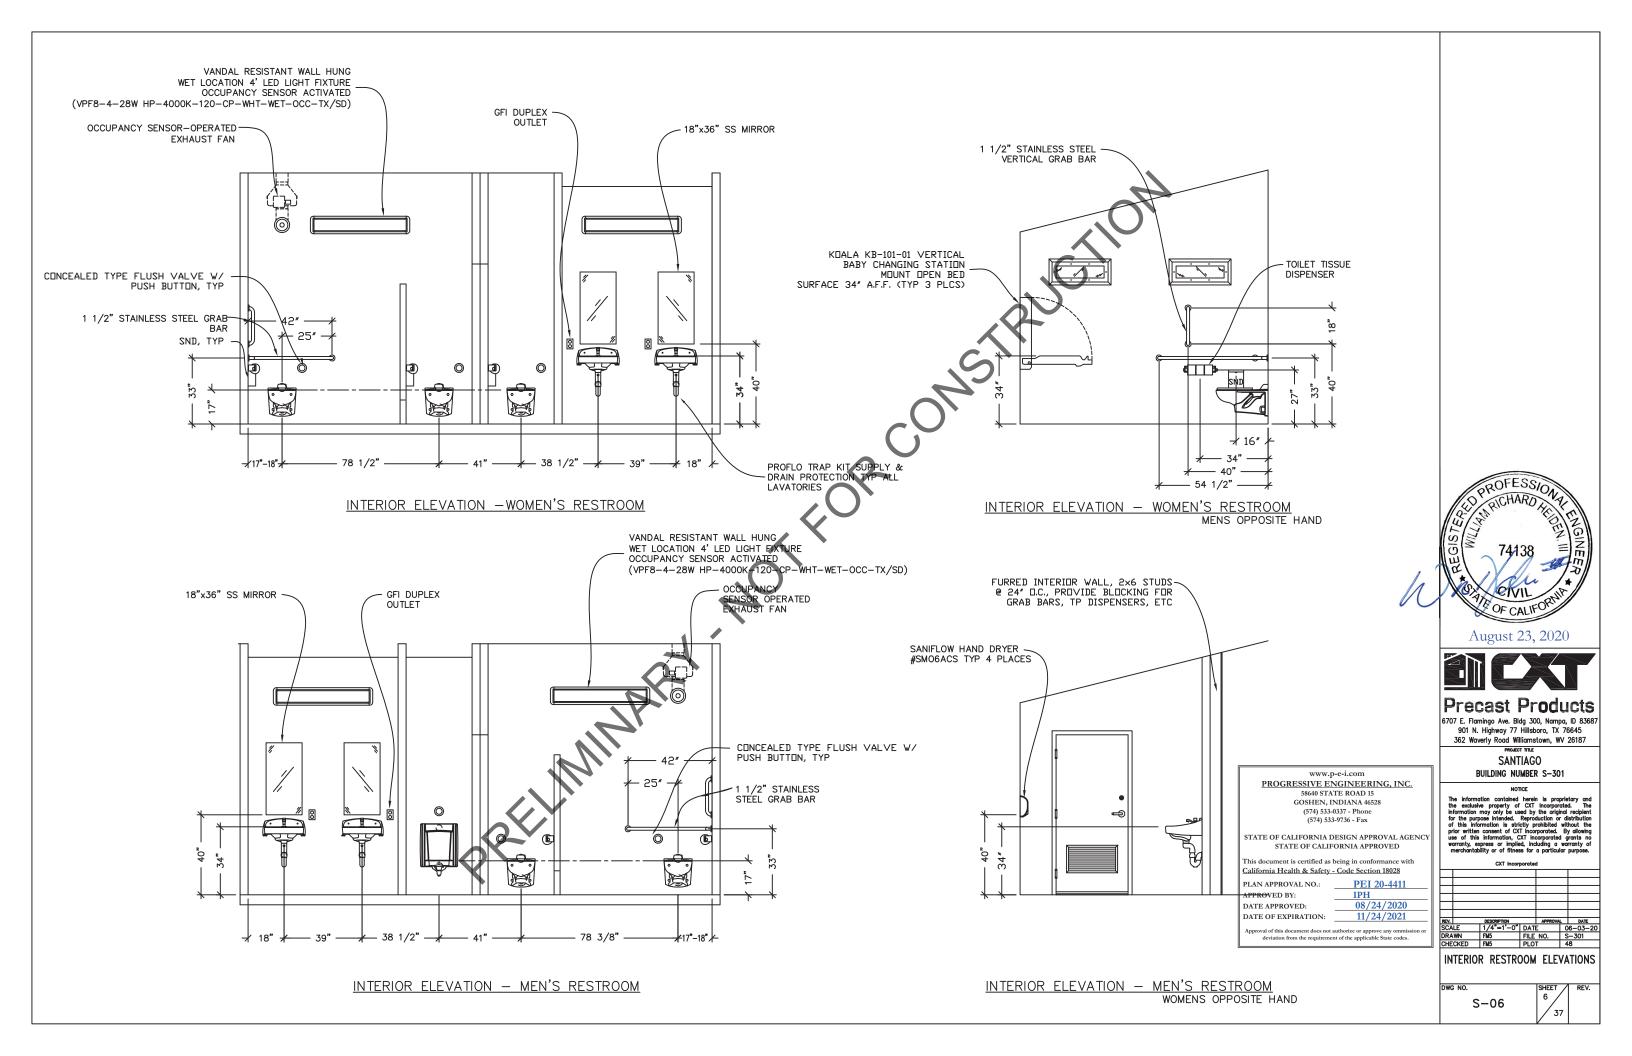

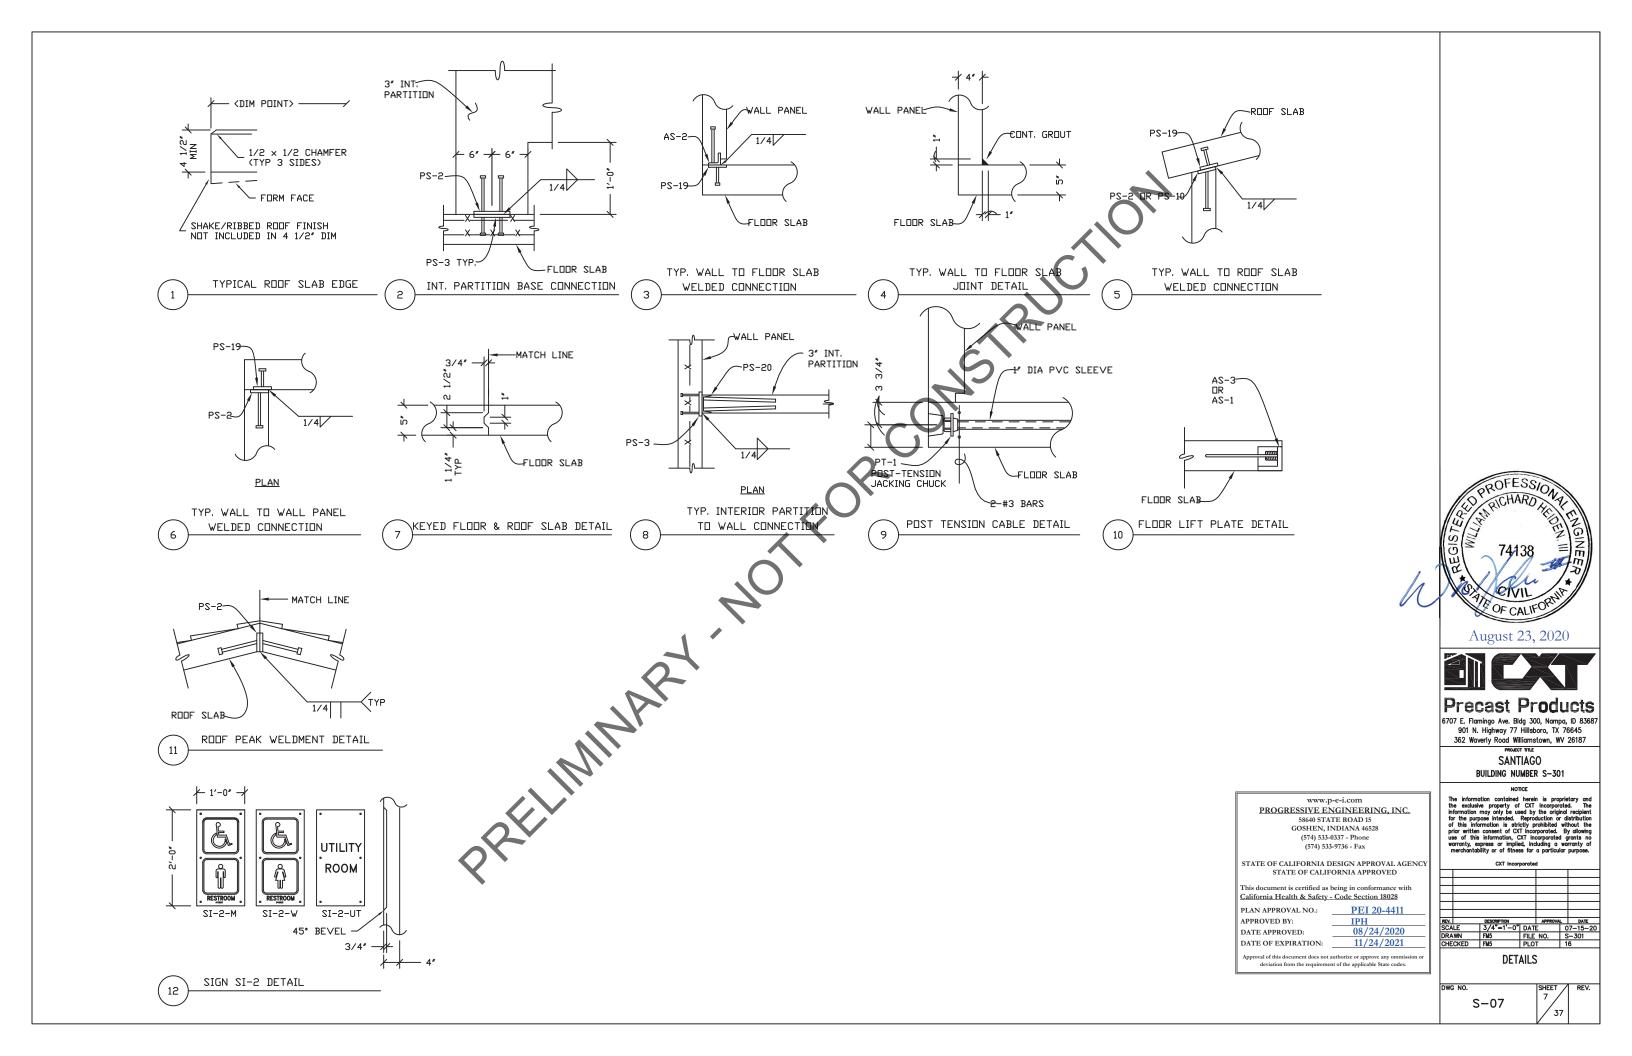

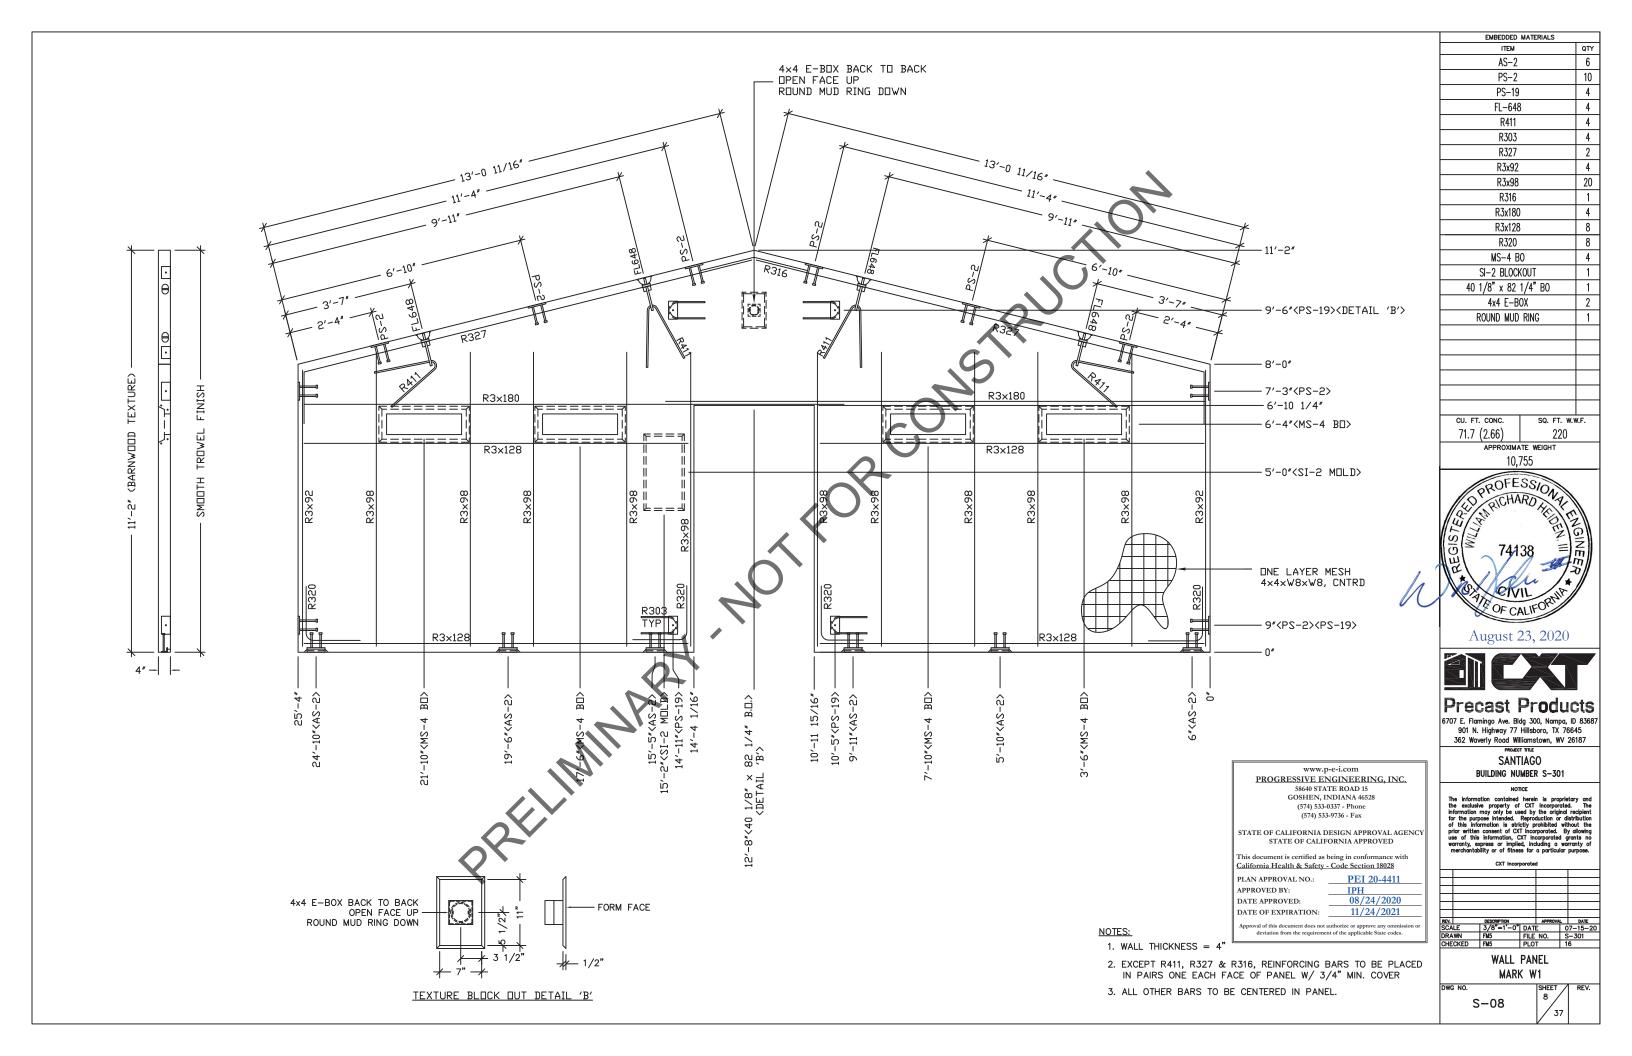

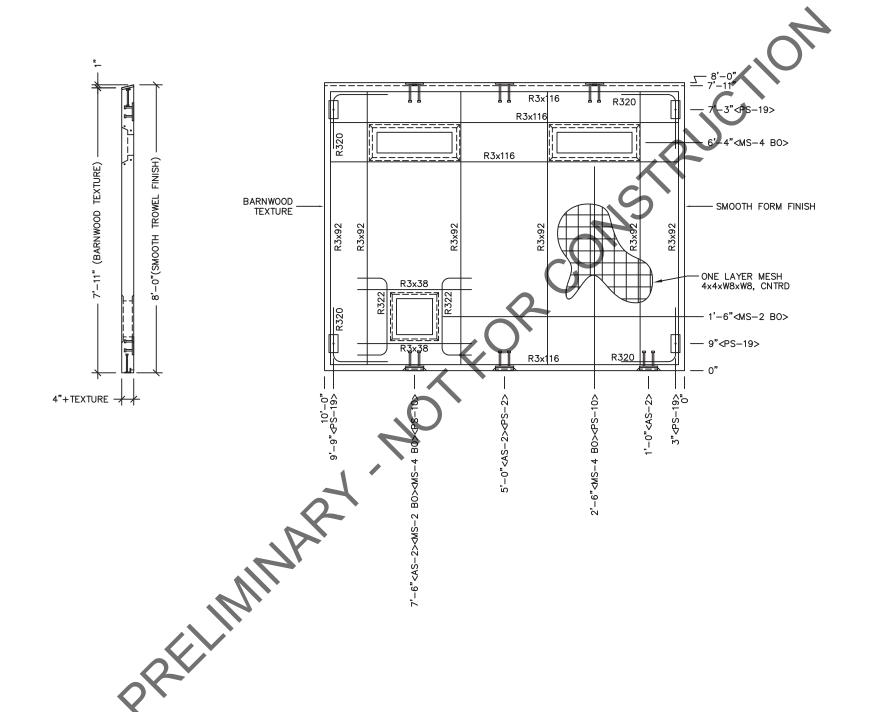

EMBEDDED MATERIALS ITEM QTY AS-2 3 PS-10 2 PS-19 4 R3x38 2 R3x116 8 R3x92 12 R320 8 PS-2 1 2 MS-4 BO MS-2 B0 R322 2 CU. FT. CONC. SQ. FT. W.W.F. 25.4 (0.94) 80 APPROXIMATE WEIGHT 3,810

PROFESSION PROFESSION

August 23, 2020



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> SANTIAGO BUILDING NUMBER S-301

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REV.		DESCRIPTION		APPROVA		DATE
SCA	LE	3/8"=1'-0"	DAT	E		7-15-20
DRA	WN	FM5	FILE	NO.	S	-301
CHE	CKED	FM5	PLO	T	1	6

WALL PANEL MARK W2

DWG NO. S-09

5-09 SHEET 9

NOTES:

1. WALL THICKNESS = 4"

2. EXCEPT R322 & R3x38 REINFORCING BARS TO BE PLACED IN PAIRS ONE EACH FACE OF PANEL W/ 3/4" MIN. COVER

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PROGRESSIVE ENGINEERING, INC.

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08/24/2020

11/24/2021

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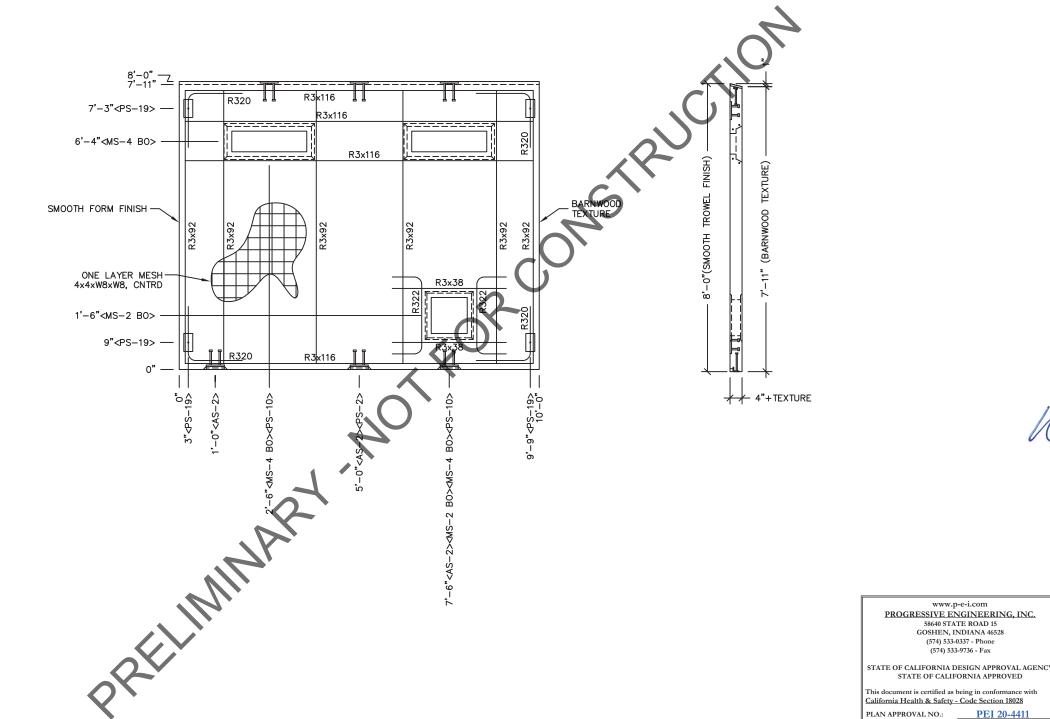
PLAN APPROVAL NO.:

DATE OF EXPIRATION:

APPROVED BY:

DATE APPROVED:

3. ALL OTHER REBAR TO BE CENTERED IN PANEL.



EMBEDDED MA	TERIALS
ITEM	QT
AS-2	3
PS-10	2
PS-19	4
R3x38	2
R3x116	8
R3x92	12
R320	8
PS-2	1
MS-4 B0	2
MS-2 B0	1
R322	2
CU. FT. CONC.	SQ. FT. W.W.F.
25.4 (0.94)	80
APPROXIMATE	
3,810	<u> </u>
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Q QICHAR	SIONARENGE
1877	7191

August 23, 2020



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SANTIAGO BUILDING NUMBER S-301

l		CXT Incor	porate	d		
REV.		DESCRIPTION		APPROVA		DATE
SCA		3/8"=1'-0"	DAT	E	(7-15-20
DRA		FM5	FILE	NO.	5	301
CHE	CKED	FM5	PLO	T	1	6

APPROVED BY:

DATE APPROVED:

DATE OF EXPIRATION:

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08/24/2020

11/24/2021

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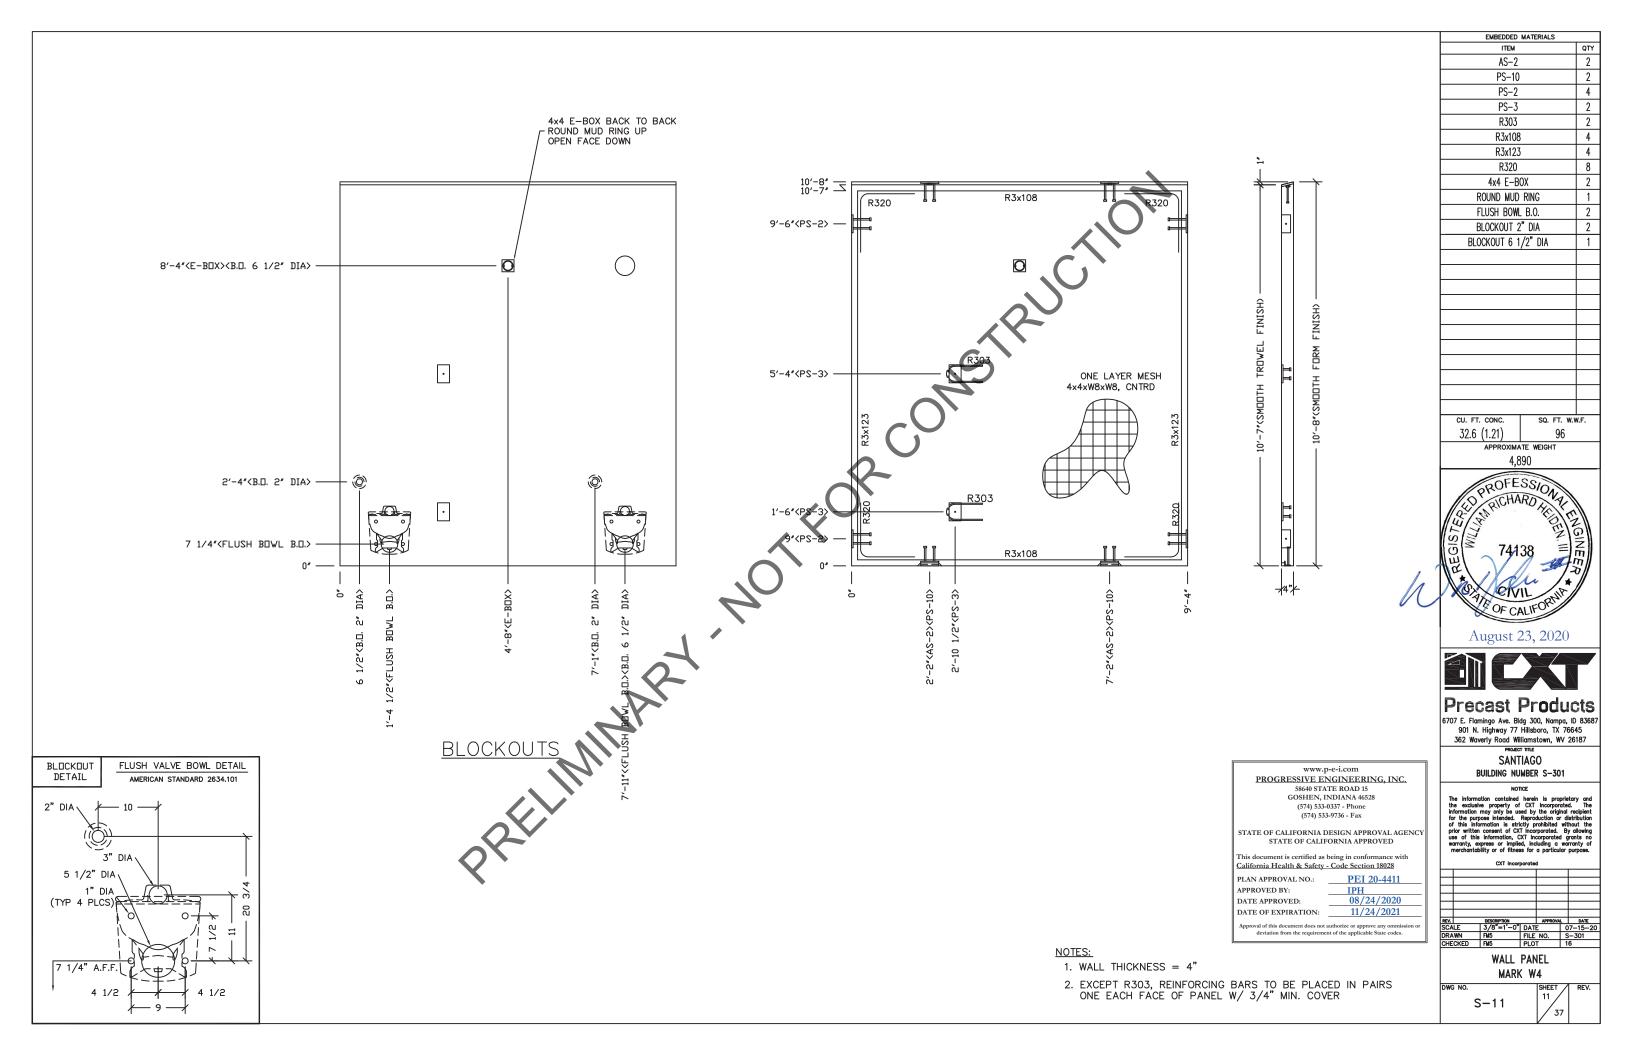
1. WALL THICKNESS = 4"


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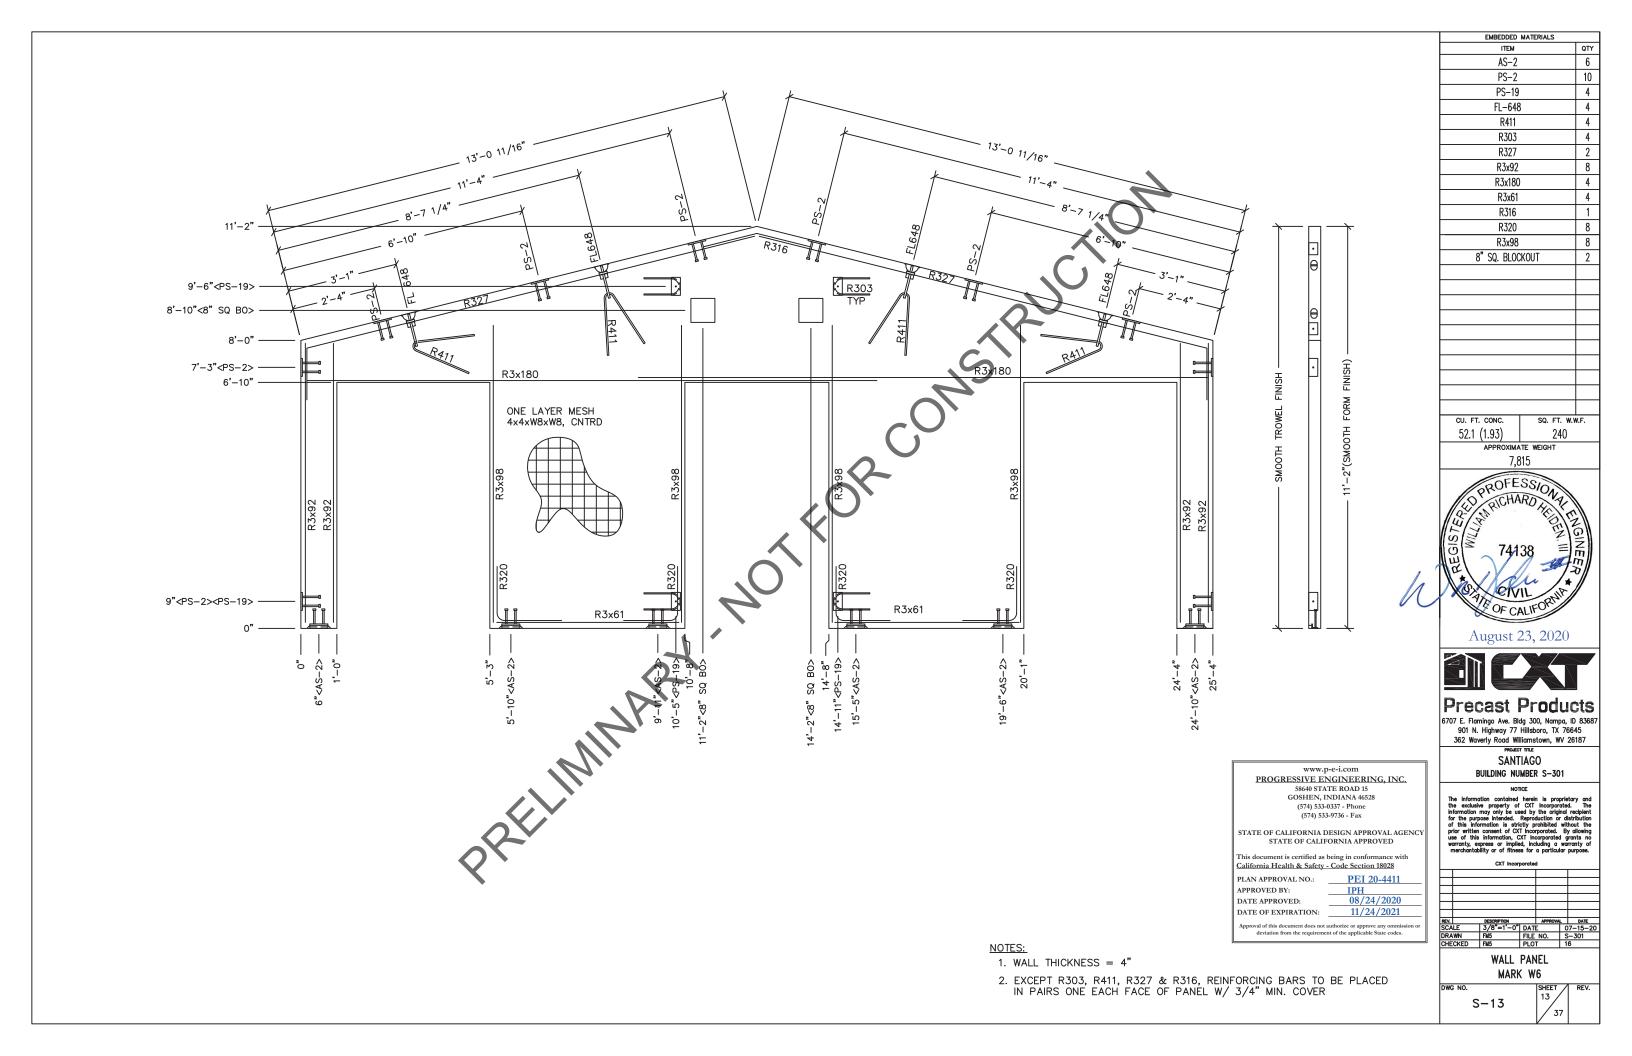
- 2. EXCEPT R322 & R3x38 REINFORCING BARS TO BE PLACED IN PAIRS ONE EACH FACE OF PANEL W/ 3/4" MIN. COVER
- 3. ALL OTHER REBAR TO BE CENTERED IN PANEL.


WALL PANEL MARK W3


DWG NO. S-10





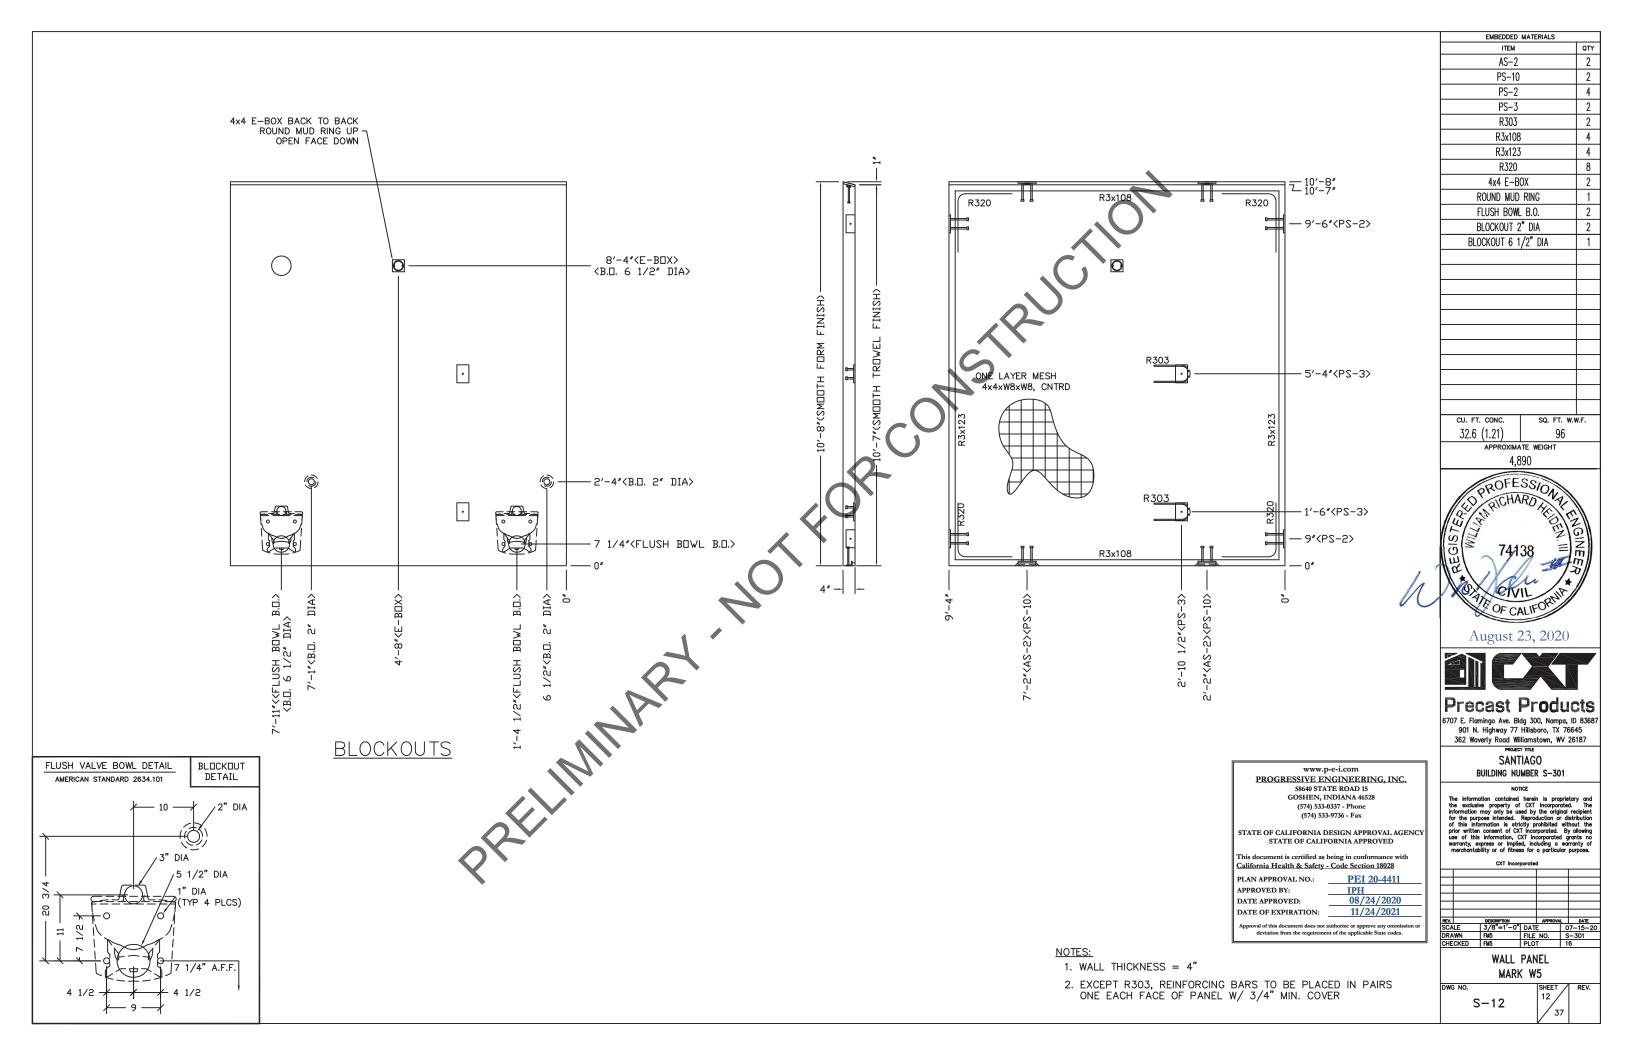

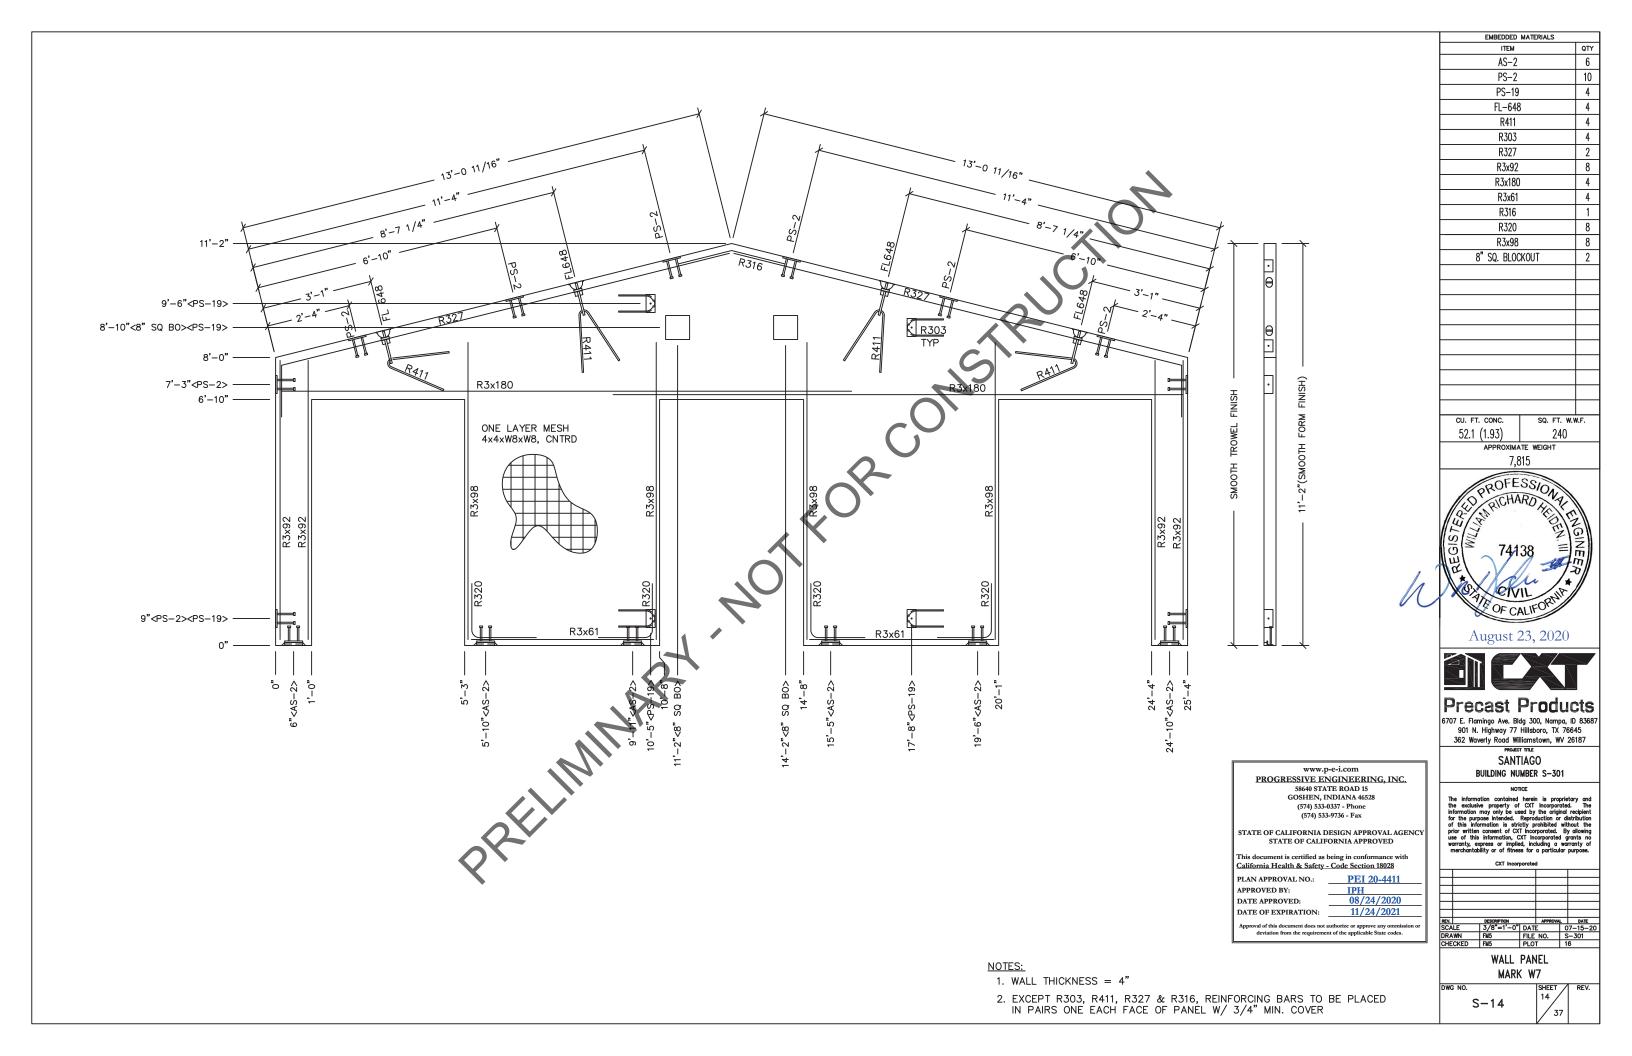

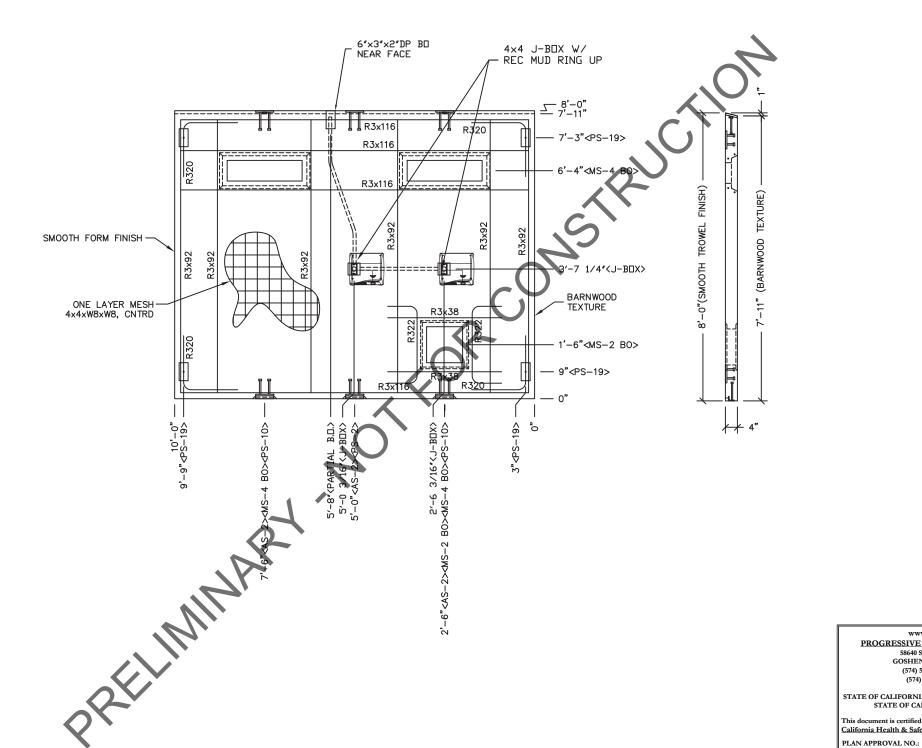

EMBEDDED MATERIALS ITEM QTY 3 AS-2 PS-10 2 PS-19 4 R3x38 2 R3x116 8 R3x92 12 R320 8 PS-2 1 2 MS-4 BO MS-2 B0 R322 2 4x4 J-BOX 2 RECT MUD RING 2 6"x3"x2"DP PARTIAL B.O. CU. FT. CONC. SQ. FT. W.W.F. 25.4 (0.94) 80 APPROXIMATE WEIGHT 3,810 OF CALIFO

August 23, 2020



6707 E. Flamingo Ave. Bldg 300, Nampa, ID 83687 901 N. Highway 77 Hillsboro, TX 76645 362 Waverly Road Williamstown, WV 26187

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	CXT Incor	porate	d		
REV.	DESCRIPTION		APPROVA		DATE
SCALE	3/8"=1'-0"	DAT	E		7-15-20
DRAWN	FM5	FILE	NO.		5-301
CHECKED	FM5	PLO	T	1	6

WALL PANEL MARK W8

> NO. S-15

1. WALL THICKNESS = 4"

NOTES:

2. EXCEPT R322 & R3x38 REINFORCING BARS TO BE PLACED IN PAIRS ONE EACH FACE OF PANEL W/ 3/4" MIN. COVER

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DATE APPROVED:

DATE OF EXPIRATION:

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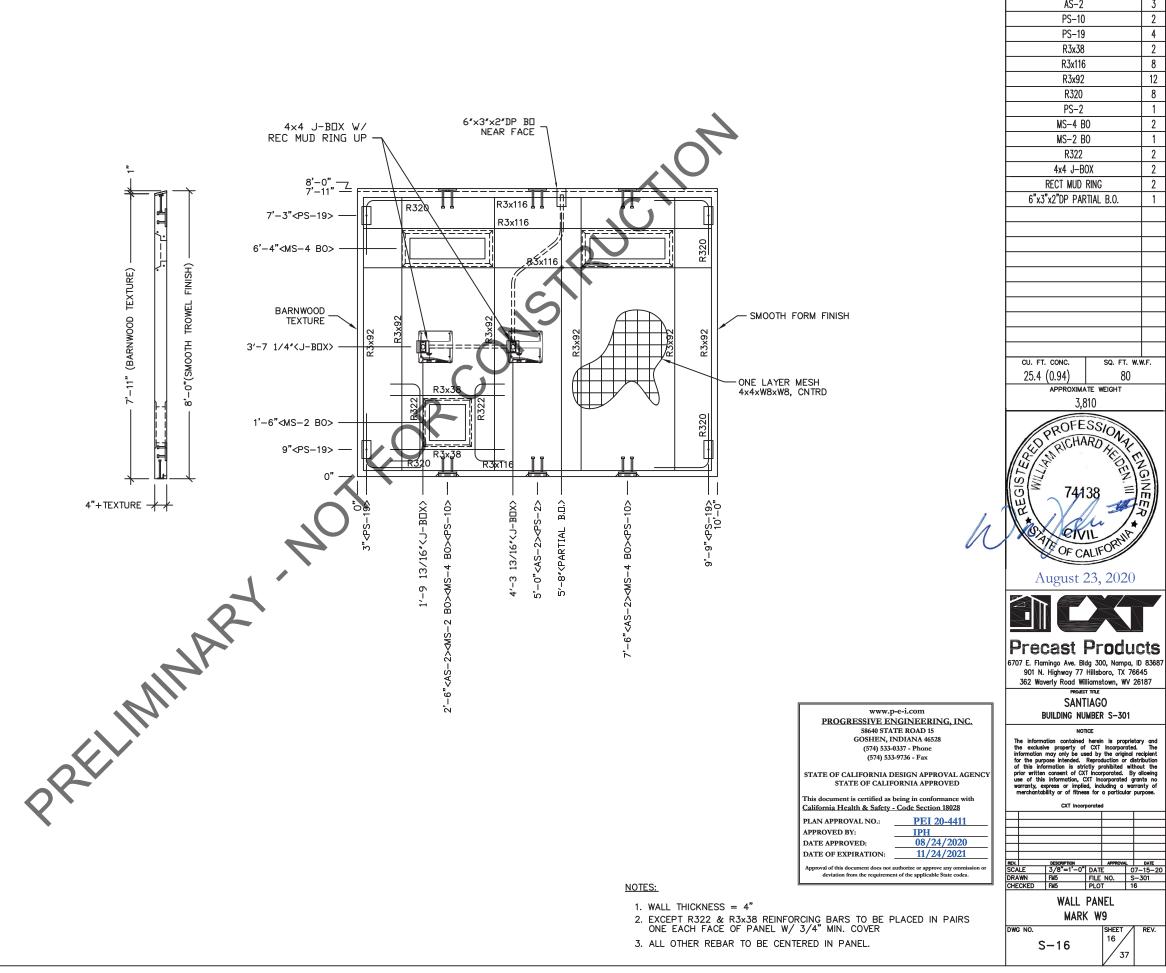
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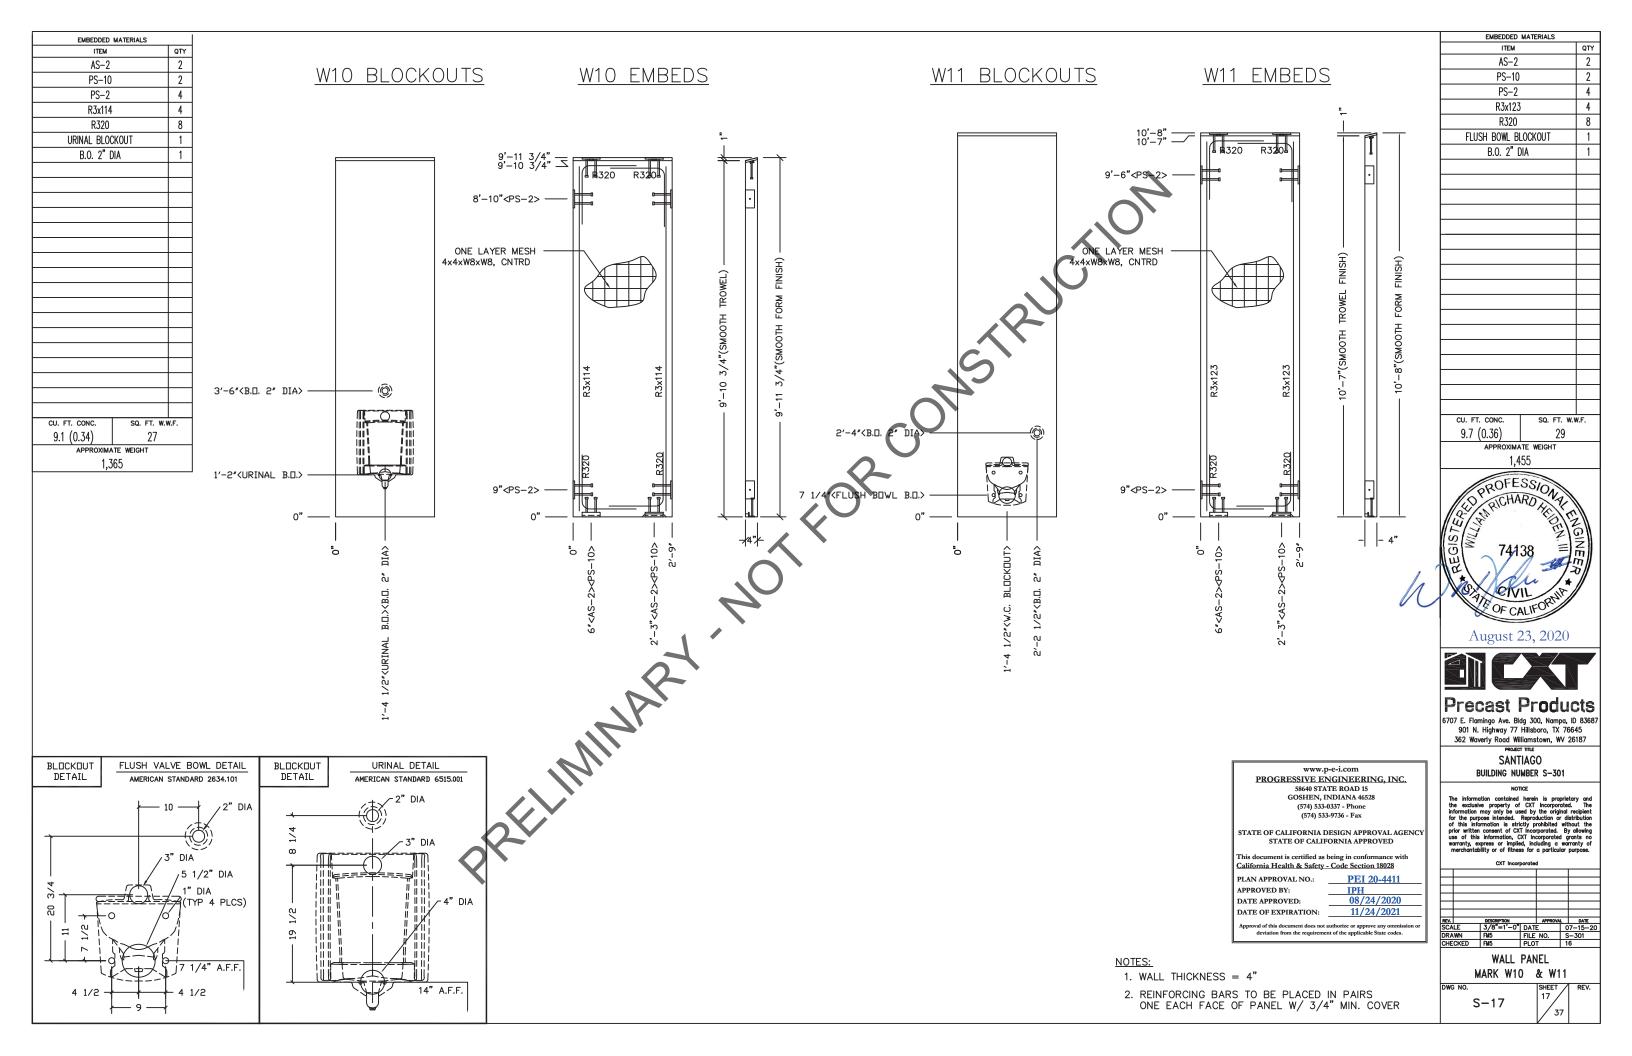
California Health & Safety - Code Section 18028


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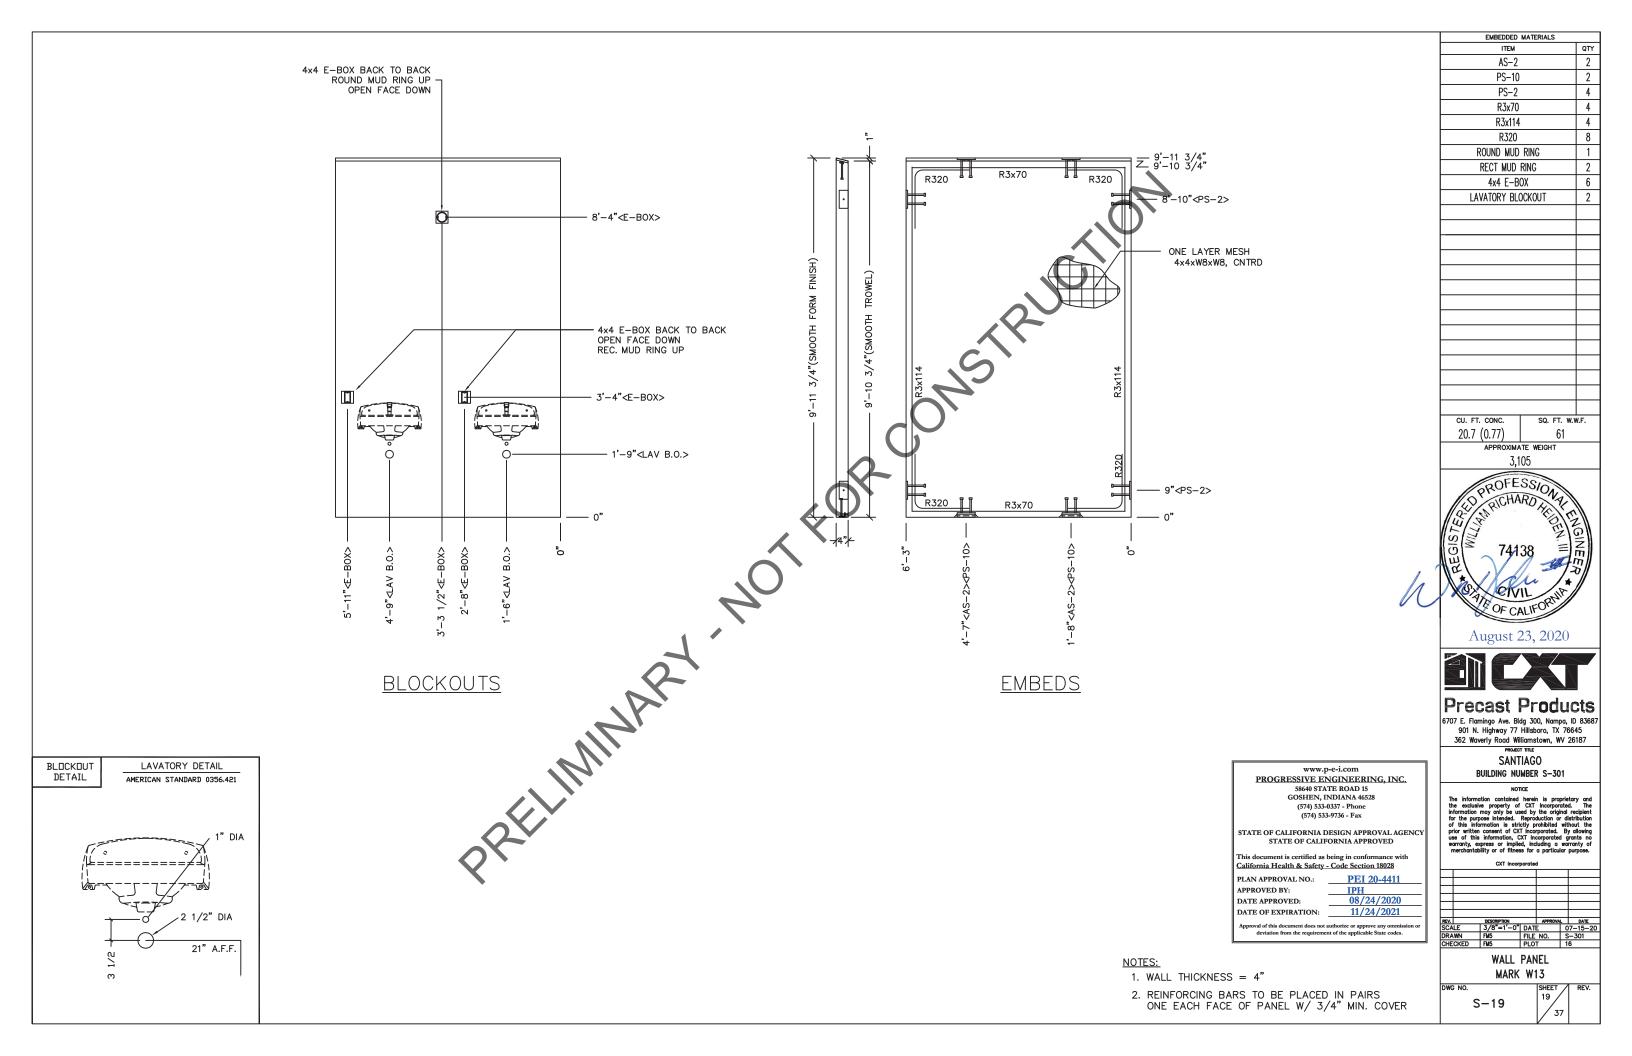
3. ALL OTHER REBAR TO BE CENTERED IN PANEL.





EMBEDDED MATERIALS







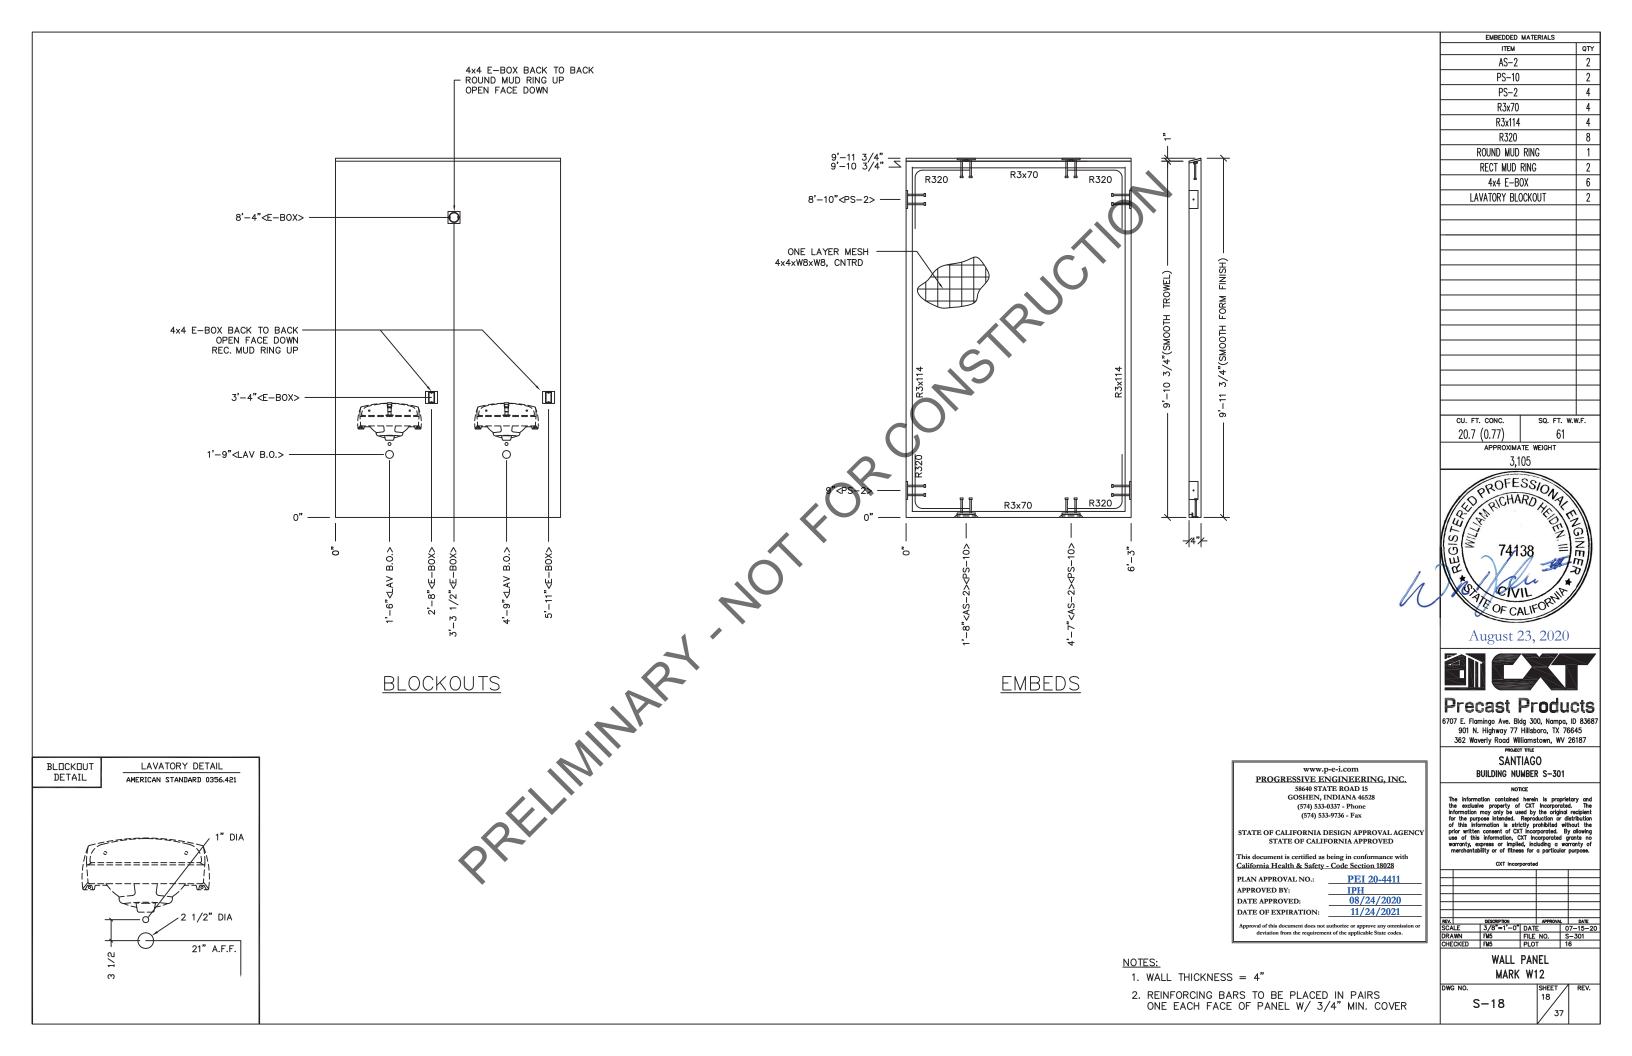


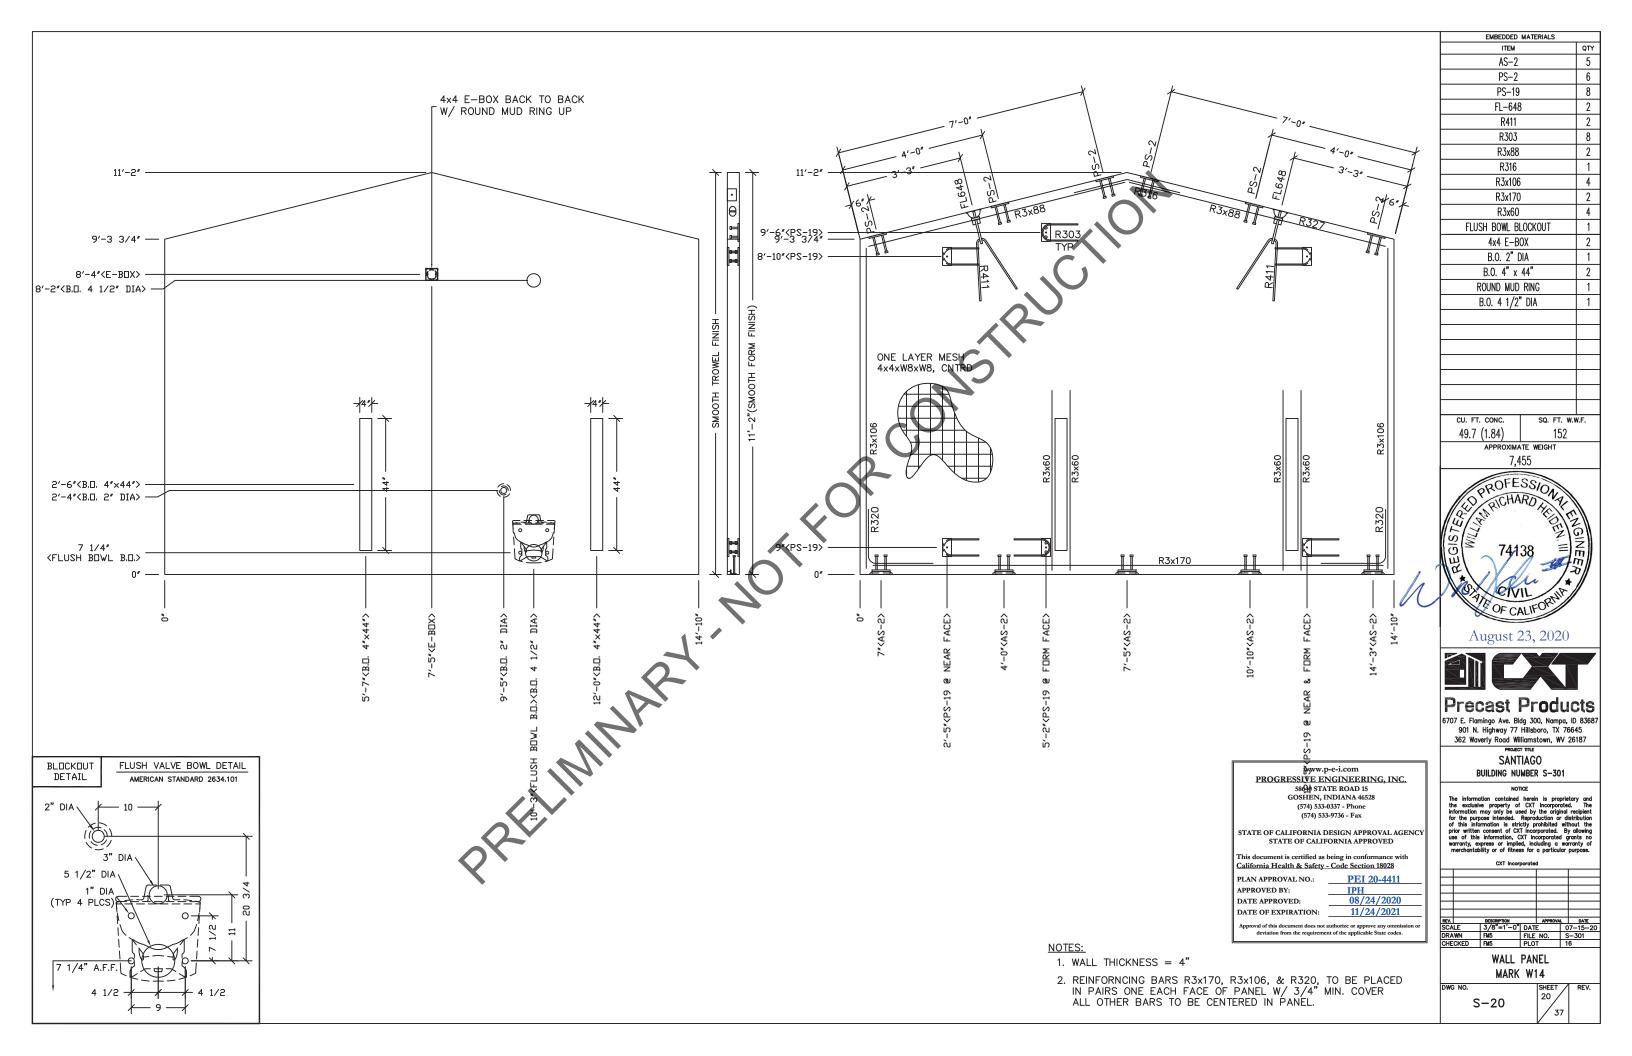


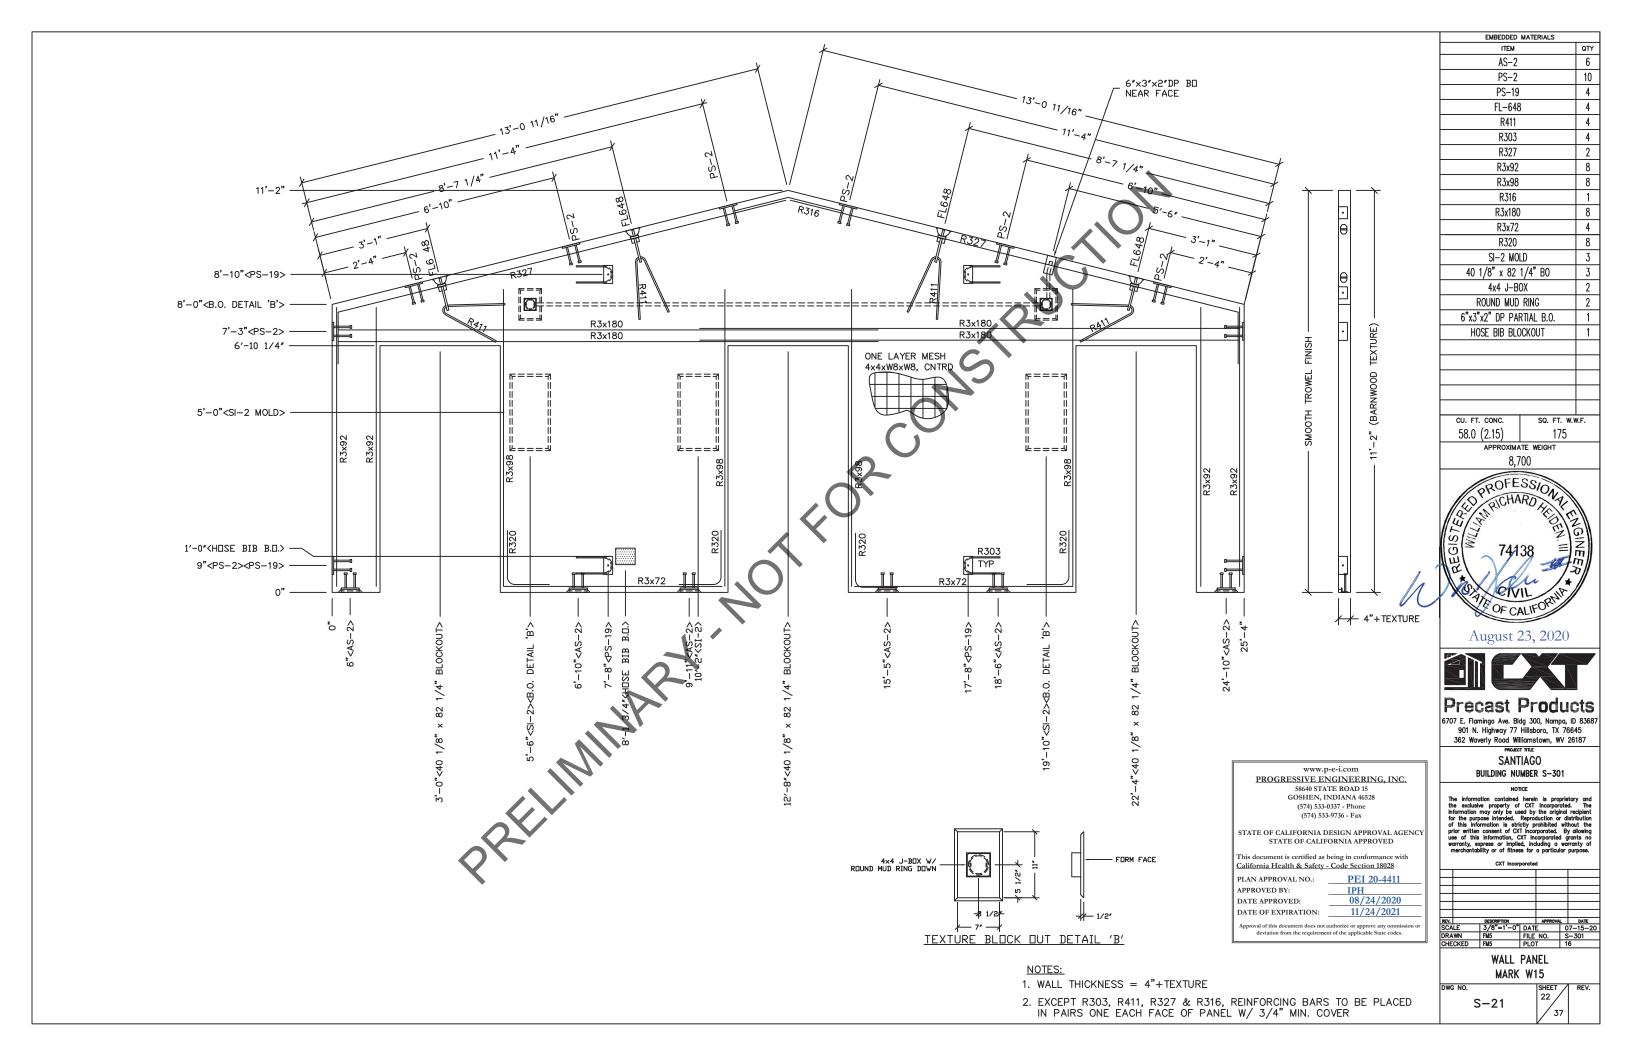

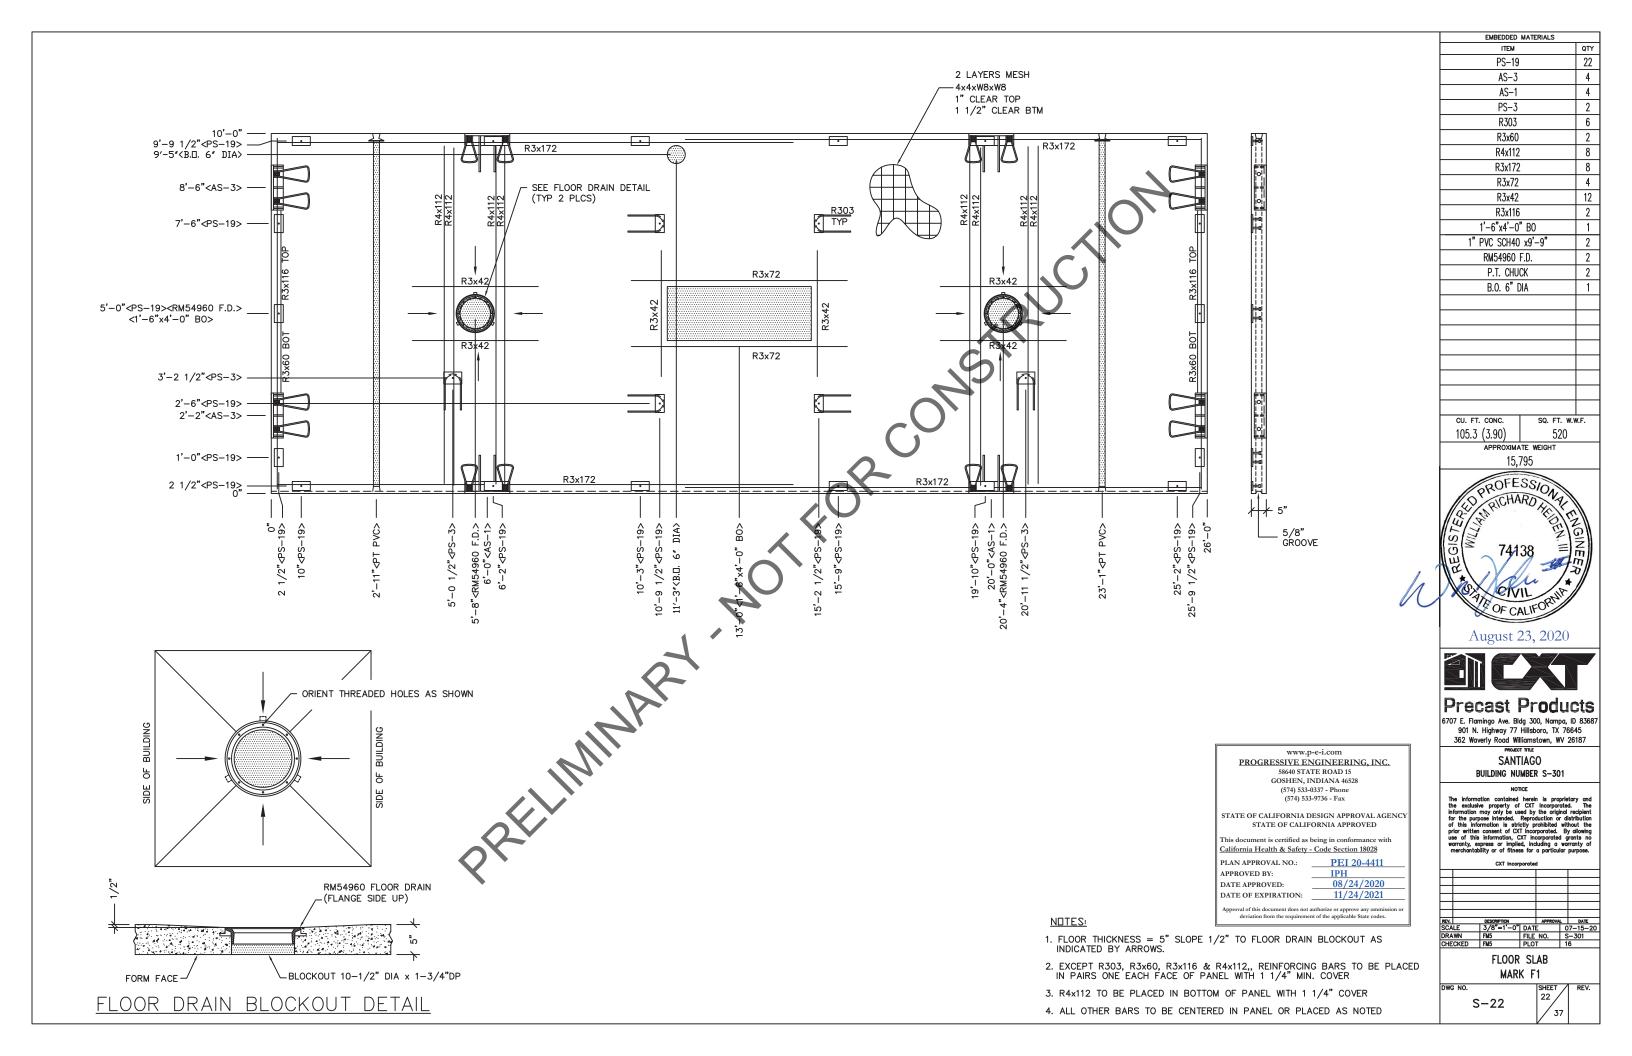

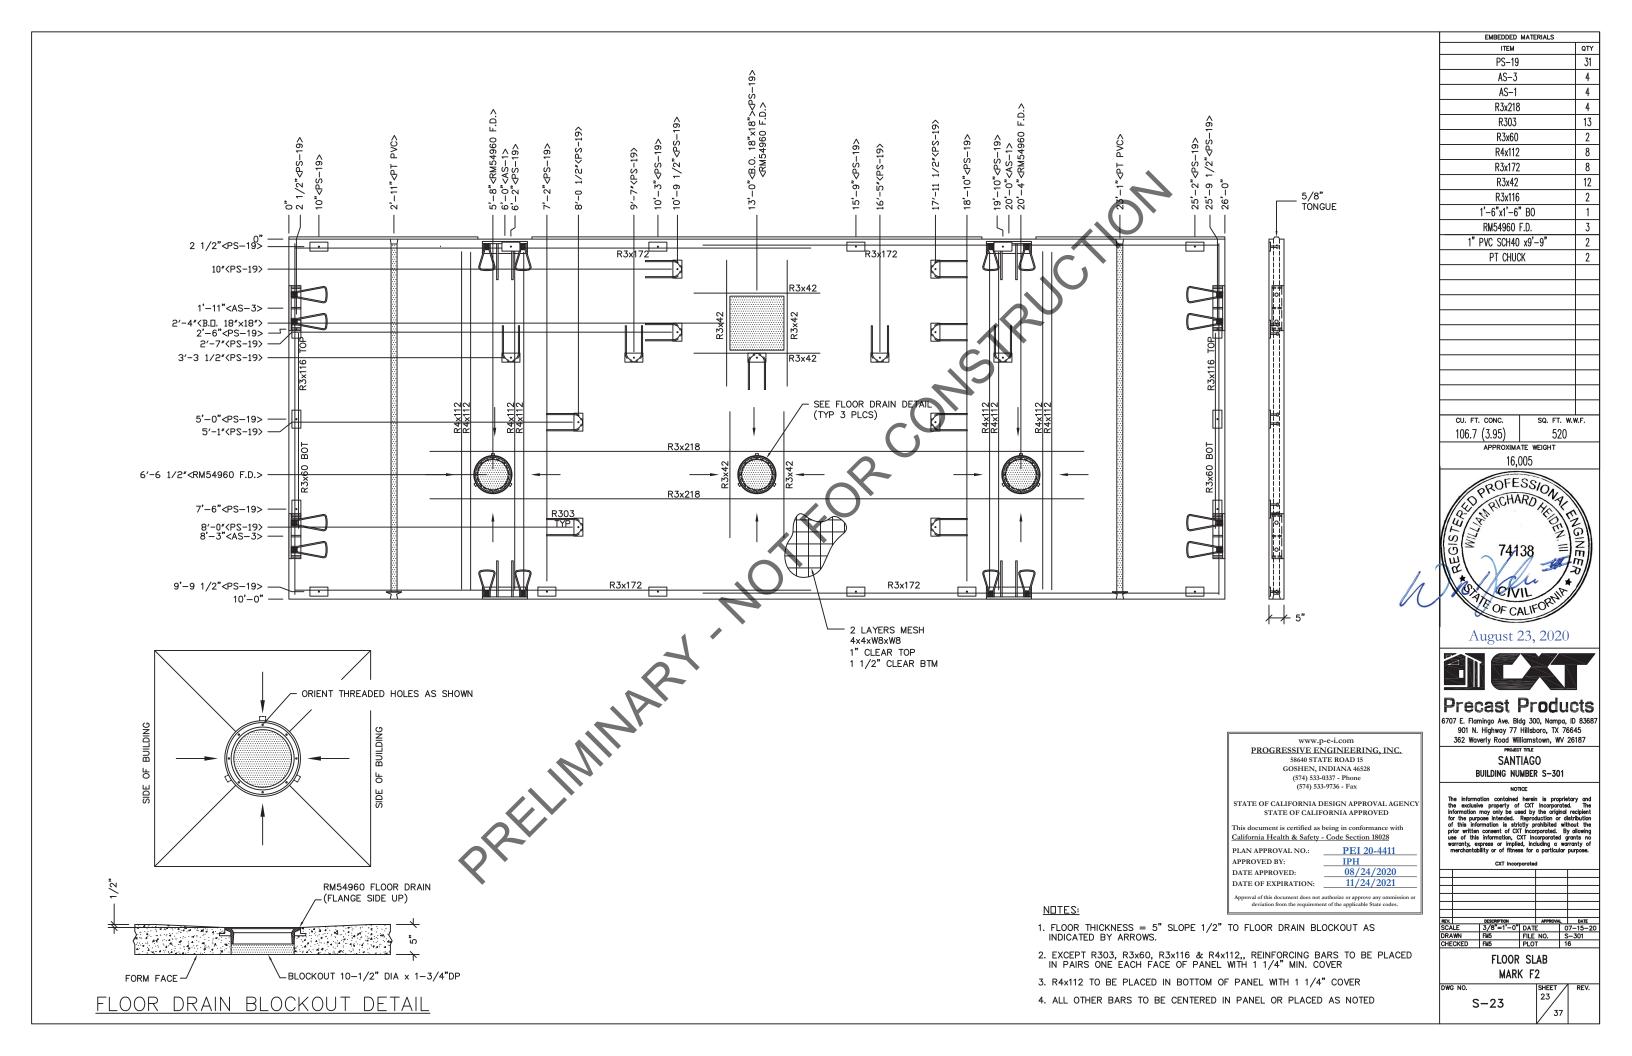

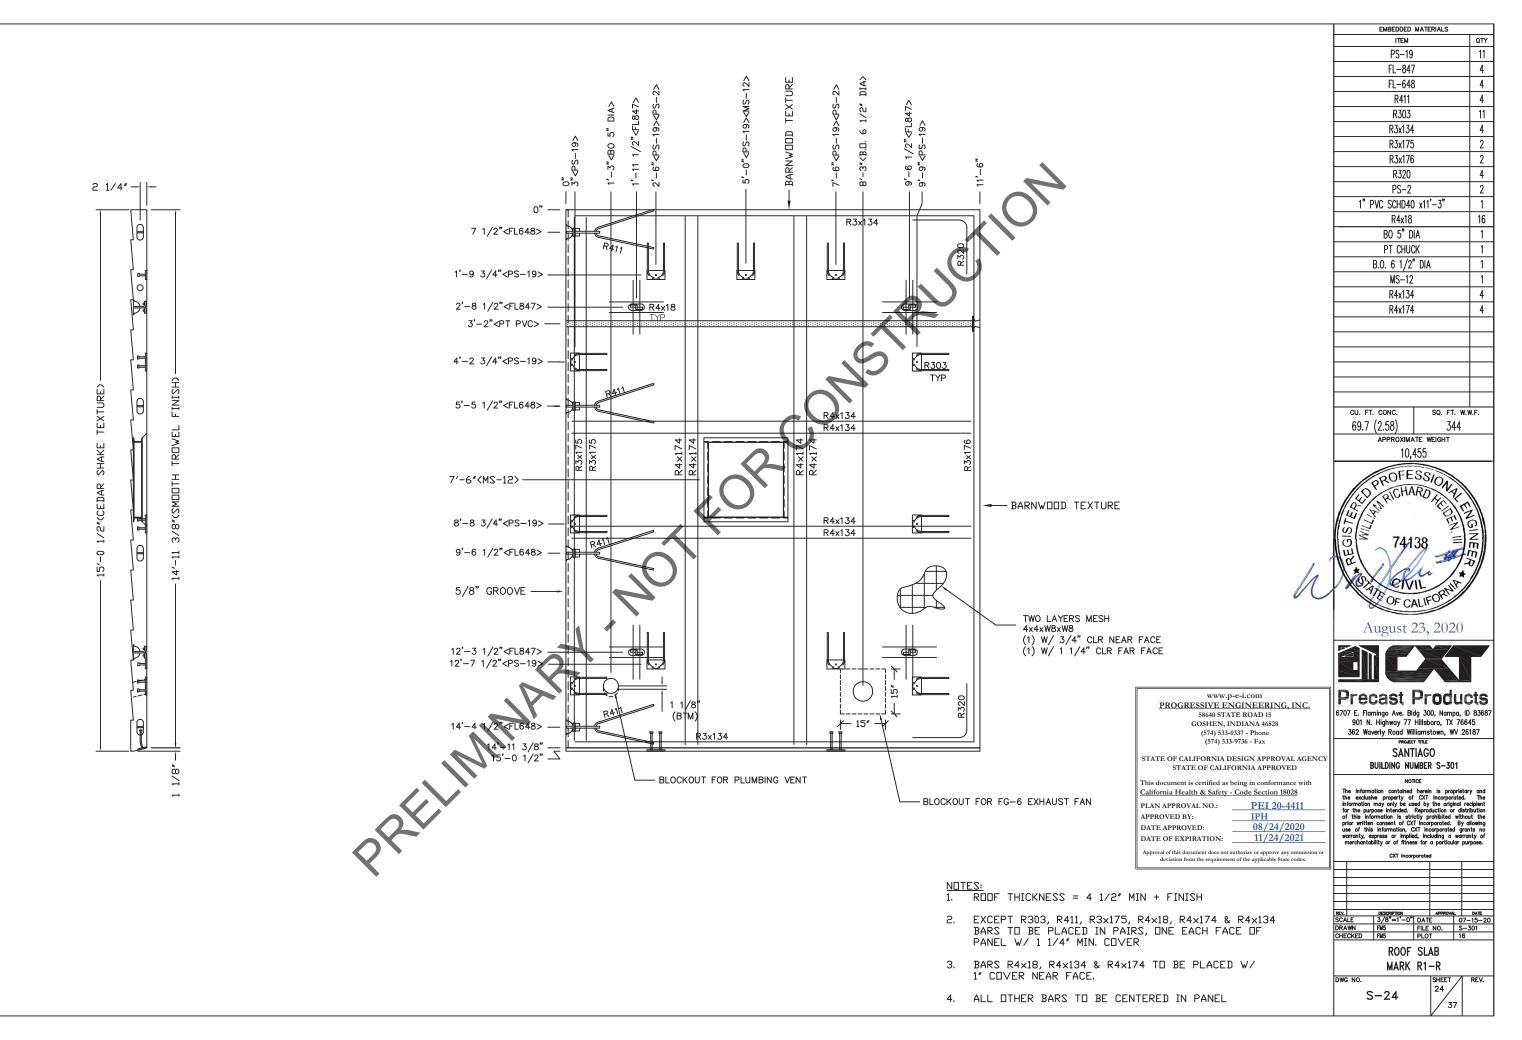

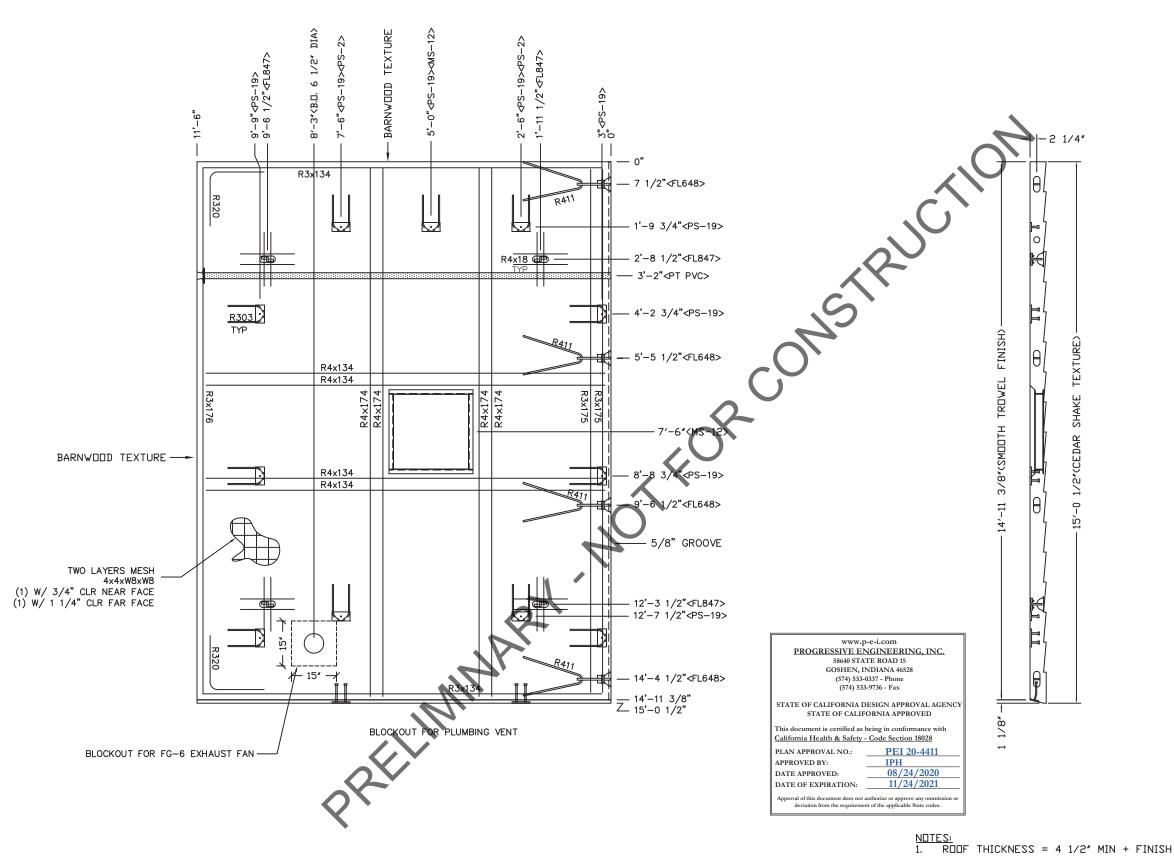

ITEM QTY PS-19 11 4 FL-847 FL-648 4 R411 4 R303 -11 R3x134 4 R3x175 2 2 R3x176 4 R320 PS-2 2 1" PVC SCHD40 x11'-3" 1 R4x18 16 R4x174 4 PT CHUCK B.O. 6 1/2" DIA 1 MS-12 R4x134 4 CU. FT. CONC. SQ. FT. W.W.F.

EMBEDDED MATERIALS

CU. FT. CONC. SQ. FT. W.W.F. 69.7 (2.58) 344

APPROXIMATE WEIGHT

10,455



August 23, 2020



6707 E. Flamingo Ave. Bldg 300, Nampa, ID 83687 901 N. Highway 77 Hillsboro, TX 76645 362 Waverly Road Williamstown, WV 26187

> SANTIAGO BUILDING NUMBER S-301

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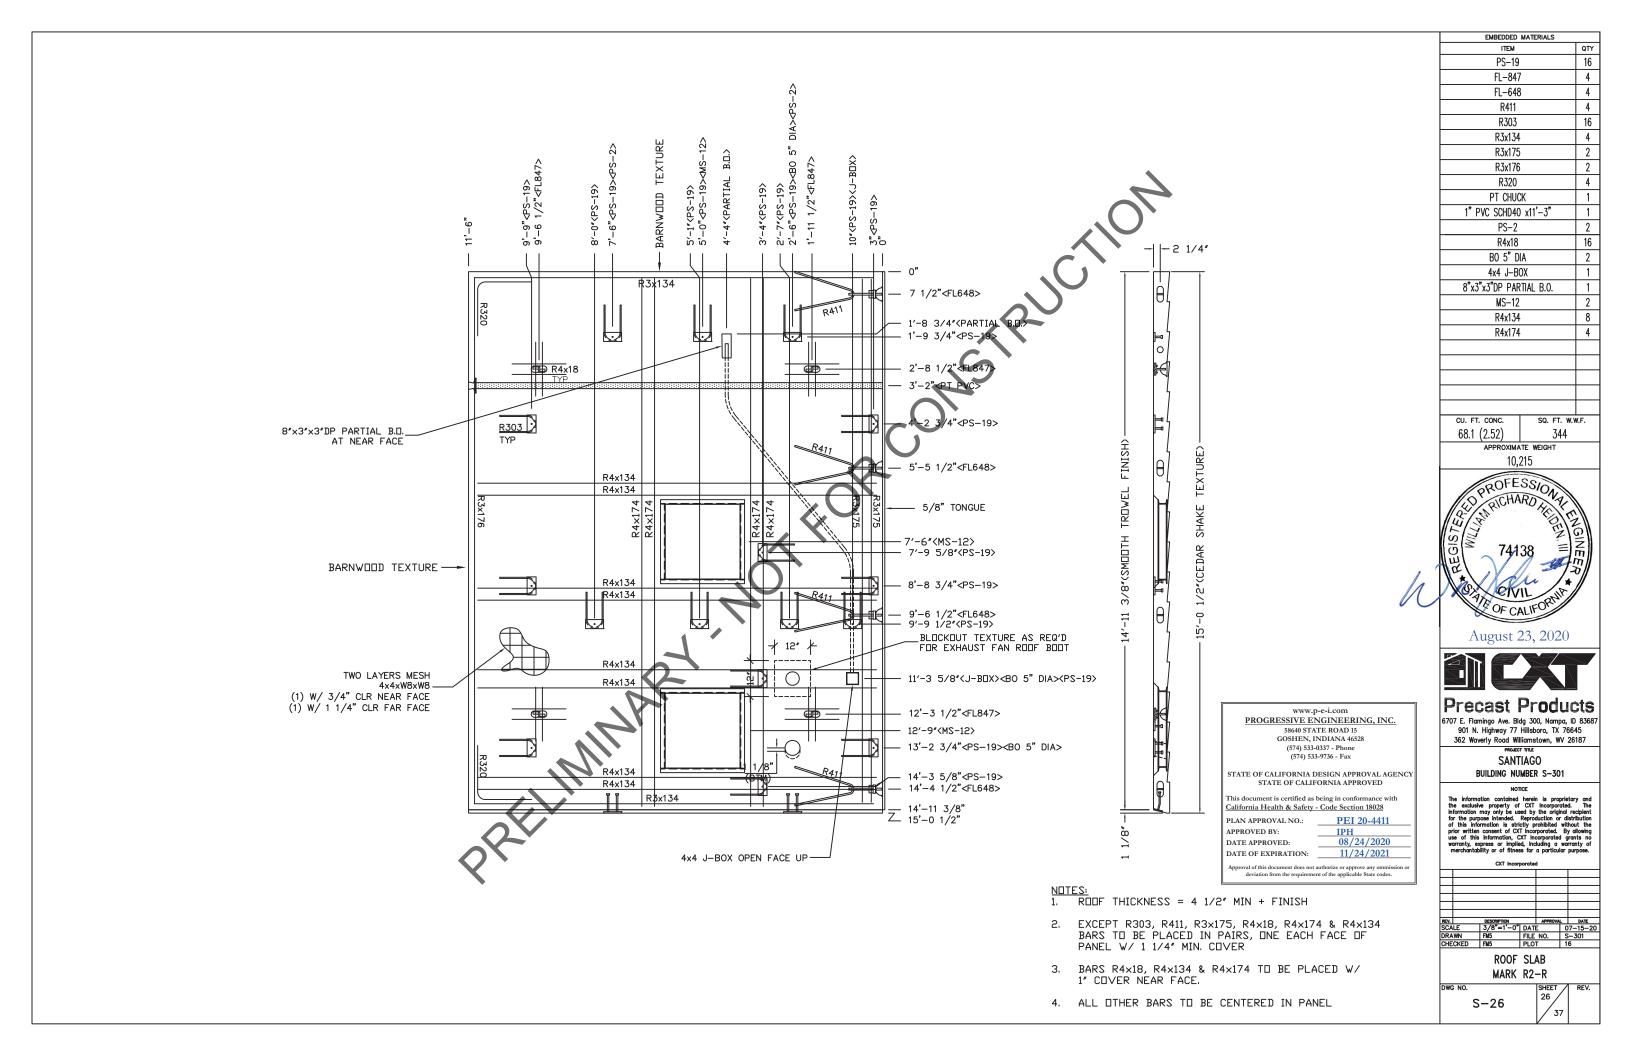
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١,	REV.	DESCRIPTION		APPROVA	L	DATE
5	SCALE	3/8"=1'-0"	DAT	E	0	7-15-
	DRAWN	FM5	FILE	NO.	S	-301
	CHECKED	FM5	PLO	T	1	6
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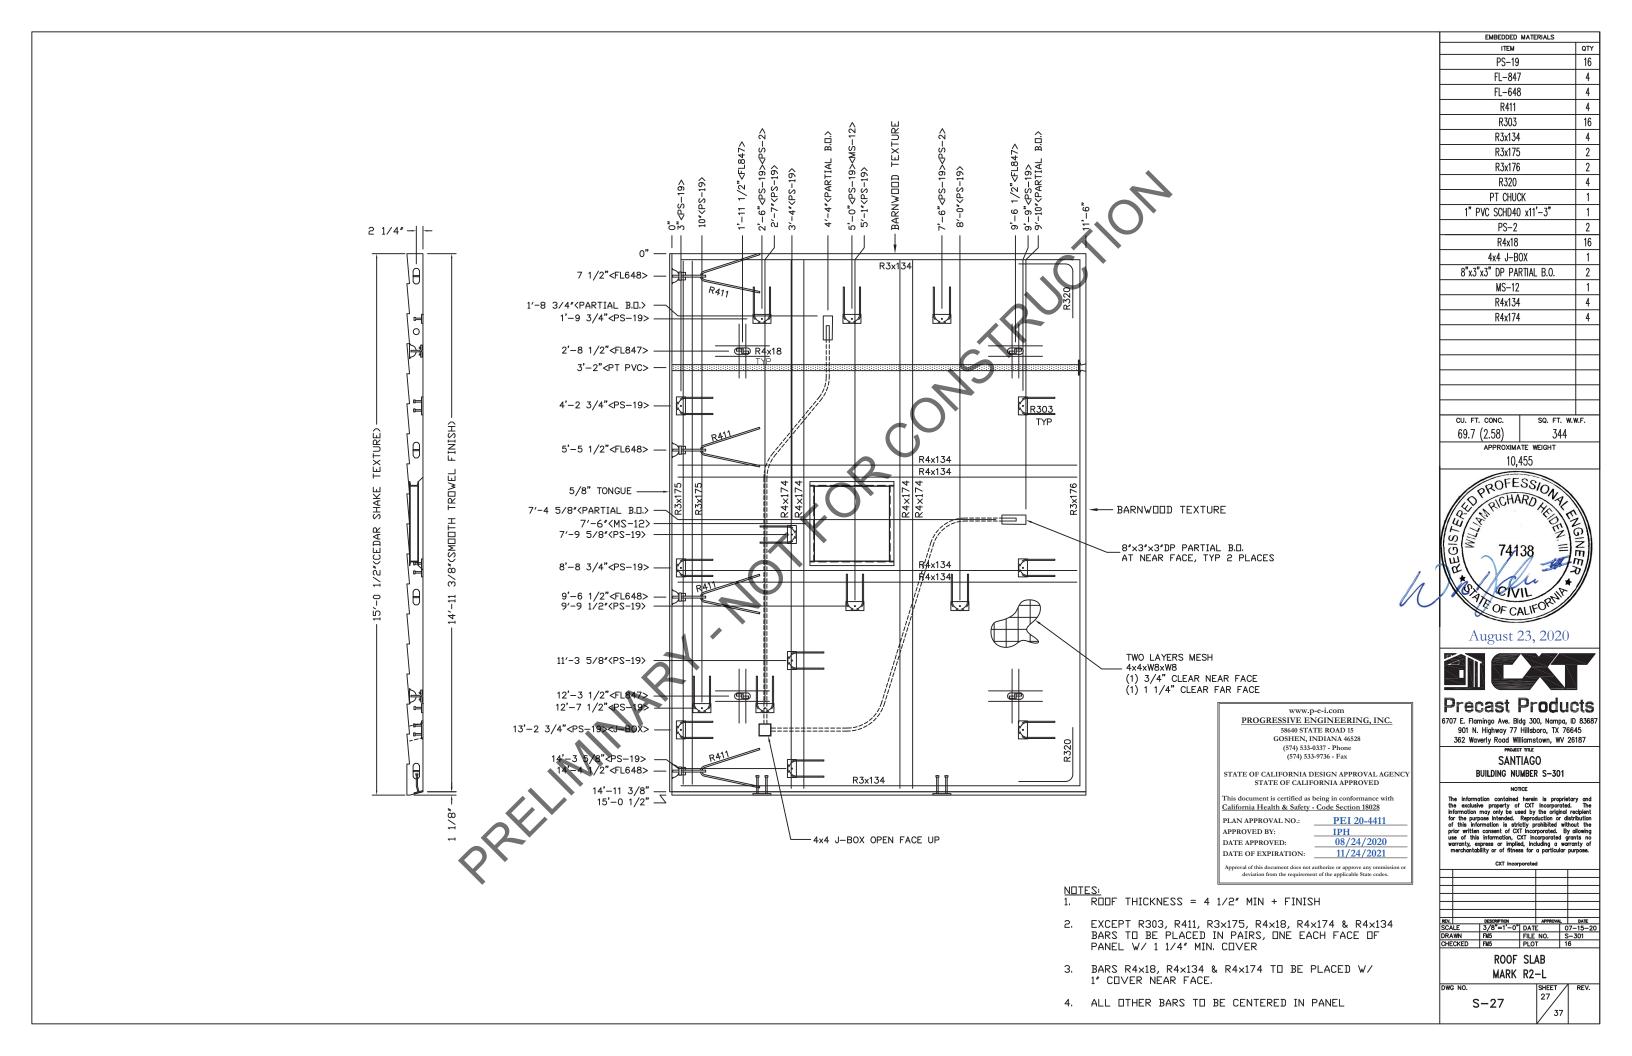
ROOF SLAB MARK R1-L


DWG NO. S-25

25 SHEET 25 3

- . EXCEPT R303, R411, R3×175, R4×18, R4×174 & R4×134 BARS TO BE PLACED IN PAIRS, DNE EACH FACE OF PANEL W/ 1 1/4" MIN. COVER
- 3. BARS R4×18, R4×134 & R4×174 TO BE PLACED W/
 1" COVER NEAR FACE.
- 4. ALL OTHER BARS TO BE CENTERED IN PANEL





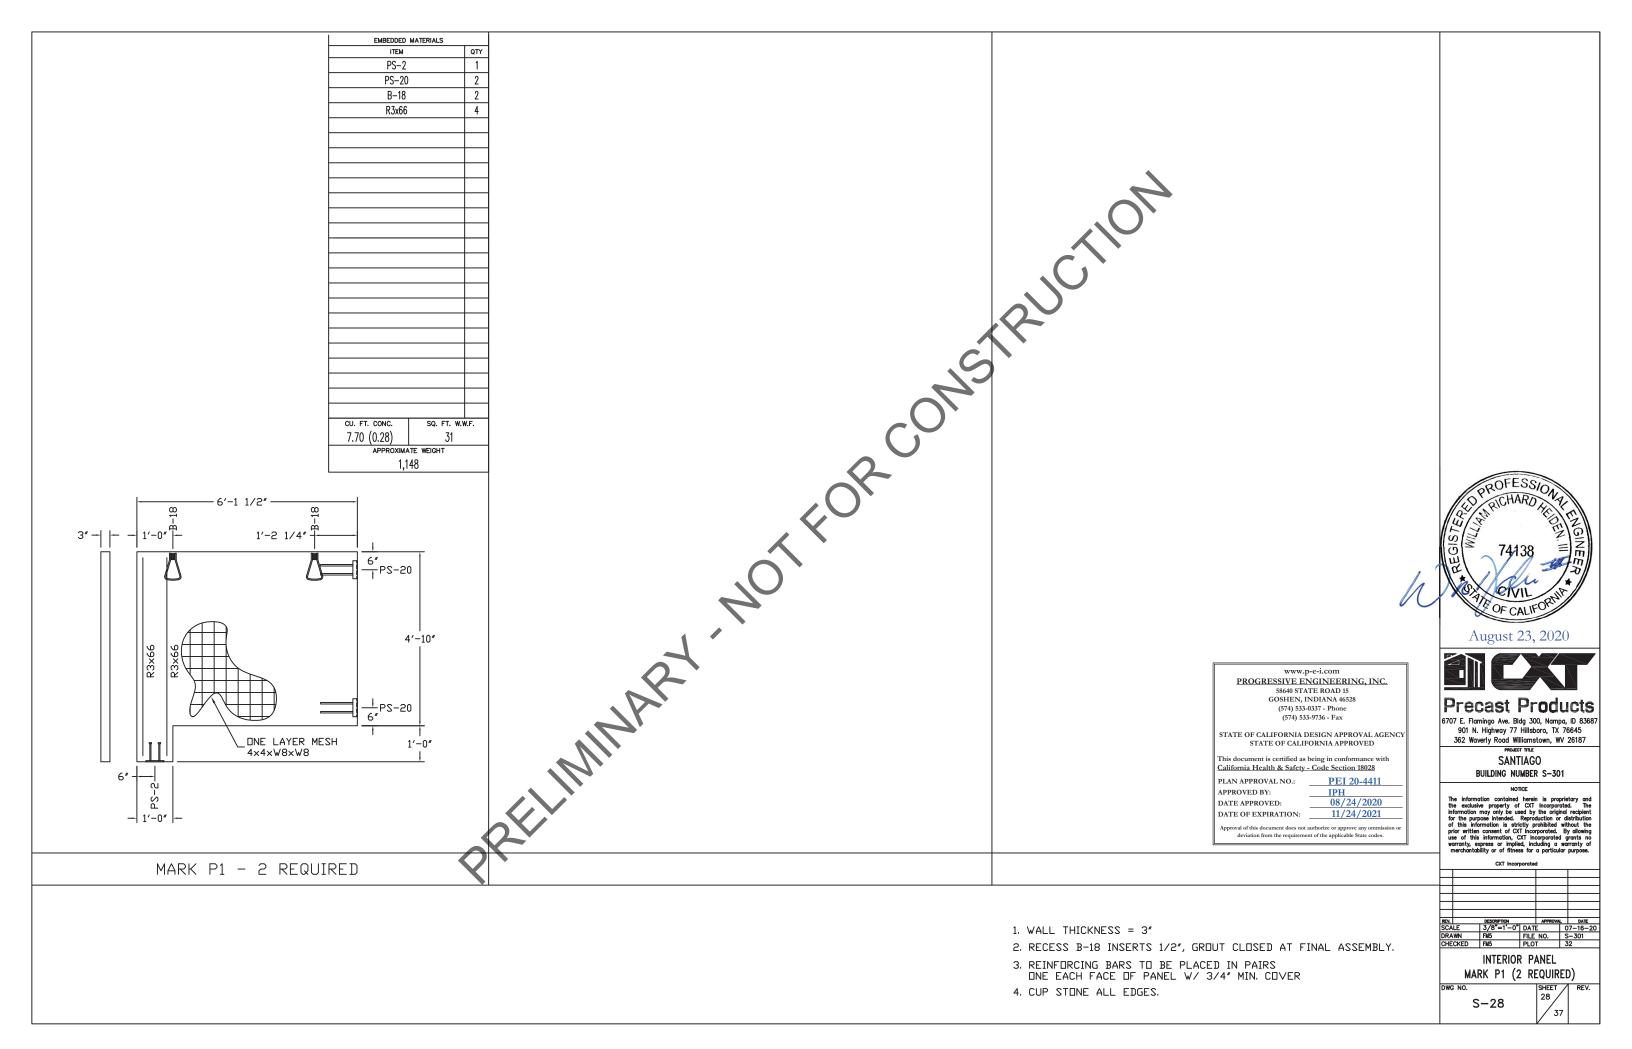

The following drawings are preliminary for bidding purposes only. Contractor shall not use these drawings for permit or construction purposes. A final set of stamped plans specifically for the restroom being fabricated for this project will be provided to the contractor at a later date.


NOTE:

THIS FACTORY ASSEMBLED BUILDING, AS CONSTRUCTED, PROVIDES A RIGID BOX TYPE STRUCTURAL SYSTEM. VERTICAL LOADS ARE TRANSFERRED PRIMARILY THROUGH BEARING WALLS TO THE STRUCTURAL SLAB FLOOR OF THE BUILDING. THE VERTICAL LOADS ARE THEN DISTRIBUTED THROUGH THE REINFORCED CONCRETE FLOOR TO THE PREPARED GRANULAR, NON-FROST SUSCEPTIBLE (NFS) SUB-BASE WHICH DISTRIBUTES THE VERTICAL LOADS IN RELATIVELY UNIFORM FASHION TO THE NATIVE SUB-GRADE. AS WITH MOST CONSTRUCTION, THIS DOES REQUIRE THE NATIVE SUB-GRADE TO BE STRIPPED OF VEGETATION AND TOP SOIL PRIOR TO PLACEMENT OF THE PREPARED GRANULAR SUB-BASE. DUE TO THE INHERENT STIFFNESS OF THE BUILDING, IT WILL REMAIN SAFE AND STRUCTURALLY SOUND IN THE UNLIKELY EVENT OF FREEZING ACTION BELOW THE BUILDING REGARDLESS OF NATURAL FREEZE/ THAW CYCLES ANTICIPATED TO BE ENCOUNTERED IN THE STATE OF CALIFORNIA.

LATERAL LOADS ARE TRANSFERRED TO THE GROUND THROUGH FRICTIONAL RESISTANCE WITHOUT SLIDING OR SHIFTING BETWEEN THE BUILDING FLOOR SLAB AND THE PREPARED SOIL AND GRAVEL SUB-BASE ON WHICH THE BUILDING RESTS. SEISMIC ANALYSES ARE BASED ON LOADS DETERMINED IN ACCORDANCE WITH THE INTERNATIONAL BUILDING CODE USING PARAMETERS. WHICH MEET OR EXCEED THE CODE PRESCRIBED REQUIREMENTS FOR THIS INSTALLATION.

THIS BUILDING AS DESIGNED, RESTING ON A PROPERLY PREPARED GRANULAR SUB-BASE WILL BE SAFE AND STRUCTURALLY SOUND FOR VERTICAL AND LATERAL LOADS AS DISCUSSED ABOVE. A FULL DEPTH FOUNDATION WALL AT THE BUILDING PERIMETER AND AN ANCHORAGE SYSTEM, TYPICAL FOR OTHER TYPES OF BUILDING CONSTRUCTION, ARE NOT REQUIRED FOR THIS BUILDING.

THE "FOUNDATION" FOR THIS STRUCTURE IS ESSENTIALLY THE COMBINATION OF THE COMPACTED SUB-BASE MATERIAL AND THE BUILDING'S REINFORCED SLAB. THE COMBINATION OF THE COMPACTED SUB-BASE MATERIAL AND THE BUILDING'S REINFORCED SLAB NEED TO BE AT LEAST 12" THICK AND THE COMPACTED SUB-BASE MATERIAL SHALL EXTEND BELOW THE LOCAL FROST DEPTH

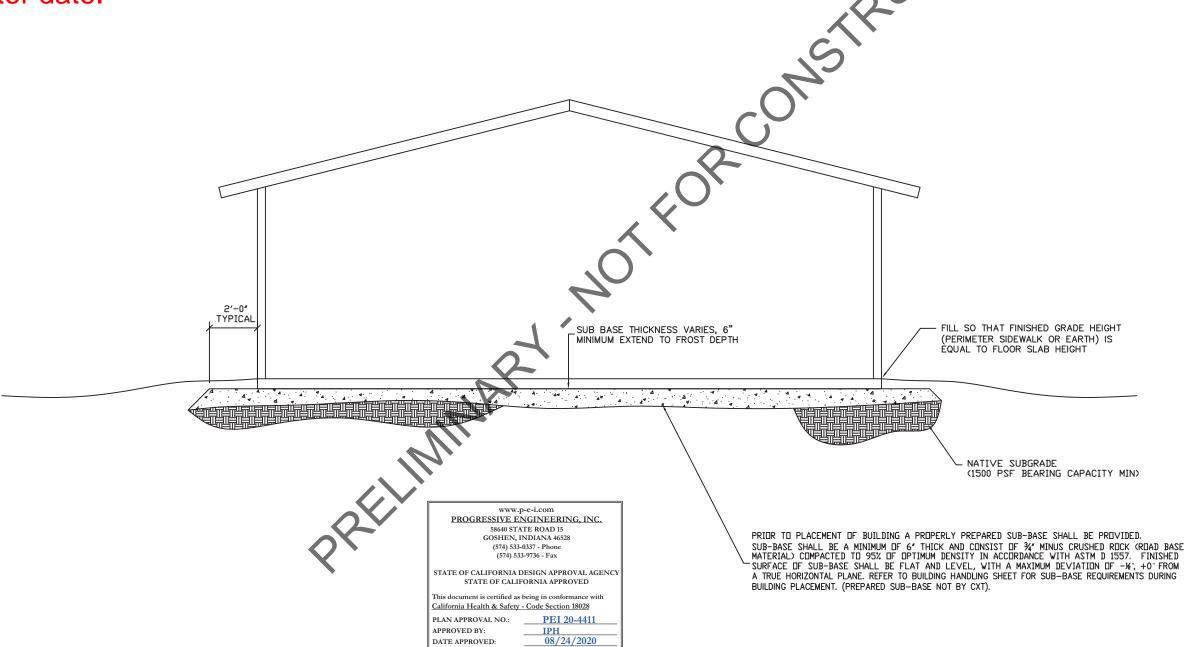

11/24/2021

DATE OF EXPIRATION:

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August 23, 2020



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> SANTIAGO BUILDING NUMBER S-301

BUILDING NUMBER 3

NOTIC

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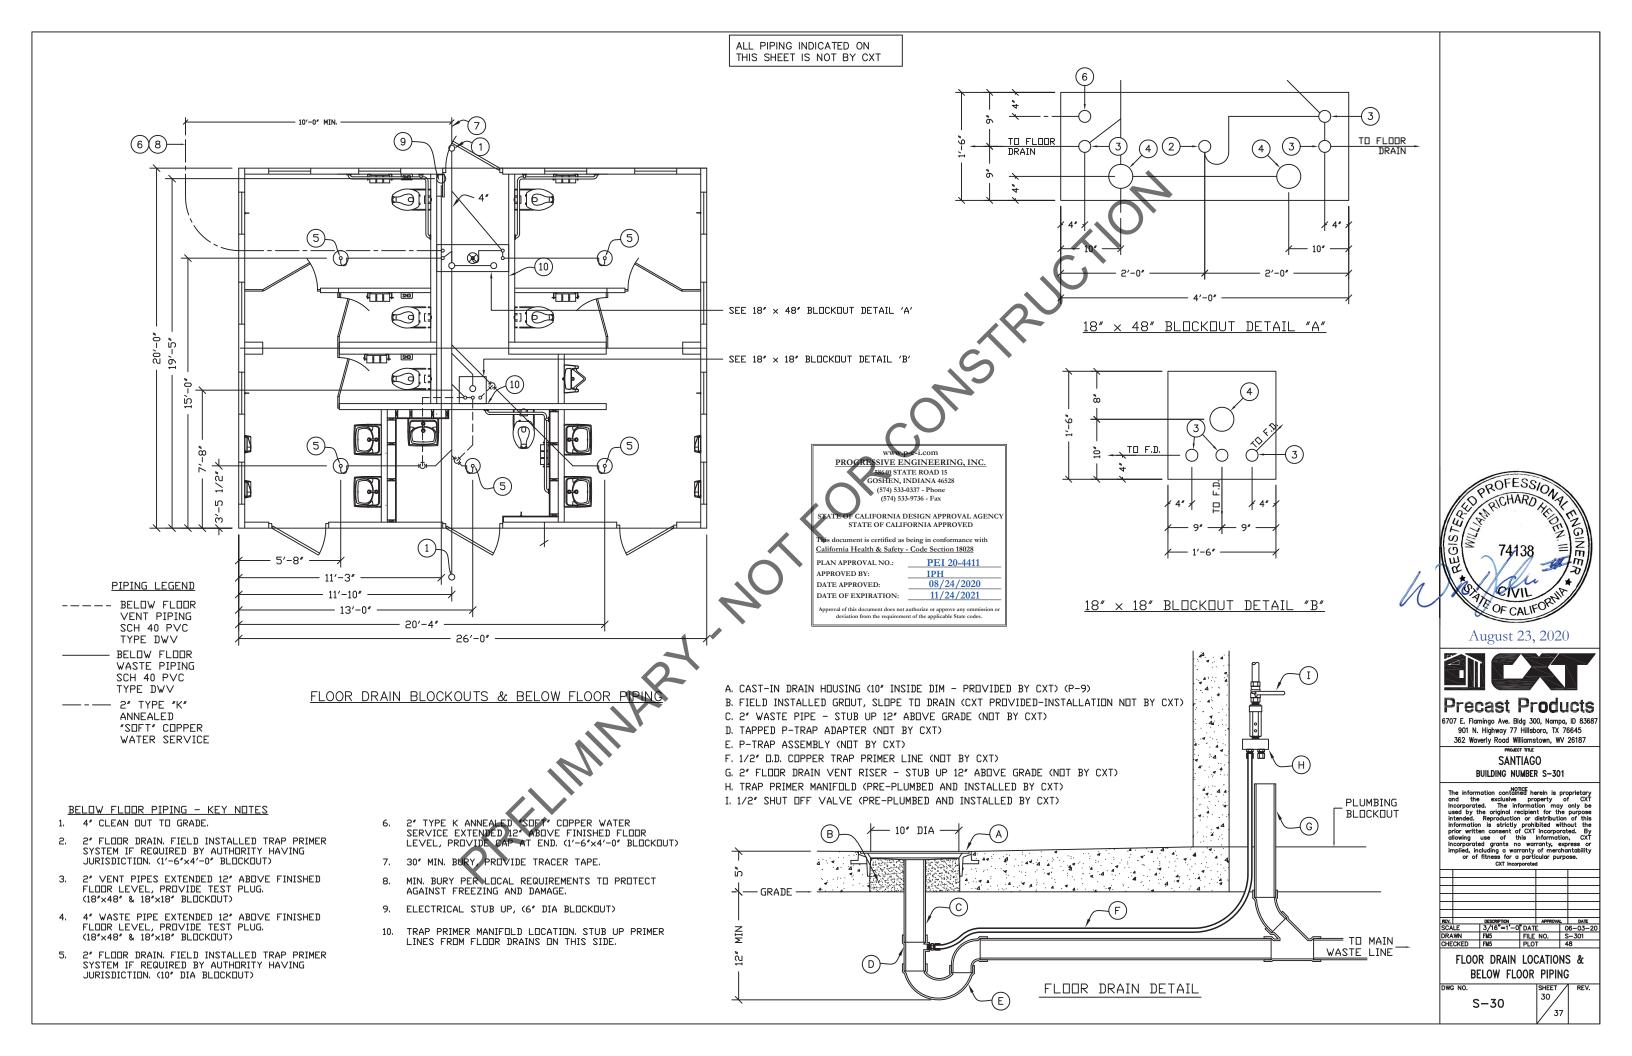
	CXT Incor	porate	d		
REV.	DESCRIPTION		APPROVA	L	DATE
SCALE	1/4"=1'-0"	DAT	E		6-03-
DRAWN	FM5	FILE	NO.	3	-301
CHECKED	FM5	PLO	T	4	8


FOUNDATION DETAIL


NO. S-29

9 29

29 37



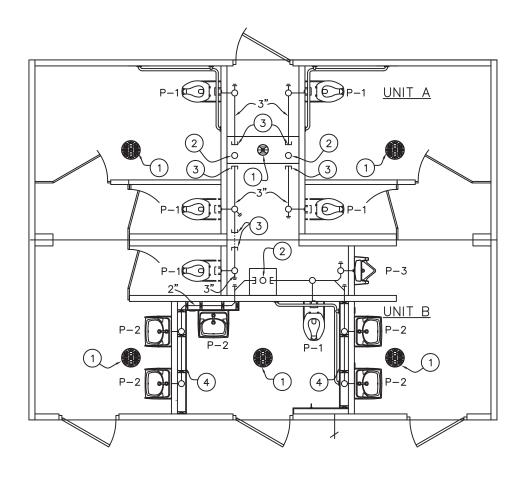

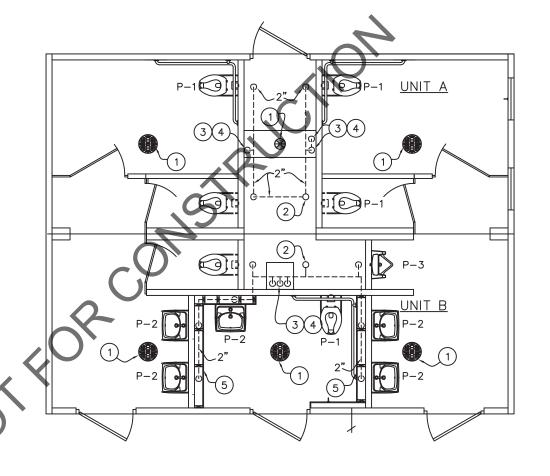

WASTE PIPING

WASTE PIPING - KEY NOTES

- 1. 2" FLOOR DRAIN P-8, FIELD INSTALLED (NOT BY CXT)
- 2. 4" WASTE THROUGH FLOOR, FIELD INST (NOT BY CXT)
- PROVIDE TEST PLUG IN END OF WAS PIPE. CONTINUATION OF PIPING IS FI INSTALLED & NOT BY CXT.
- 4. ROUTE PLUMBING INSIDE

VENT PIPING

VENT PIPING - KEY NOTES

- 1. 2" FLOOR DRAIN P-8, FIELD INSTALLED (NOT BY CXT)
- 2. 4" VENT THROUGH ROOF.
- 3. 2" VENT WITH TEST PLUG.
- FIELD INSTALLED 2" VENT PIPING FROM FLOOR DRAINS. (NOT BY CXT)
- 5. ROUTE PLUMBING INSIDE FURRED WALL.

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STATE OF CALIFORNIA DESIGN APPROVAL AGENCY STATE OF CALIFORNIA APPROVED

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PEI 20-4411 PLAN APPROVAL NO.: APPROVED BY: IPH DATE APPROVED: 08/24/2020 DATE OF EXPIRATION:

August 23, 2020

	X	
-	 	_

Precast Products 6707 E. Flamingo Ave. Bldg 300, Nampa, ID 83687 901 N. Highway 77 Hillsboro, TX 76645 362 Waverly Road Williamstown, WV 26187

SANTIAGO BUILDING NUMBER S-301

		CX1 Incon	porate	3		
EV.		DESCRIPTION		APPROVA	L	DATE
CA	LE	3/16"=1'-0	DAT	Ε	С	7-16-2
RA	WN	FM5	FILE	NO.	S	-301
ΉE	CKED	FM5	PLO'	T	4	8

PLUMBING PLANS

S-31


11/24/2021

|--|

---- COLD WATER SCH 40 ABS, ASTM D2661, OR PVC, ASTM D2665, TYPE DWV ---- HOT WATER

---- VENT PIPING SCH 40 ABS OR PVC TYPE DWV ----- FIELD PIPING (NOT BY CXT)


- WASTE PIPE:

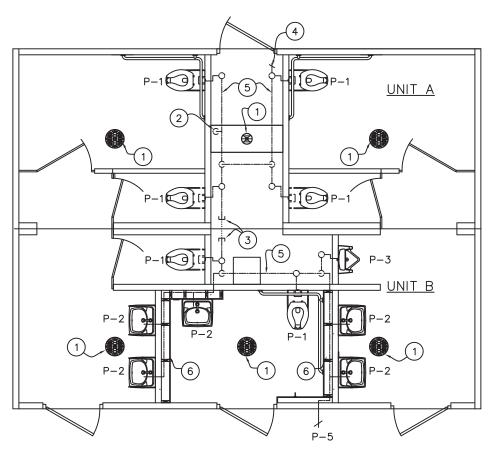

WATER PIPING

WATER PIPING - KEY NOTES

- 2" FLOOR DRAIN, FIELD INSTALLED (P-8) (NOT BY CXT)
- FIELD INSTALLED 2" WATER SUPPLY WITH SHUT-OFF VALVE NEAR FLOOR. (NOT BY CXT) 2.
- CAPPED WATER LINES, CONNECTION BETWEEN SIDES IS TO BE FIELD INSTALLED. (NOT BY CXT) 3.
- 3/4" HOSE BIBB WITH VACUUM BREAKER AND WHEEL HANDLE.
- WATER PIPING ALONG WALL, SEE DIAGRAM #1 ON THIS DRAWING.
- 6. ROUTE PLUMBING INSIDE FURRED WALL.

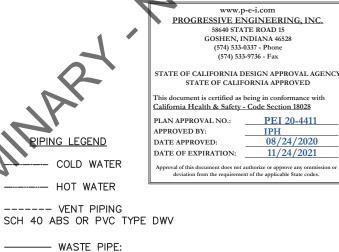

ABS, ASTM D2661, DR PVC, ASTM D2665, SCHED. 40

FIELD PIPING (NOT BY CXT)

PIPING LEGEND

WATER PIPING RISER DIAGRAM #1

-WYE STRAINER(6)

- 2" CW VALVE SEE DIAGRAM (NOT BY CXT)

<u>UNIT A</u>

WATER PIPING RISER - KEY NOTES

UNIT B

- 3/4" HDSE BIBB WITH VACUUM BREAKER & WHEEL HANDLE.
- 2. TO THIS POINT BY CXT.
- PLUGGED WATER LINES TO THIS POINT, BY CXT. PIPING BETWEEN THESE POINTS, NOT BY CXT.
- 1/2" AIR QUICK CONNECTION W/ BALL VALVE FOR BLOWING OUT WATER PIPING.
- 1/2" BALL VALVE & CAPPED CW LINE FOR FIELD INSTALLED TRAP FOR BLOWING OUT WATER PIPING. PRIMER VALVE IF REQUIRED BY JURISDICTION HAVING AUTHORITY
- PROVIDE WYE STRAINER
- ASSE 1010 WATER HAMMER ARRESTOR SIOUX CHIEF HYDRA-RESTOR #654-C OR EQUAL.




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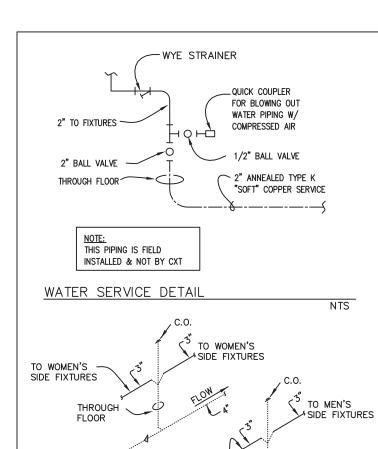
> SANTIAGO BUILDING NUMBER S-301

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PLUMBING PLAN & DIAGRAMS

S-32



TO MEN'S-SIDE FIXTURES

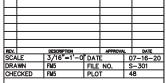DETAIL OF FIELD INSTALLED

WASTE CONNECTION

SPECIAL NOTES:

1. TOTAL FIXTURE COUNT (INCLUDES FLOOR DRAINS): (22)

- 2. FLOWING PRESSURE: 45 PSI MIN, 80 PSI MAX
- 3. TOTAL DEVELOPED LENGTH = 35'-0"*

*APPROXIMATE DISTANCE FROM THE SOURCE TO THE FARTHEST FIXTURE

PIPING LEGEND

WASTE & VENT RISER DIAGRAM

NTS

WASTE & VENT RISER - KEY NOTES

1. TO THIS POINT BY CXT.

				PLUMBING	FIXTURE SCHEDULE							
SYM	DESCRIPTION	MANUFACTURE	ER MODEL #	FLUSH VALVE/FAUCET	TRAP	ACTUATOR	DRAIN	HW	CW	WASTE	VENT	NOTES
P-1	WATER CLOSET	AMERICAN STAND	2634.101 (W.C.) 5905.100 (W.C. SEAT)	SLOAN "ROYAL" #952-1.28 L-3 W=4"	_	SLOAN HY33A	-	_	1-1/4"	3"	2"	1,3
P-2	LAVATORY	AMERICAN STAND	OARD 0356.421 (LAV.)	SLS-7000	OFFSET 1.5x17GA.CP		-	_	1/2"	1-1/2"	1-1/2"	2,4
P-3	URINAL	AMERICAN STAND	6515.001 (URINAL)	SLOAN "ROYAL" #995-1	_	SLOAN HY33A	_	_	3/4"	2"	2"	-
			MODEL #	FILICIA VALVE (FALIGET				1		l		
SYM	DESCRIPTION	MANUFACTURER	MODEL #	FLUSH VALVE/FAUCET	TRAP	ACTUATOR	DRAIN	HW	CW	WASTE	VENT	NOTES
P-4					-	_	_					_
P-5	EXTERIOR HOSE BIB	WOODFORD	B65, LOCKING COVER						3/4"	-	_	_
P-6								_	-			
P-7				<u> </u>	-	-	-	_	_	_	-	
P-8	FLOOR DRAIN	TRAVIS	RM54960 (RESTROOM & CONCESSION-QTY 5)		-	_	-	_	_	2"	2"	5
12-0	FLOOR DRAIN	SIOUX CHIEF	840-2A (CHASE-QTY 1)	△ -	-	_	-	-	-	2"	2"	5
			Y									

NOTES: 1. OFFSET FLUSH VALVE TAILPIECE PER ADA, RIGHT OR LEFT HAND, AS REQUIRED. PROVIDE FLUSH VALVE FOR 4" WALL THICKNESS.

2. HAMMER ARRESTOR JRS520-T-C, FLOOR DRAIN S2005A025NBLP, TRAP PRIMER- MIFAB MM500, DISTR UNIT- MIFAB

THROUGH

NTS

3. MOUNT RIM OF P-1 & P-3 AT 17" ABOVE FLOOR.

4. 1/2X15 COMP ANG LAV BSCR1915AC.

5. TRAP PRIMER- MIFAB MM500, DISTR UNIT- MIFAB

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58640 STATE ROAD 15
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his document is certified as being in conformance with


California Health & Safety - Code Section 18028
PLAN APPROVAL NO.: PEI 20-4411

APPROVED BY: IPH

DATE APPROVED: 08/24/2020

DATE OF EXPIRATION: 11/24/2021

deviation from the requirement of the applicable State codes.

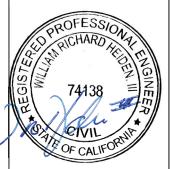

August 23, 2020



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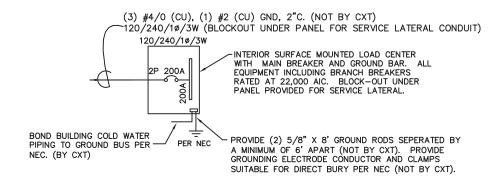
PROJECT TITLE
SANTIAGO
BUILDING NUMBER S-301

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		CAT Incom	porate			
EV.		DESCRIPTION		APPROVA	L	DATE
CA	LE	3/16"=1'-0	DATI	Ε	С	7-16-2
RAWN		FM5	FILE NO.		S-301	
ΉE	CKED	FM5	M5 PLO			4

PLUMBING DETAILS, DIAGRAMS & SCHEDULES

o. S-33 SHEET RE



ONE-LINE POWER DIAGRAM

GENERAL ELECTRICAL NOTES

- 1. RECESSED JUNCTION BOXES FOR SINGLE DEVICES SHALL HAVE SINGLE GANG MUD RINGS CAST IN CONCRETE WALLS.
- 2. ALL RECEPTACLES SHALL BE GFCI PROTECTED BY CIRCUIT BREAKERS, OR BY OTHER GFCI RECEPTACLES.
- 3. ALL CONDUIT SHALL BE SIZED PER NEC. (SEE REF TABLE) EXPOSED CONDUIT SHALL BE EMT/FMC, RECESSED SHALL BE PVC.
- 4. INSTALL ALL WIRING IN CONDUIT OR RELATED ENCLOSURES.
- ALL ELECTRICAL INSTALLATIONS SHALL MEET THE 2019 VERSION OF THE CALIFORNIA ELECTRICAL CODE.
- 6. MINIMUM WIRE SIZE SHALL BE #12 AWG COPPER, THHN INSULATION UNLESS NOTED OTHERWISE.
- 8. ROUTE ALL CONDUITS IN UTILITY ROOM AT CEILING OR FACE OF WALLS.
- 9. ELECTRICAL DRAWINGS ARE DIAGRAMMATIC IN NATURE & MAY NOT SHOW EXACT LOCATIONS OF DEVICES. REFER TO WALL PANEL & OTHER DRAWINGS FOR EXACT LOCATIONS OF J-BOXES, ETC..
- 10. CIRCUIT BREAKER LOCKOUT REQUIRED FOR EACH HAND DRYER.

	IP RFACE MOUNT			12	P. 0/24	ANEI			ONNECTED LCULATED			7,276 7,572	
	CIRCUIT			LOAD				CIRCUIT				LOAD	
NO.	DESCRIPTION	OCP	TYPE	(VA)	(A)	РН	NO.	DESCRIPTION		OCP	TYPE	(VA)	(A)
1	EXTERIOR LIGHTS	1P/20A	С	42	0.4	Α	2	WOMENS LIGHTS / EXHAUST F.	AN	1P/20A	N	126	1.1
3	CHASE LIGHTS	1P/20A	N	56	0.5	В	4	WOMENS RECEPTACLES		1P/20A	R	360	3.0
5	MENS LIGHTS / EXHAUST FAN	1P/20A	N	126	1.1	Α	6	WOMENS HAND DRYER #1		1P/20A	N	1,140	9.5
7	MENS RECEPTACLES	1P/20A	R	360	3.0	В	8	WOMENS HAND DRYER #2		1P/20A	N	1,140	9.5
9	MENS HAND DRYER #1	1P/20A	L	1,140	9.5	Α	10	FAMILY R.R. LIGHTS & FAN		1P/20A	N	146	1.3
11	MENS HAND DRYER #2	1P/20A	N	1,140	9.5	В	12	FAMILY R.R. RECEPTACLE		1P/20A	R	180	1.5
13	CHASE RECEPTACLE	1P/20A	R	180	1.5	A	14	FAMILY R.R. HAND DRYER		1P/20A	N	1,140	9.5
15						В	16						
17						Α	18						
19						В	20						
21						Α	22						
23					•	В	24						
25						Α	26						
27						В	28						
29			·			Α	30						
31						В	32						
33						Α	34						
35						В	36						
37						Α	38						
39						В	40						
							L	OAD	CONNECTI	ED	CAL	.CULATE	:D
NO	DTE: MAXIMUM ALLOWABLE AIC IS 22K	AMPS,	PANEL	-			(C)(ONTINUOUS	42 X	1.25		53 V	/A
MC	DDIFICATIONS WILL BE REQUIRED (NOT BAPACITY EXCEEDS 175 KVA.	Y CXT)	IF TR	ANSFOR	MER		(R)E	EC (1ST 10KVA)	1,080 X	1.00		1,080 V	/A
0	GFACITI EXCEEDS 175 KVA:						(N)	ON-CONTINUOUS	5,014 X	1.00		5,014 V	/A
	/,0						(L)A	ARGEST MOTOR	1,140 X	1.25		1,425 V	′A
	. 🗙							TOTAL LOAD	7,27	6 VA	-	7,572 V	/A
									•			.6 AMP	

PANEL SCHEDULE

(574) 533-03	
(574) 533-9	9736 - Fax
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STATE OF CALIFO	RNIA APPROVED
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APPROVED BY:	IPH
DATE APPROVED:	08/24/2020
DATE OF EXPIRATION:	11/24/2021
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PROGRESSIVE ENGINEERING, INC.

58640 STATE ROAD 15

EXHAUST FAN SCHEDULE							
MYZ	MFR	MODEL #	CFM	SONES	VOLTS	AMPS	NTS.
EF-1	FANTECH	FG-6	305	6.0	120	0.58	1
EF-2	FANTECH	FG-4XL	173	6.0	120	0.75	1

NOTE 1. INLINE CENTRIFUGAL FAN, OCCUPANCY SENSOR CONTROLLED, PROVIDE DUCTING AND ROOF EXHAUST CAP.

			LIGHTING FIXTURE SCHEDULE
FIXTURE NUMBER	VOLTAGE	WATTS	DESCRIPTION
А	120	28	LUMINAIRE VPF84 INTERIOR LIGHT FIXTURE, VPF8-4-28W HP-4000K-120-CP-WHT-WET-OCC-TX/SD SURFACE MOUNTED, LED LAMP 4 FT, WRAP AROUND LENS, LOW TEMPERATURE DRIVER, BUILT IN OCCUPANCY SENSOR ACTIVATED W/ ADDITIONAL OCCUPANCY SENSOR FOR FAN CONTROL
В	120	14	SWOOP 610 LED EXTERIOR LIGHT, YWP610-14W HP-3500K-120-CP-BRZ-CAB/PC EXTERIOR, VANDAL RESISTANT, WALL MOUNTED, 14 WATT, CLEAR PRISMATIC LENS, BUILT IN PHOTOELECTRIC CONTROL
С	120	28	LUMINAIRE VPF84 INTERIOR LIGHT FIXTURE, VPF8-4-28W HP-400K-120-CP-WHT-WET-DCC-TX/SD SURFACE MOUNTED, LED LAMP 4 FT, WRAP ARDUND LENS, LOW TEMPERATURE DRIVER, BUILT IN DCCUPANCY SENSOR ACTIVATED W/ WALL SWITCH OVERRIDE

NOTE : THE SOURCE OF EFFICACY OF EXTERIOR LIGHTING IS TO BE A MINIMUM DF 45 LUMENS PER WATT.



August 23, 2020



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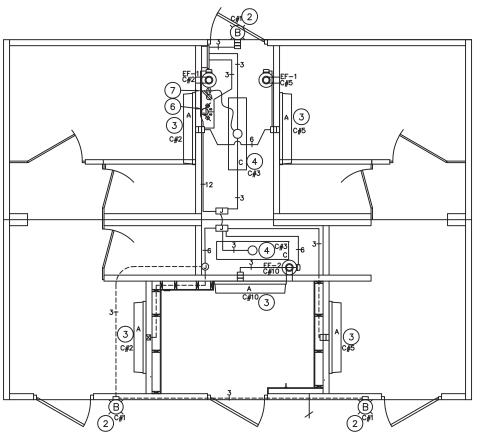
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DRA		FM5	FILE	NO.	S	-301
CHE	CKED	FM5	PLO	Т	6	4

ELECTRICAL SCHEDULES

S-34


DWG NO.




LIGHTING & EXHAUST FAN PLAN

KEY NOTES

- (1.) WIRE EF-1 THROUGH SPEED SWITCH AND OCCUPANCY SENSOR.
- (2.) LIGHT FIXTURE TO BE CONTROLLED BY INTEGRAL PHOTOCELL.
- 3) RESTROOM LIGHTS TO OPERATE BY OCCUPANCY SENSOR.
- 4. LIGHT FIXTURE TO BE CONTROLLED BY OCCUPANCY SENSOR W/ WALL SWITCH OVERRIDE.
- (5) CIRCUIT AS NEEDED FOR THE LOAD OF THE EXHAUST FAN. EXHAUST FANS SHALL TURN ON VIA OCCUPANCY SENSOR, WIRE THROUGH SPEED SWITCH IN CONCESSION.
- 6. FAN SPEED CONTROLS, ONLY ONE SHOWN FOR CLARITY.
- (7.) COMBO CHASE LIGHT SWITCH & CHASE DUTLET

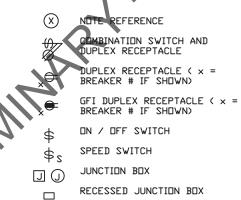

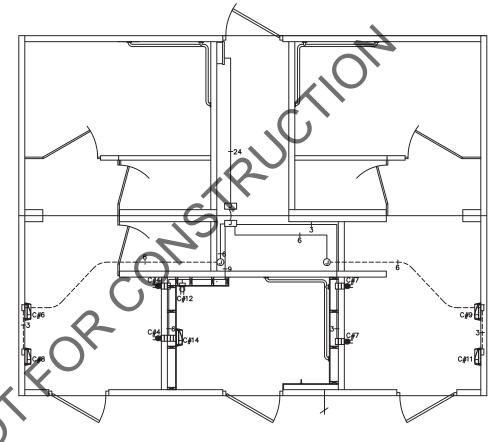

HAND DRYER & RECEPTACLE PLAN

SYMBOLS



LOAD CENTER "A" WALL MOUNTED LED LIGHT FIXTURE



CEILING MOUNTED LED LIGHT FIXTURE

 \boxtimes

HAND DRYER

WATER HEATER

(WH)

EXTERIOR LIGHT FIXTURE

마

 $\langle x \rangle$

SAFETY DISCONNECT

PANEL OR DEVICE AS NOTED

THERMOSTAT

HEATER

CEILING FAN

SURFACE MOUNTED CONDUIT, CROSSHATCH OR SLASH AND NUMBER DENOTES WIRES, (ALL #12AWG UND, UNLESS NOTED) DNE WIRE TO BE GROUND

CONCEALED CONDUIT

ELECTRIC DOOR LOCK

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PLAN APPROVAL NO.: APPROVED BY: DATE APPROVED:

PEI 20-4411 IPH DATE OF EXPIRATION: 11/24/2021

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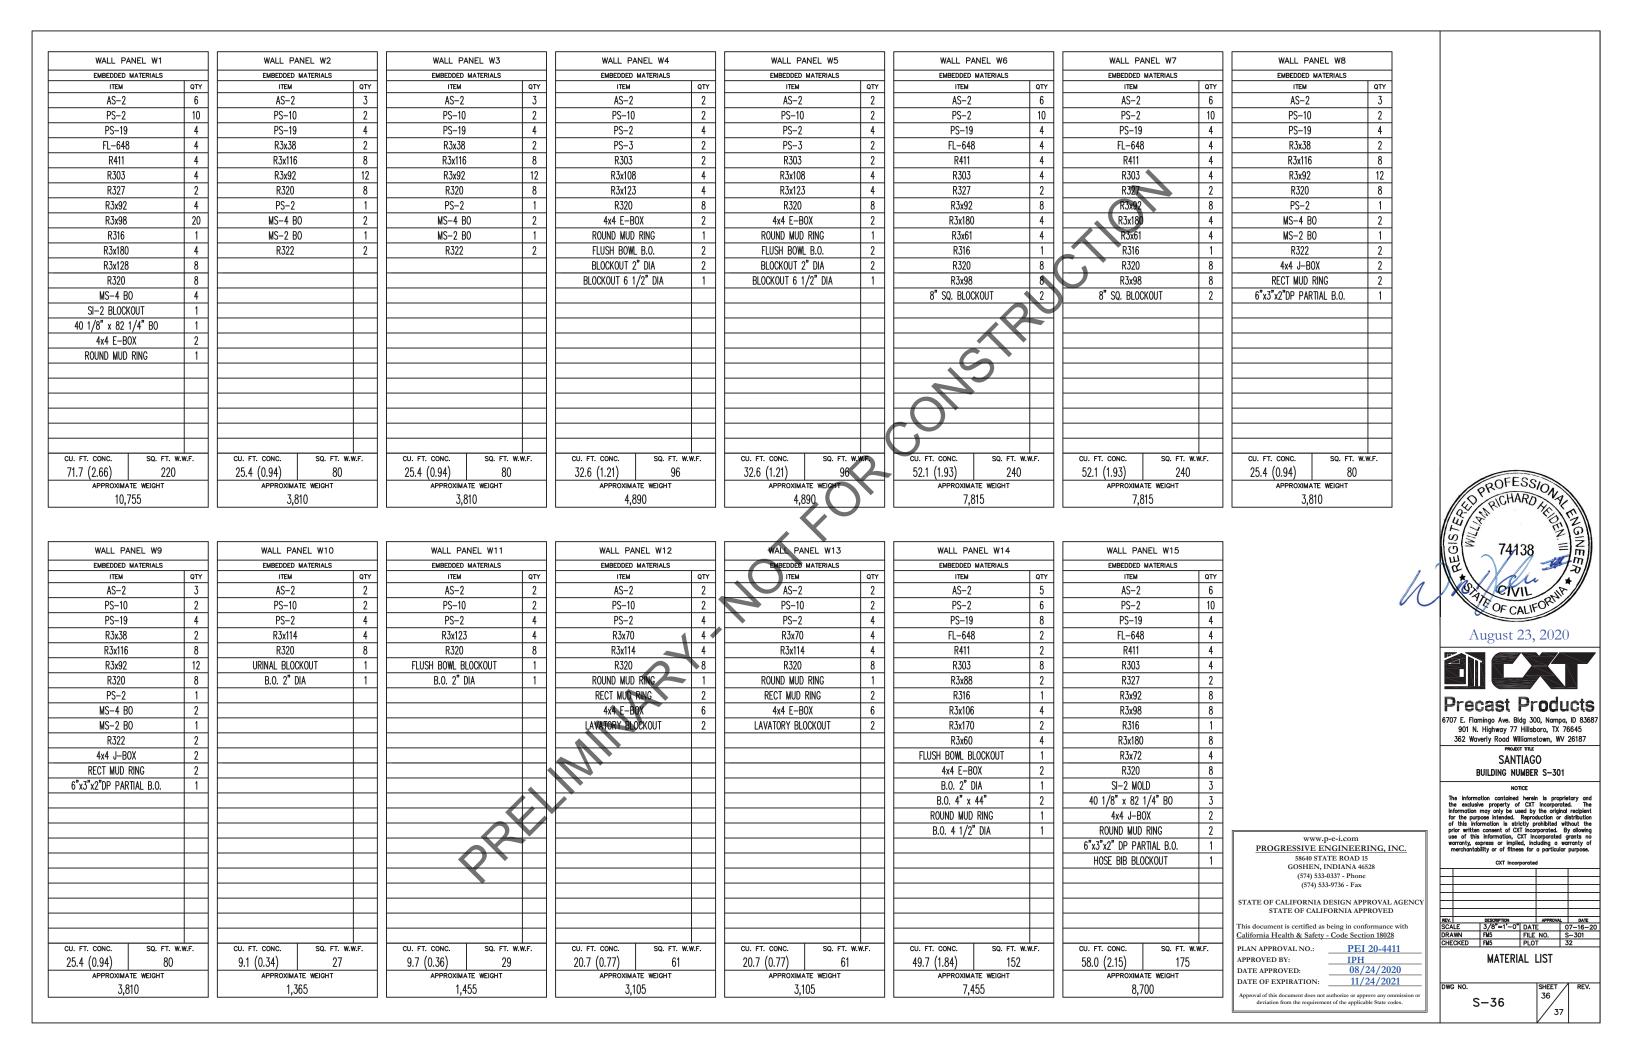
SANTIAGO BUILDING NUMBER S-301

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| DESCRIPTION | APPROVAL | DATE | 3/16"=1"-0" DATE | 07-16-20 | PM5 | FILE NO. S-301 | FM5 | PLOT | 64 |

ELECTRICAL PLAN

S-35



FI OOR I	PANEL F1	
EMBEDDED	MATERIALS	QTY
PS-19	<u> </u>	22
AS-3		-
		4
AS-1		4
PS-3		2
R303		6
R3x60		2
R4x112	<u>)</u>	8
R3x172	2	8
R3x72		4
R3x42		12
R3x116		2
1'-6"x4'-0	" B0	1
1" PVC SCH40		2
RM54960		2 2 2
P.T. CHU		2
B.O. 6"		1
5.0. 0	y	Ė
	1	
CU. FT. CONC.	SQ. FT. W.	W.F.
105.3 (3.90)	520 ATE WEIGHT	
10,	795	


FLOOR PANEL	
EMBEDDED MATE	
ITEM DC 10	QTY
PS-19	31
AS-3	4
AS-1	4
R3x218	4
R303	13
R3x60	2
R4x112	8
R3x172	8
R3x42	12
R3x116	
1'-6"x1'-6" BO	1
RM54960 F.D.	3
1" PVC SCH40 x9'-	2 1 3 9" 2
PT CHUCK	2
CU. FT. CONC.	SQ. FT. W.W.F.
106.7 (3.95)	520
APPROXIMATE W	
16,005	

ROOF PAN	IEL R1-R	
EMBEDDED	MATERIALS	
ITEM		QTY
PS-19		11
FL-847	1	4
FL-648	1	4
R411		4
R303		11
R3x134		4
R3x175		2
R3x176		2 4
R320		4
PS-2		2
1" PVC SCHD40	x11'-3"	1
R4x18		16
BO 5" D	IA	1
PT CHUC		1
B.O. 6 1/2*	DIA	1
MS-12		1
R4x134		4
R4x174		4
CU. FT. CONC.	SQ. FT. W	v.w.F.
69.7 (2.58)	344	
APPROXIMA	TE WEIGHT	

ROOF PAN		
EMBEDDED	MATERIALS	QTY
PS-19		11
FL-847	,	4
FL-648		4
)	4
R303		11
R3x134		4
R3x175		- 2
R3x176		2 4
R320		
PS-2	2	2
1" PVC SCHD40	x11'-3"	
R4x18		16
R4x174		4
PT CHUC		1
B.O. 6 1/2"	' DIA	1
MS-12		1
R4x134		4
CU. FT. CONC.	SQ. FT. W.W	.F.
69.7 (2.58)	344	
APPROXIMA		

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ROOF PANEL R2-L							
EMBEDDED MATERIALS							
ITEM	QTY						
PS-19	16						
FL-847	4						
FL-648	4						
R411	4						
R303	16						
R3x134	4						
R3x175	2						
R3x176	2						
R320	4						
PT CHUCK	1						
1" PVC SCHD40 x11'-3"	1						
PS-2	2 ,						
R4x18	16						
4x4 J-B0X	1						
8"x3"x3" DP PARTIAL B.O. 2							
MS=12 1							
R4x134 4							
R4x174	4						
2							
)							
)							
CU. FT. CONC. SQ. FT. W.W.F.							
69.7 (2.58) 344							
APPROXIMATE WEIGHT							
10,455							



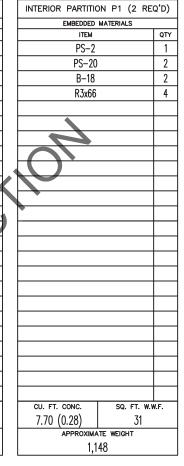

August 23, 2020



6707 E. Flamingo Ave. Bldg 300, Nampa, ID 83687 901 N. Highway 77 Hillsboro, TX 76645 362 Waverly Road Williamstown, WV 26187

SANTIAGO BUILDING NUMBER S-301

CXT Incorporated								
REV.	DESCRIPTION			APPROVAL		DATE		
SCA	LE	3/8"=1'-0"	DAT	Ε	C	7-16-2		
DRAWN		FM5	FILE NO.		S-301			
CHECKED		FM5	PLOT		32			

MATERIAL LIST

S-37

IPH 08/24/2020

DATE OF EXPIRATION: 11/24/2021 Approval of this document does not authorize or approve any ommis deviation from the requirement of the applicable State codes.

APPROVED BY: DATE APPROVED:

www.p-e-i.com
PROGRESSIVE ENGINEERING, INC.
58640 STATE ROAD 15
GOSHEN, INDIANA 46528 (574) 533-0337 - Phone (574) 533-9736 - Fax STATE OF CALIFORNIA DESIGN APPROVAL AGENCY This document is certified as being in conformance with California Health & Safety - Code Section 18028 PEI 20-4411 PLAN APPROVAL NO.: