

PROJECT LOCATION **VICINITY MAP**

PLANS FOR CONSTRUCTION

PETERSON ROAD REPAIRS AND IMPROVEMENTS

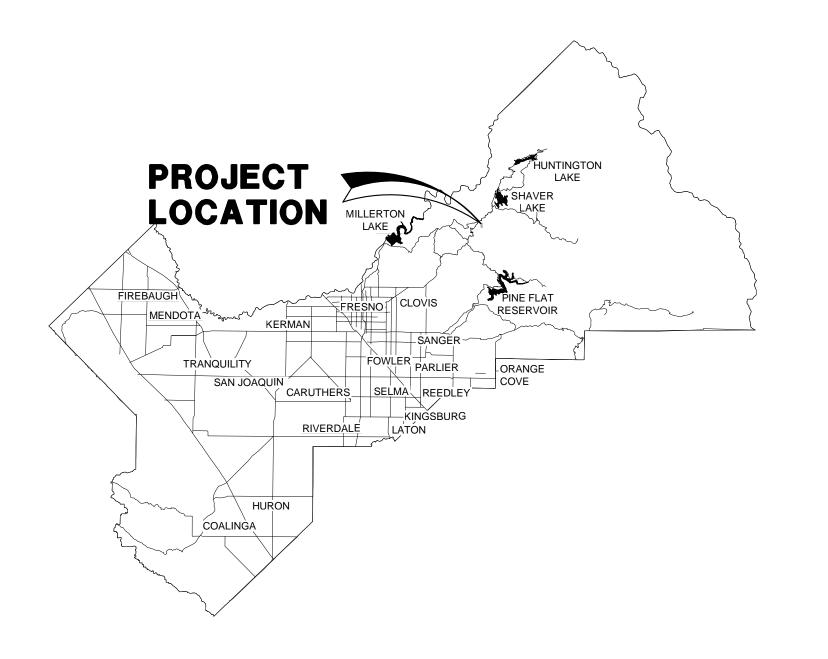

SHEET LIST TABLE						
SHEET SHEET TITLE						
1	COVER SHEET AND NOTES					
2	LEGEND AND SHEET INDEX MAP					
3	TYPICAL SECTIONS AND DETILS					
4	ROAD PLAN AND PROFILE - STA 11+00 TO 15+50					
5	ROAD PLAN AND PROFILE - STA 15+50 TO 20+00					
6	ROAD PLAN AND PROFILE - STA 20+00 TO 22+17.69					
7	CROSS SECTIONS					

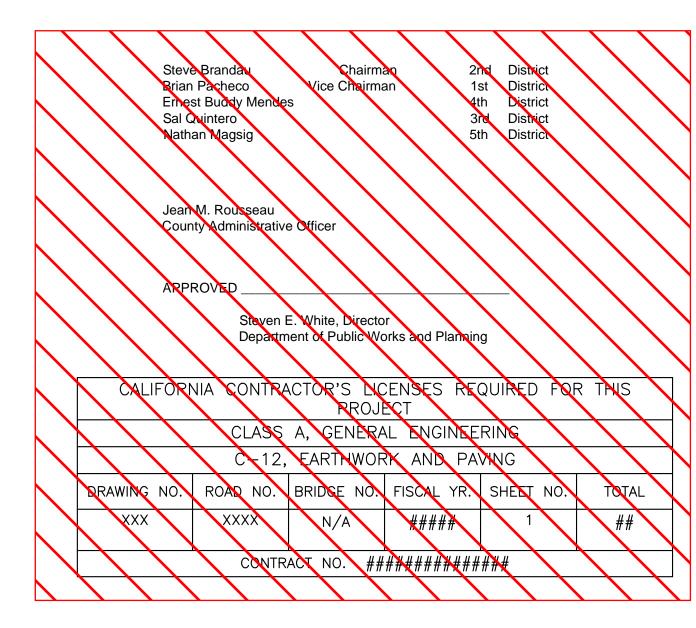

GENERAL NOTES

- 1. THE WORK EMBRACED HEREIN SHALL BE IN ACCORDANCE WITH THE APPROPRIATE PROVISIONS OF THE SPECIFICATIONS ENTITLED "IMPROVEMENT STANDARDS, COUNTY OF FRESNO, STATE OF CALIFORNIA, OCTOBER, 1966" AND AS AMENDED, INSOFAR
- 2. ALL WORK INSTALLED SHALL MEET OR EXCEED COUNTY IMPROVEMENT STANDARDS. WHERE WORK PROPOSED IS NOT ADDRESSED WITH THESE STANDARDS, THE CONTRACTOR SHALL DEFER TO THE 2018 STATE STANDARD DRAWINGS AND SPECIFICATIONS AND AMENDMENTS FOR COMPLIANCE.
- 3. BEFORE COMMENCING WORK, THE CONTRACTOR SHALL NOTIFY ALL UTILITY AUTHORITIES OR UTILITY COMPANIES HAVING POSSIBLE INTEREST IN THE WORK OF THE CONTRACTOR'S INTENTION TO EXCAVATE PROXIMATE TO EXISTING FACILITIES AND THE CONTRACTOR SHALL VERIFY THE LOCATION OF ANY UTILITIES IN THE WORK AREA. THE CONTRACTOR SHALL NOTIFY U.S.A. TWO (2) DAYS PRIOR TO BEGINNING ANY EXCAVATION.
- 4. THE COUNTY WILL COORDINATE WITH PRIVATE PROPERTY OWNERS AS REQUIRED TO OBTAIN ACCESS TO CONSTRUCT IMPROVEMENTS AS REQUIRED.
- 5. DIRT OR DEBRIS TRACKED ONTO EXISTING COUNTY ROADS FROM THIS PROJECT SHALL BE CLEANED OFF AT THE END OF EACH WORKING DAY TO THE SATISFACTION OF THE COUNTY INSPECTOR.
- 6. THE COSTS OF ALL INITIAL COMPACTION TESTING REQUIRED FOR ACCEPTANCE OF WORK WILL BE PAID BY THE COUNTY. COSTS FOR SUBSEQUENT TESTS SHALL BE PAID BY THE CONTRACTOR
- 7. TEMPORARY EROSION CONTROL SHALL BE PROVIDED IN ACCORDANCE WITH THE REQUIREMENTS OF THE PROJECT SWPPP.
- 8. ALL UNDERGROUND UTILITIES SHALL BE INSTALLED AND APPROVED PRIOR TO PAVING.
- 9. PRIOR TO THE LAYING OF THE BASE MATERIAL ON THE ROADWAY, THE COUNTY SHALL APPROVE THE SUBGRADE ELEVATIONS.
- 10. THE CONTRACTOR SHALL FURNISH ALL NECESSARY MATERIALS, LABOR, EQUIPMENT, TOOLS AND INCIDENTALS, AND SHALL DO ALL WORK NECESSARY TO CONSTRUCT ALL OF THE PROPOSED IMPROVEMENTS SHOWN OR SPECIFIED ON THE PLANS IN CONFORMANCE WITH THE COUNTY STANDARDS, WITH THE EXCEPTIONS OF EXISTING IMPROVEMENTS (UNLESS DAMAGED BY THE CONTRACTOR) AND THOSE IMPROVEMENTS SPECIFICALLY SHOWN OR SPECIFIED AS "FUTURE" OR AS "BY OTHERS".
- 11. THE RIGHT-OF-WAY LINES SHOWN ON THE PLANS AND THE PROPERTY CORNER SURVEYING RELATED TO THE CONTROL POINTS WERE PROVIDED BY THE COUNTY.
- 12. UTILITIES AND COMMUNICATIONS FACILITIES SHOWN ARE TAKEN FROM THE TOPOGRAPHIC BASE, MAPS AND PLAN DRAWINGS PROVIDED BY UTILITY AND COMMUNICATIONS COMPANIES OR AGENCIES, AND/OR FIELD SURVEYS AND INVESTIGATIONS. THEIR DEPICTION IS BASED ON THE BEST INFORMATION AVAILABLE AT THE TIME THESE DRAWINGS WERE PREPARED. HOWEVER, IT IS POSSIBLE THAT OTHER OR ADDITIONAL UTILITIES MAY EXIST THAT WERE NOT REVEALED BY THAT INFORMATION.
- 13. THE TOPOGRAPHIC AND PHOTOGRAMMETRIC SURVEYS LOCATE SPECIFIC PHYSICAL FEATURES ALONG THE PROJECT AND THEIR ELEVATIONS AS DETERMINED NECESSARY BY THE PROJECT ENGINEER. THE INFORMATION SHOWN REFLECTS THE DATA OBTAINED BY FIELD SURVEYS BY THE COUNTY AND AERIAL SURVEYS CONDUCTED BY THE PROJECT ENGINEER.
- 14. THE CONTRACTOR SHALL REPAIR WITH LIKE MATERIALS ANY EXISTING DRIVEWAYS, CURB, GUTTERS, WALKWAYS, LANDSCAPING, PLANTS, OR OTHER IMPROVEMENTS DAMAGED AS A RESULT OF THE WORK TO AN EXISTING OR BETTER CONDITION.
- 15. NO TREE ROOTS OR BRANCHES ARE TO BE DISTURBED OR PRUNED DURING CONSTRUCTION ACTIVITIES UNLESS APPROVED BY THE ENGINEER.
- 9. TWO DAYS BEFORE EXCAVATION, THE CONTRACTOR SHALL CALL UNDERGROUND SERVICE ALERT TOLL FREE AT 811.
- 10. PURSUANT TO SECTION 8771(b) AND 8771(c) OF THE GOVERNMENT CODE, ANY MONUMENTS THAT CONTROL THE LOCATION OF BOUNDARIES, OR OTHERWISE PROVIDE HORIZONTAL OR VERTICAL SURVEY CONTROL WITHIN THE CONSTRUCTION AREA, SHALL BE LOCATED AND REFERENCED PRIOR TO CONSTRUCTION, AND A CORNER RECORD OR RECORD SURVEY OF THE REFERENCES SHALL BE FILED WITH THE COUNTY SURVEYOR.
- 11. EARTHWORK SHALL CONFORM TO THE REQUIREMENTS OF THE PROJECT GEOTECHNICAL REPORT ENTITLED "PROPOSED PETERSON ROAD IMPROVEMENTS, EAST OF TOLLHOUSE ROAD, AUBERRY, CALIFORNIA," BY BSK ASSOCIATES DATED MARCH 17, 2021.

BASIS OF VERTICAL CONTROL

ELEVATIONS ARE BASED ON REFERENCE STATION "DOND" HAVING A NAVD88 ORTHOMETRIC HEIGHT OF 2283.836 US SURVEY FEET (EPOCH OF ADJUSTMENT 2017.5) PER CENTRAL VALLEY SPATIAL REFERENCE NETWORK RECORDS. THE PROJECT ELEVATION OF CONTROL POINT #300 (4082.763) WAS DETERMINED THROUGH REAL TIME KINEMATIC GPS OBSERVATIONS USING THE CENTRAL VALLEY SPATIAL REFERENCE NETWORK TIED TO REFERENCE STATION "DOND" AND USING NATIONAL GEODETIC SURVEY GEOID MODEL GEOID12B.

BASIS OF COORDINATES

THE COORDINATE SYSTEM FOR THIS PROJECT IS THE CALIFORNIA COORDINATE SYSTEM OF 1983 (CCS83), ZONE 4, AND IS TIED TO CENTRAL VALLEY SPATIAL REFERENCE NETWORK STATION "DOND". STATION "DOND" HAS CCSB3 ZONE 4 COORDINATES OF N2344103.796, E6360832.595, US SURVEY FEET, AT EPOCH 2017.50 PER CALIFORNIA DEPARTMENT OF TRANSPORTATION

CONTROL POINTS:

POINT#	NORTHING	EASTING	POINT ELEVATION	DESCRIPTION
<i>300</i> "	2266019.2470'	6457128.2390'	4082.763°	FD. 1" IP W/TAG LS 2931 DN. 8'
<i>301</i>	2266077.0230'	6456979.3690'	4085.806'	FD. 1" IP W/TAG LS 2737 DN. 6
<i>305</i>	2266427.0680'	6457212.0820'	4076.642'	FD. 1" IP W/TAG LS 2737 UP. 4

GRID TO GROUND CONVERSION

MULTIPLY DISTANCES MEASURED IN THIS PROJECT BY A COMBINED SCALE FACTOR OF 1.0002234 FOR APPROXIMATE GROUND

ROAD NO.





SUPERVISING ENGINEER

THIS DRAWING SET IS PROVIDED FOR REFERENCE TO SHOW THE **GUARDRAIL LIMITS AND GENERAL** COMPONENT LOCATIONS ONLY.

	DATE							
DESIGNED: XXXX	XX/XX/20XX	RESIDENT ENGINEER	DATE					
DRAWN: XXXX	XX/XX/20XX							
CHECKED: XXXX	XX/XX/20XX							
FOR RIGHT OF WAY DATA AND ACCURATE ACCESS DETERMINATION, SEE DOCUMENTS IN THE DEPARTMENT OF PUBLIC WORKS AND PLANNING.								

SCALE AS NOTED

DATE SIGNED: 4/30/2021 st - met DATE

PROJECT PETERSON ROAD REPAIRS AND IMPROVEMENTS

BRIDGE NO.

DEPARTMENT OF PUBLIC WORKS AND PLANNING

COVER SHEET AND NOTES

DRAWING NO. SHEET NO. 1

TOTAL 7

TOPOGRAPHIC LEGEND.

------ EDGE OF ASPHALT CONCRETE
PAVEMENT —— —— EDGE OF DIRT — — — — EDGE OF GRAVEL

EXISTING RIGHT-OF-WAY

ABBREVIATIONS AND CONSTRUCTION LEGEND

ANGLE POINT APPROXIMATE BEGIN CURVE BEGIN VERTICAL CURVE CORRUGATED METAL PIPE END CURVE EXISTING GROUND END VERTICAL CURVE **EXIST EXISTING** FINISHED GRADE HOT MIX ASPHALT MIDWEST GUARDRAIL MINIMUM PROFILE GRADE

POINT OF VERTICAL INTERSECTION


SHOULDER STATION

STORM WATER POLLUTION PREVENTION PLAN

TRANSITION


PAVEMENT STRUCTURAL SECTION PER DETAIL (E)3" HOT MIX ASPHALT OVER NATIVE SOIL COMPACTED TO 95% RELATIVE COMPACTION PER CALIFORNIA TEST METHOD NO. 216


APPROXIMATE LIMITS OF EROSION CONTROL BLANKET; SEE NOTE ON SHEET 3

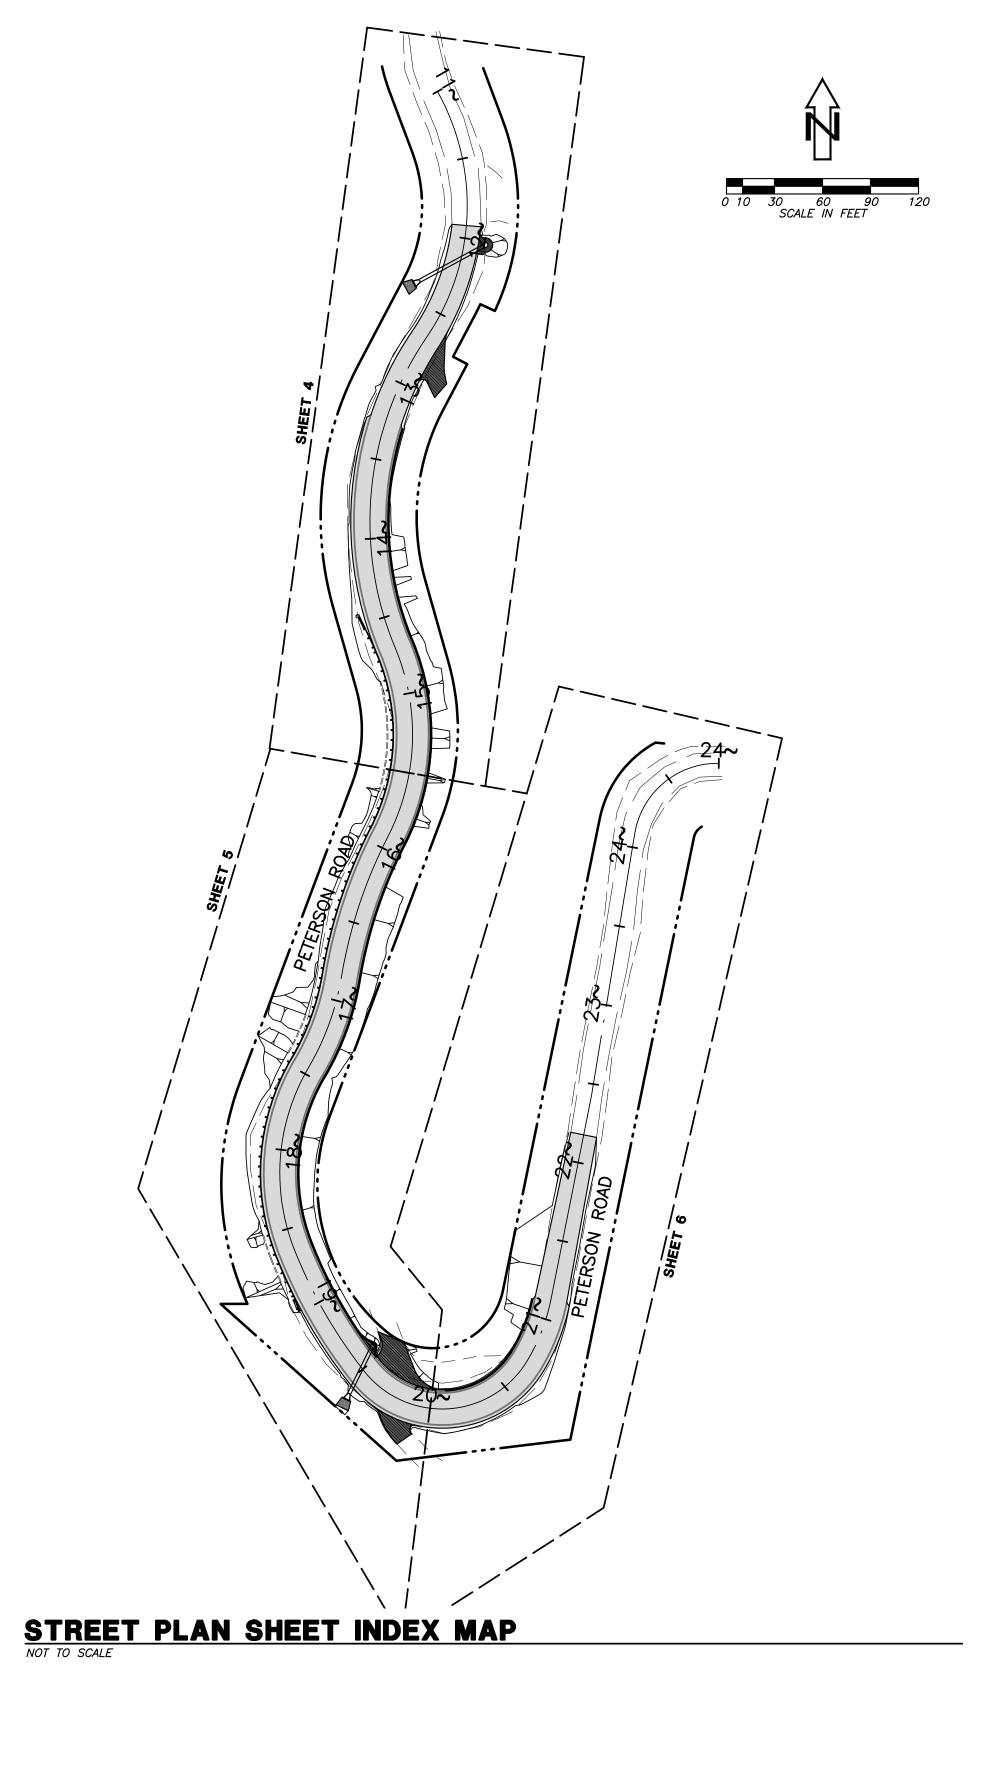



PROJECT SCALE RESIDENT ENGINEER PETERSON ROAD XX/XX/20XX DESIGNED: XXXX REPAIRS AND IMPROVEMENTS DRAWN: XXXX XX/XX/20XX AS NOTED CHECKED: XXXX XX/XX/20XX DATE SUPERVISING ENGINEER BRIDGE NO. FOR RIGHT OF WAY DATA AND ACCURATE ACCESS DETERMINATION, SEE DOCUMENTS IN THE DEPARTMENT OF PUBLIC WORKS AND PLANNING. ROAD NO. DRAWING NO.


DEPARTMENT OF PUBLIC WORKS AND PLANNING LEGEND AND SHEET INDEX MAP TOTAL 7 SHEET NO. 2

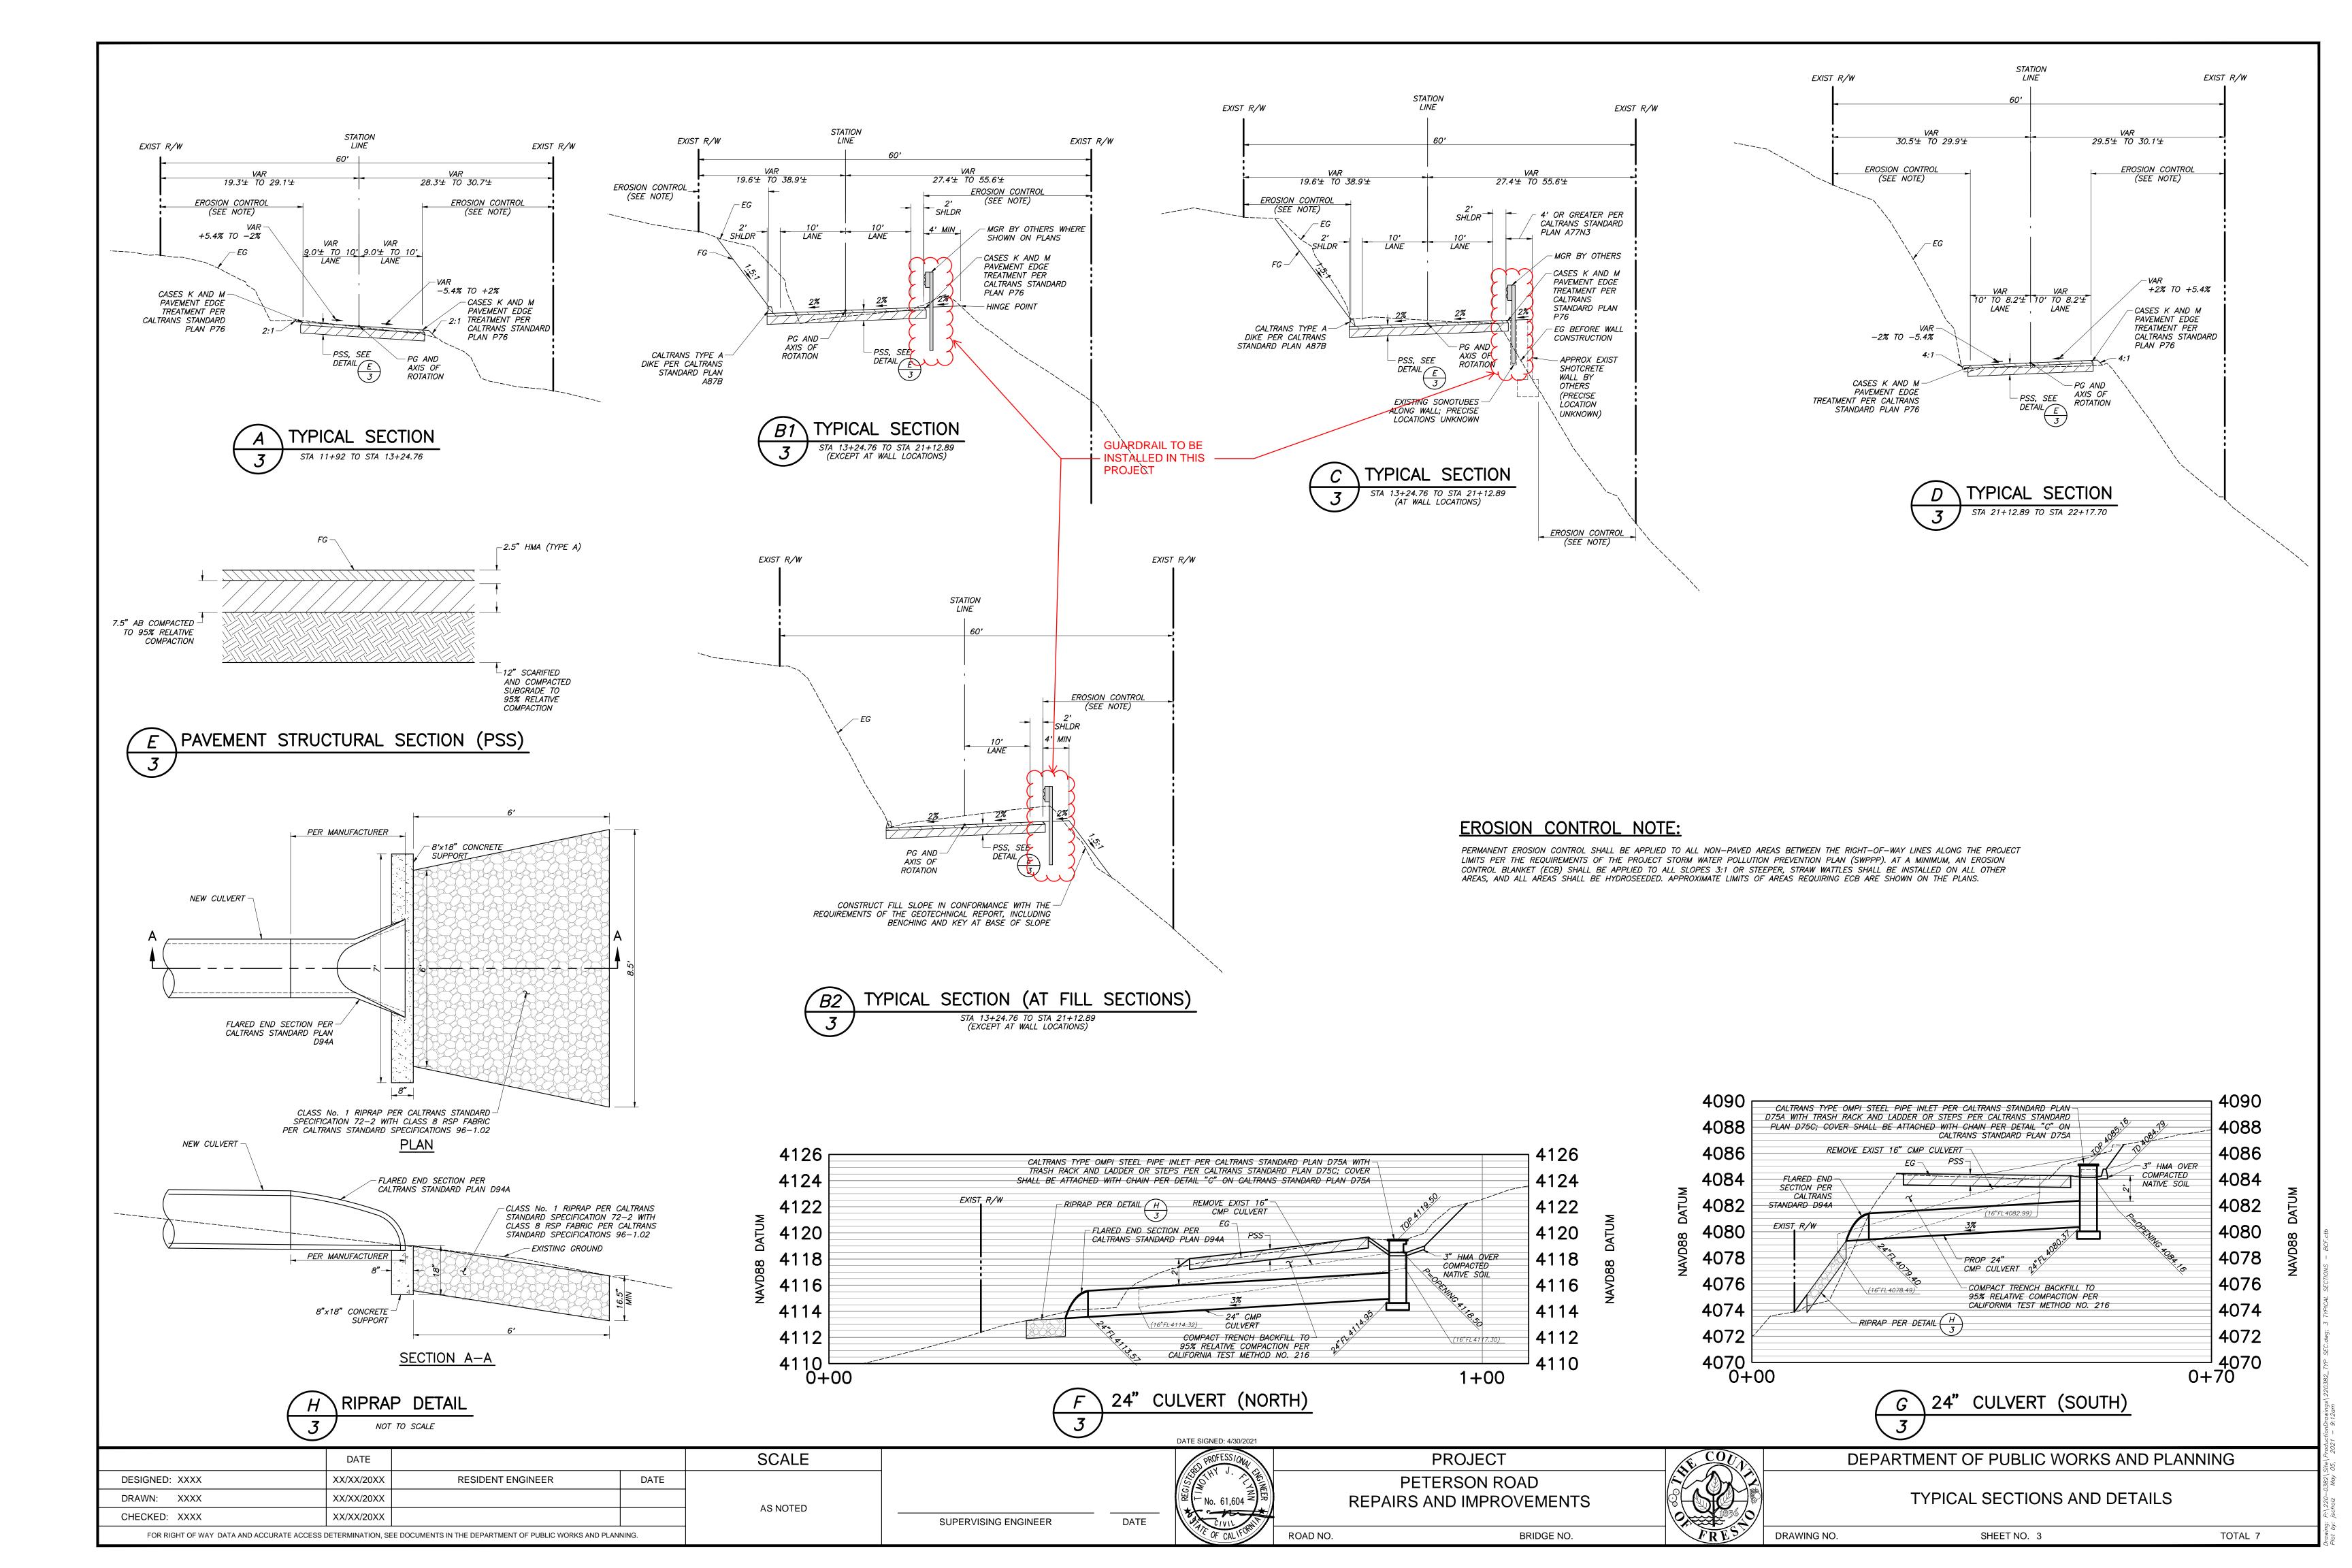

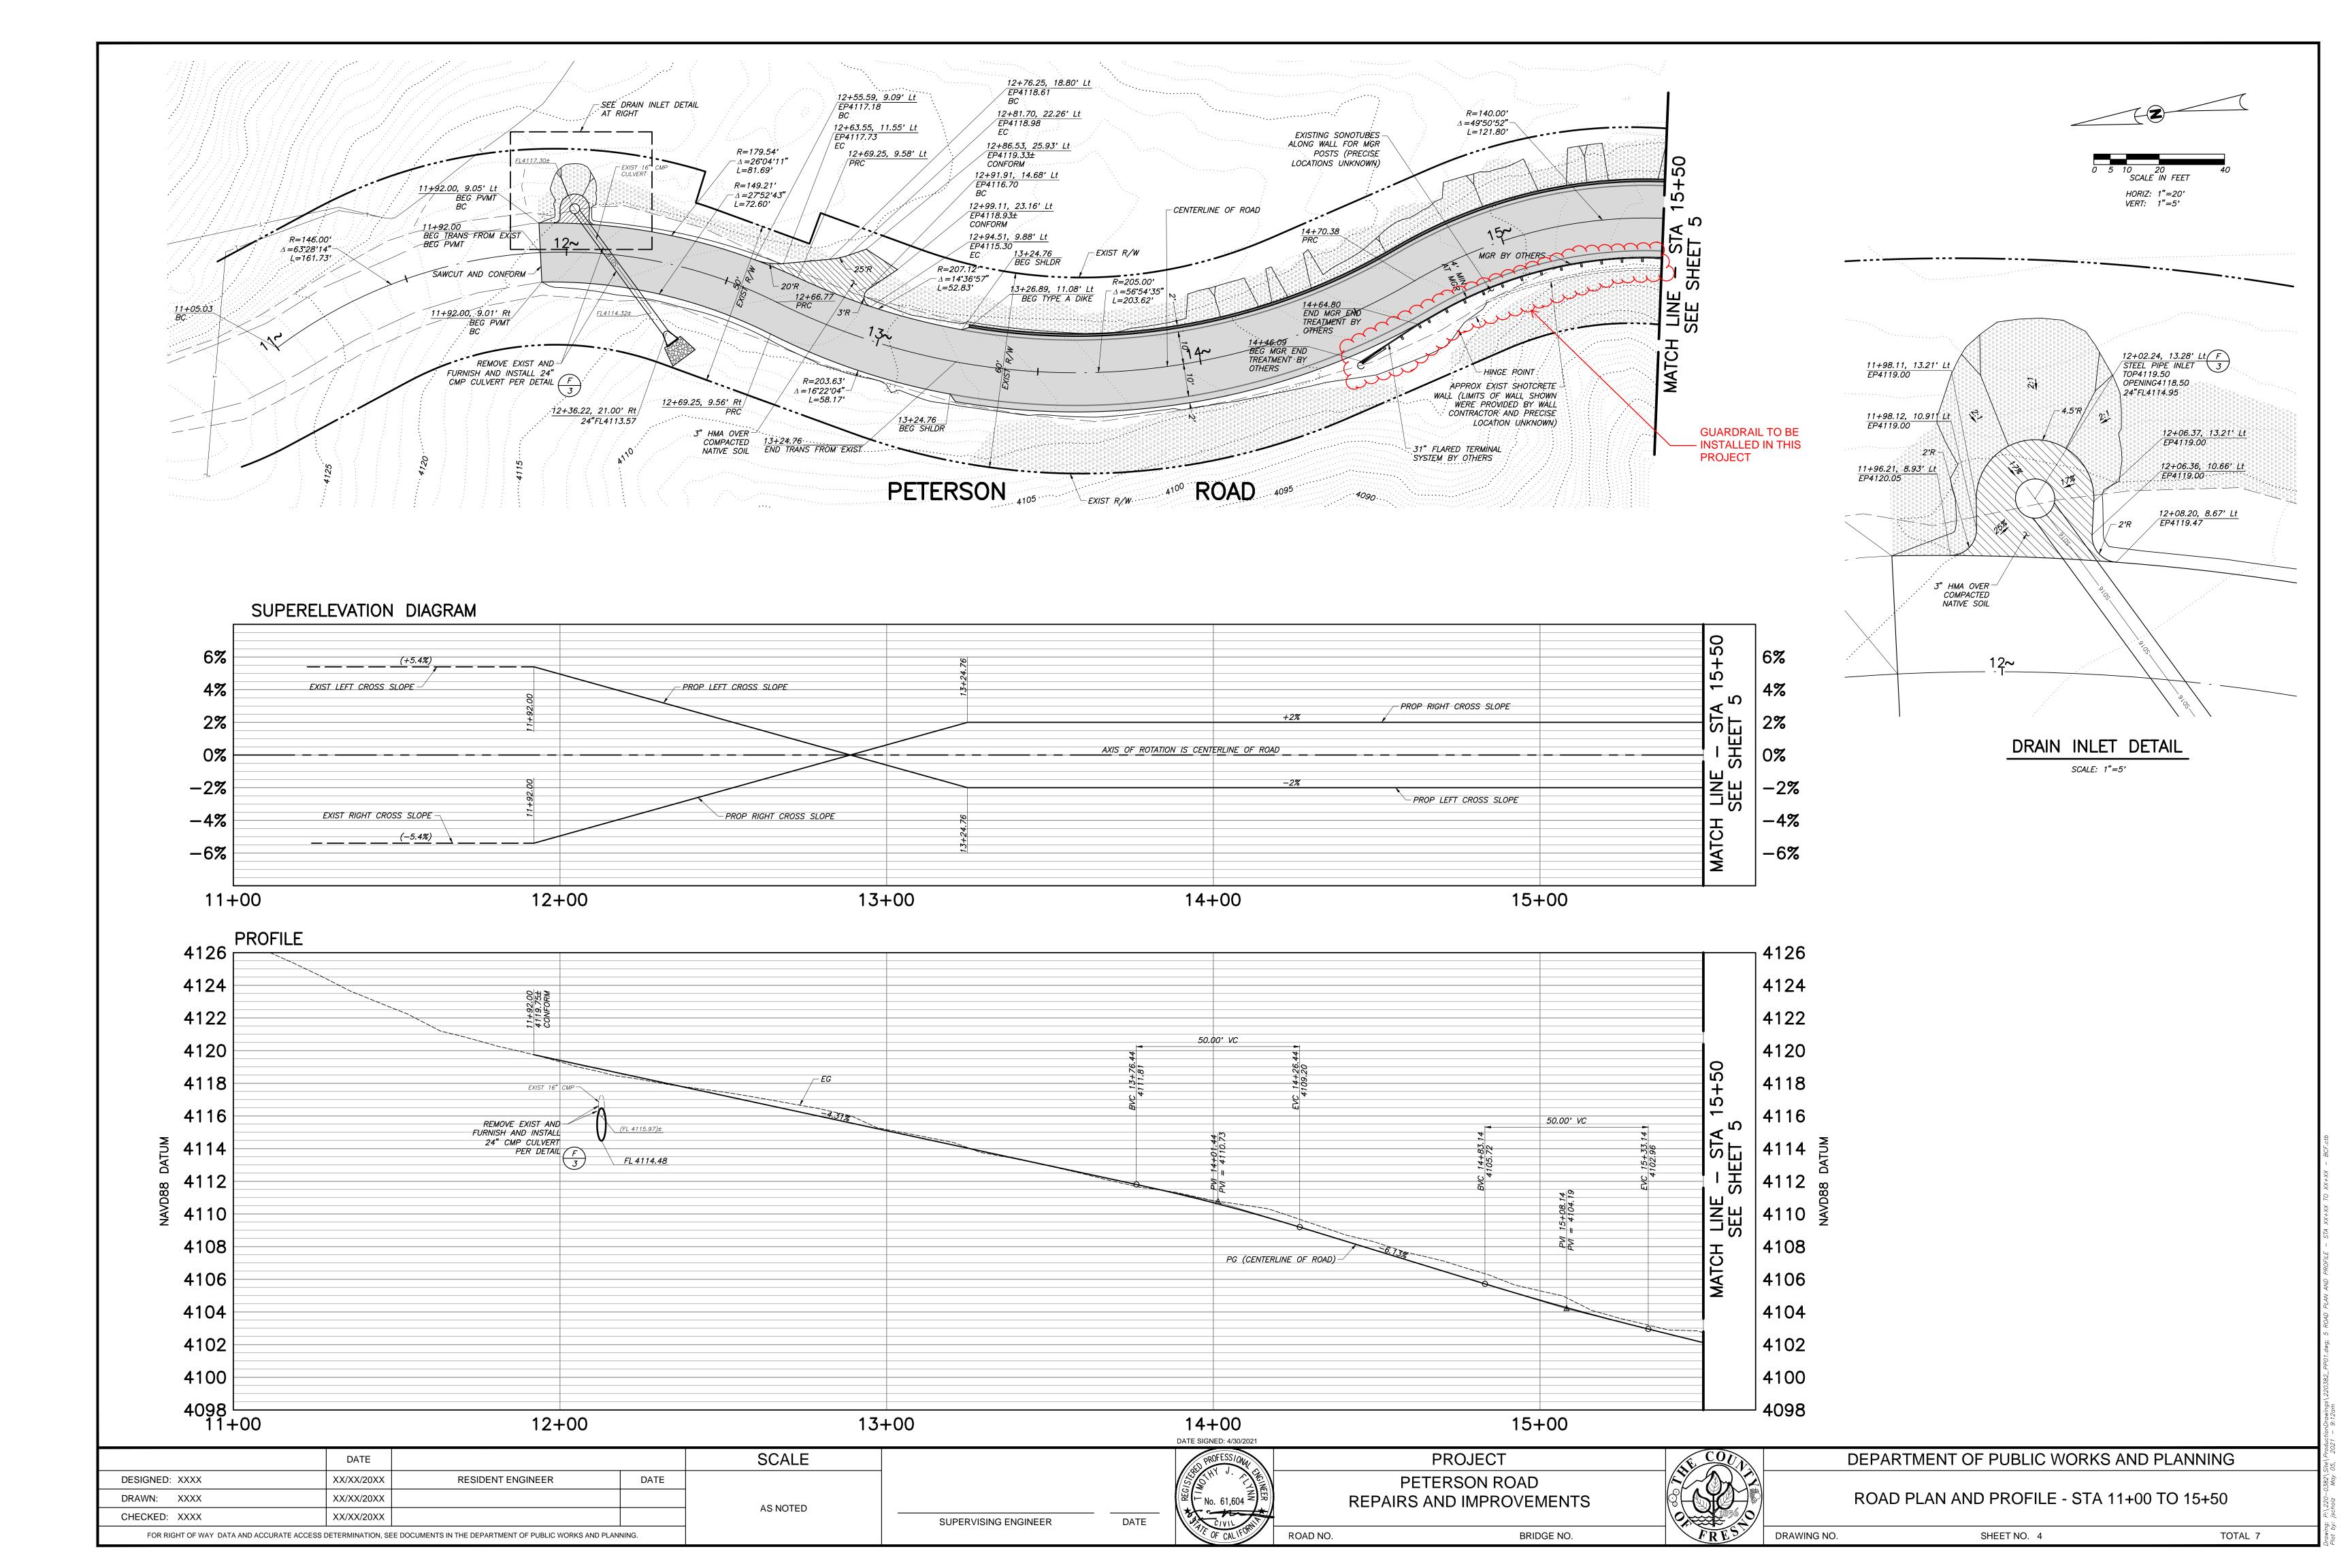

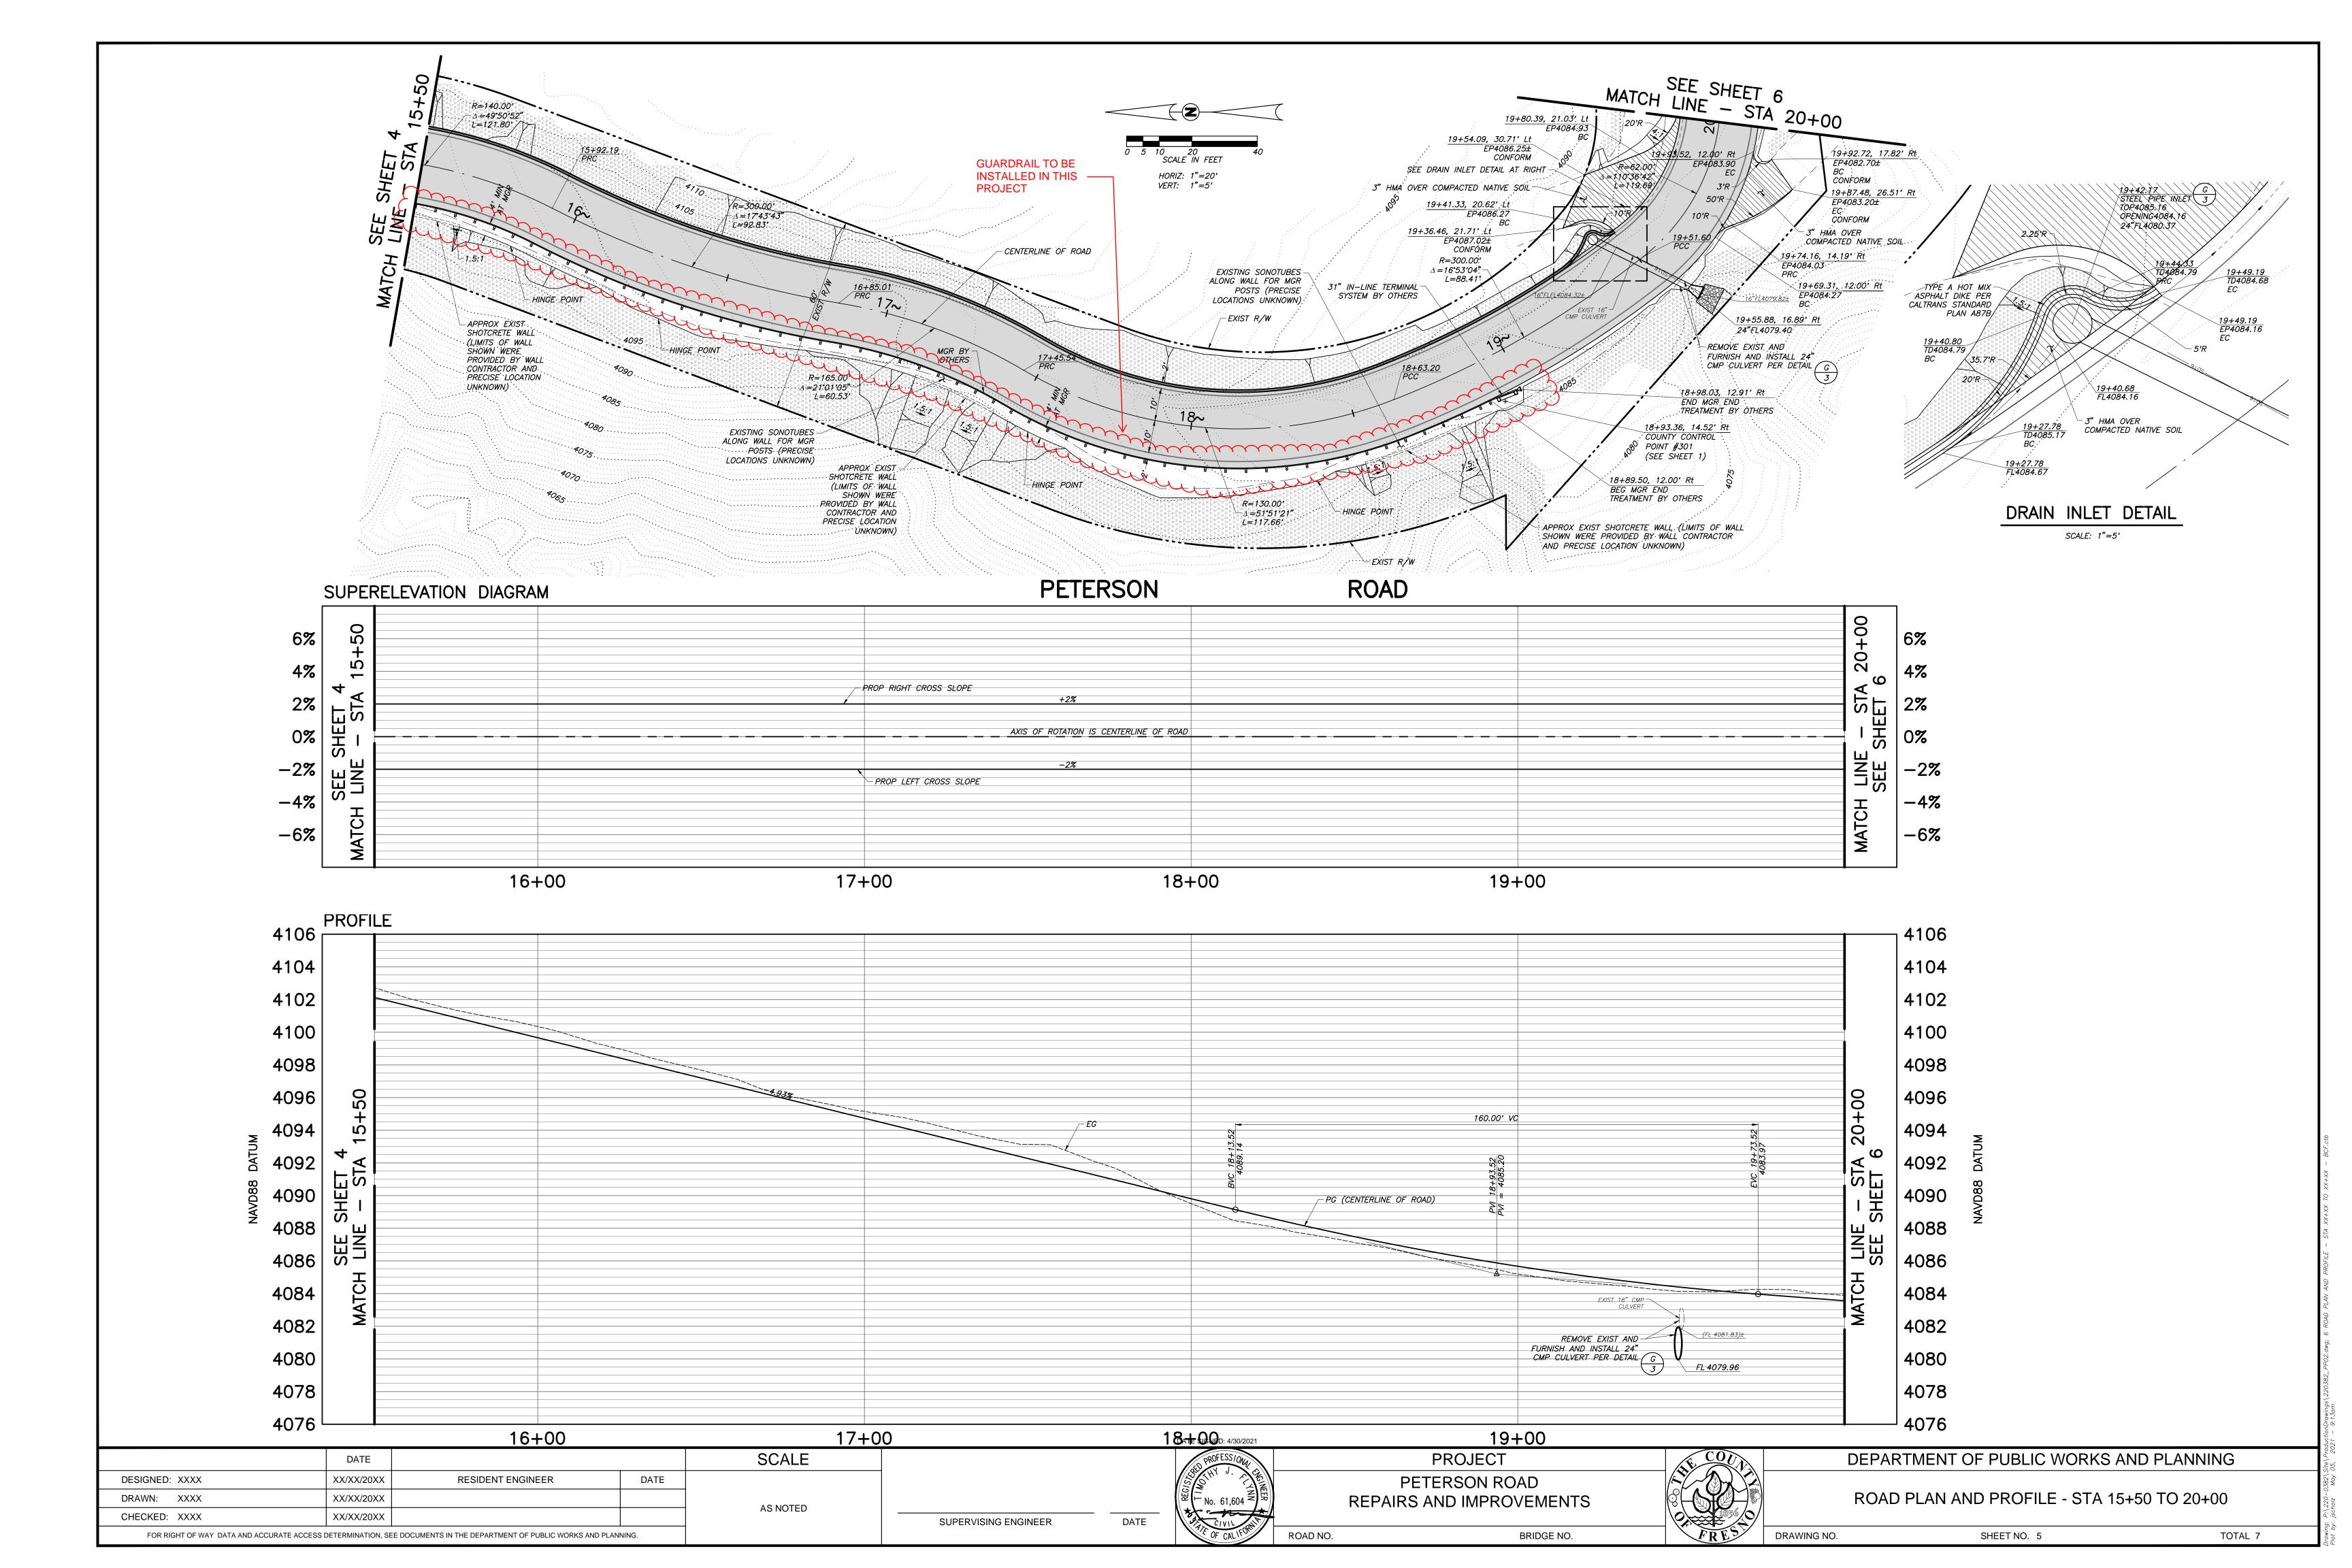

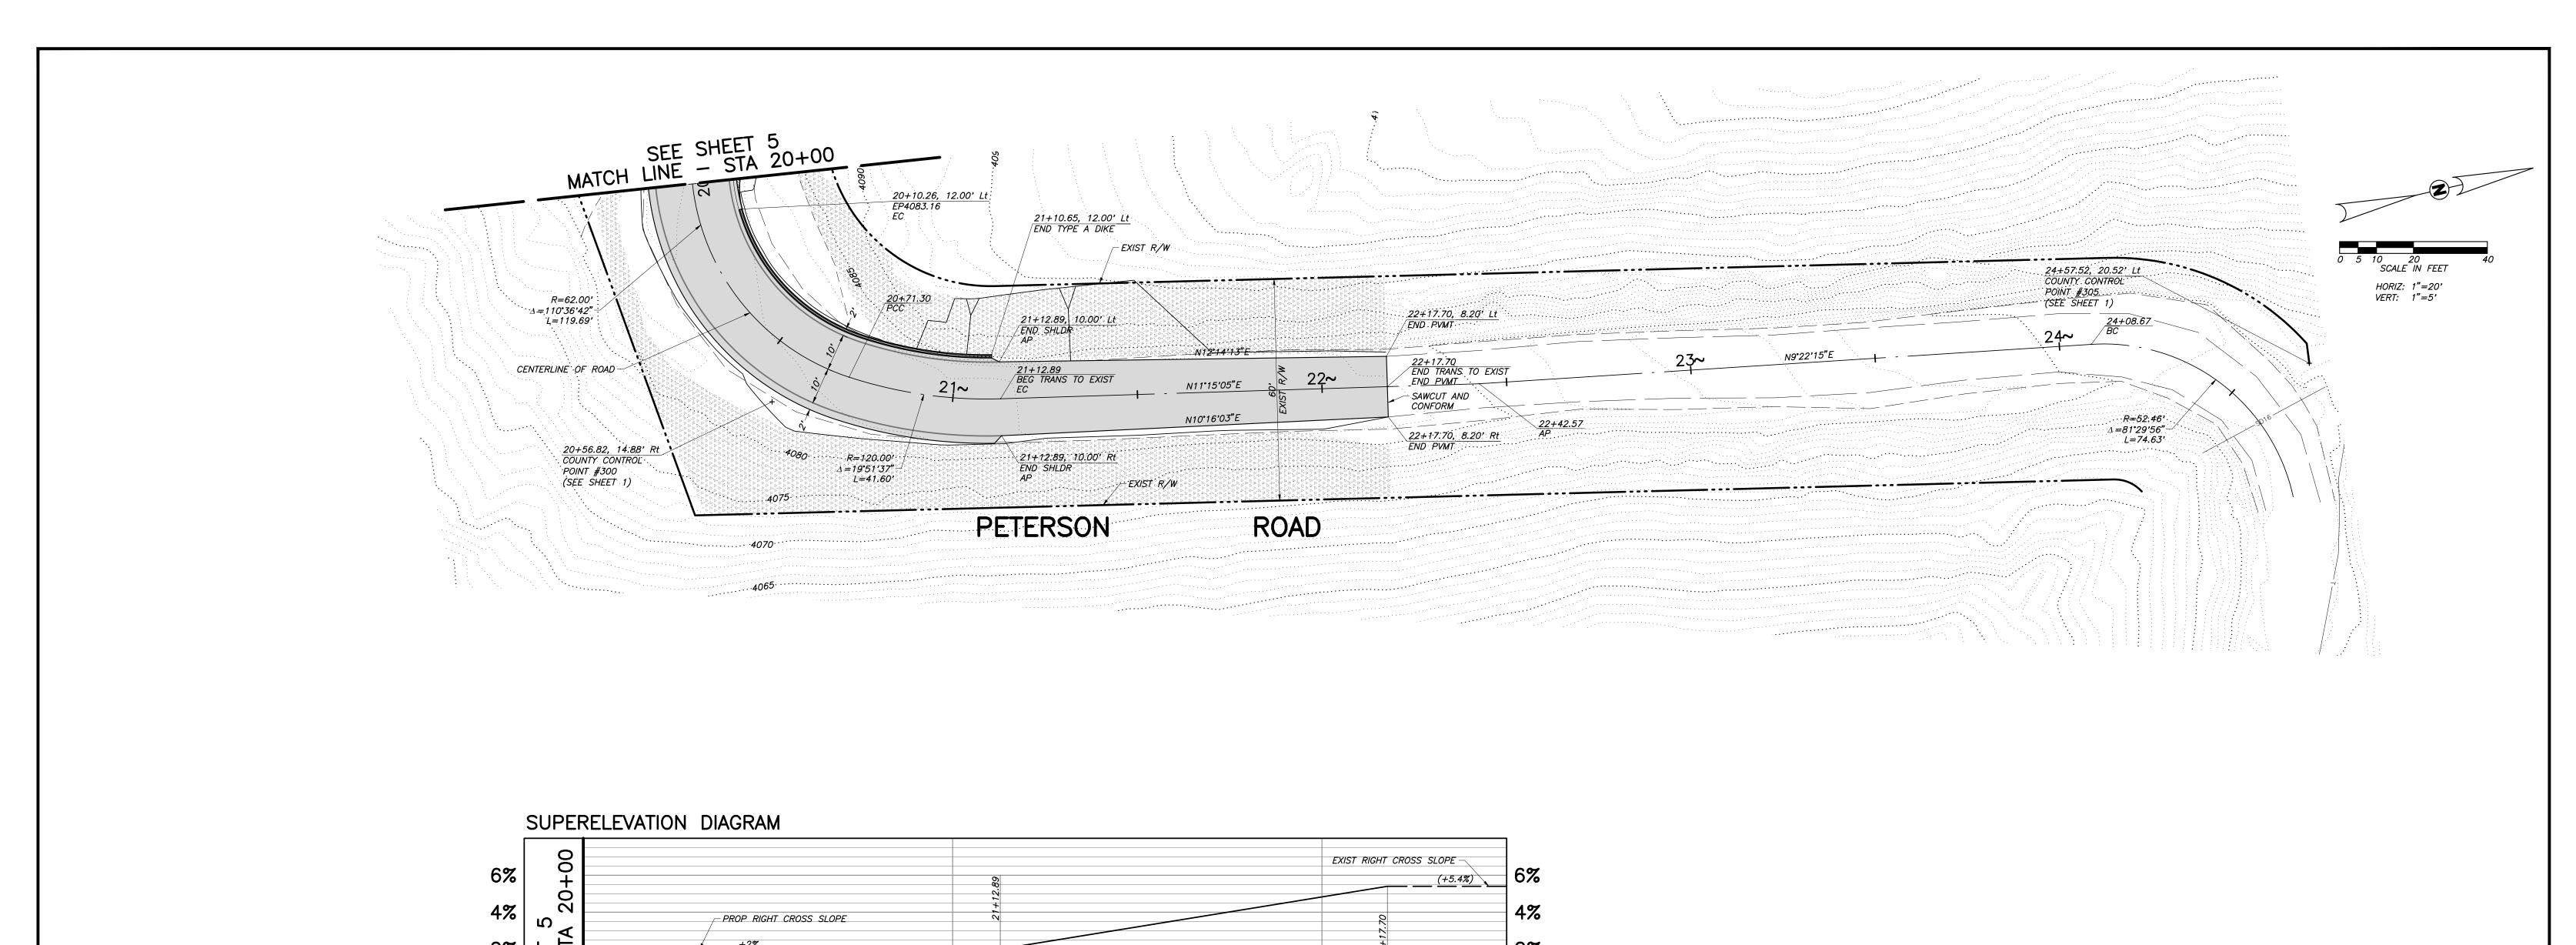

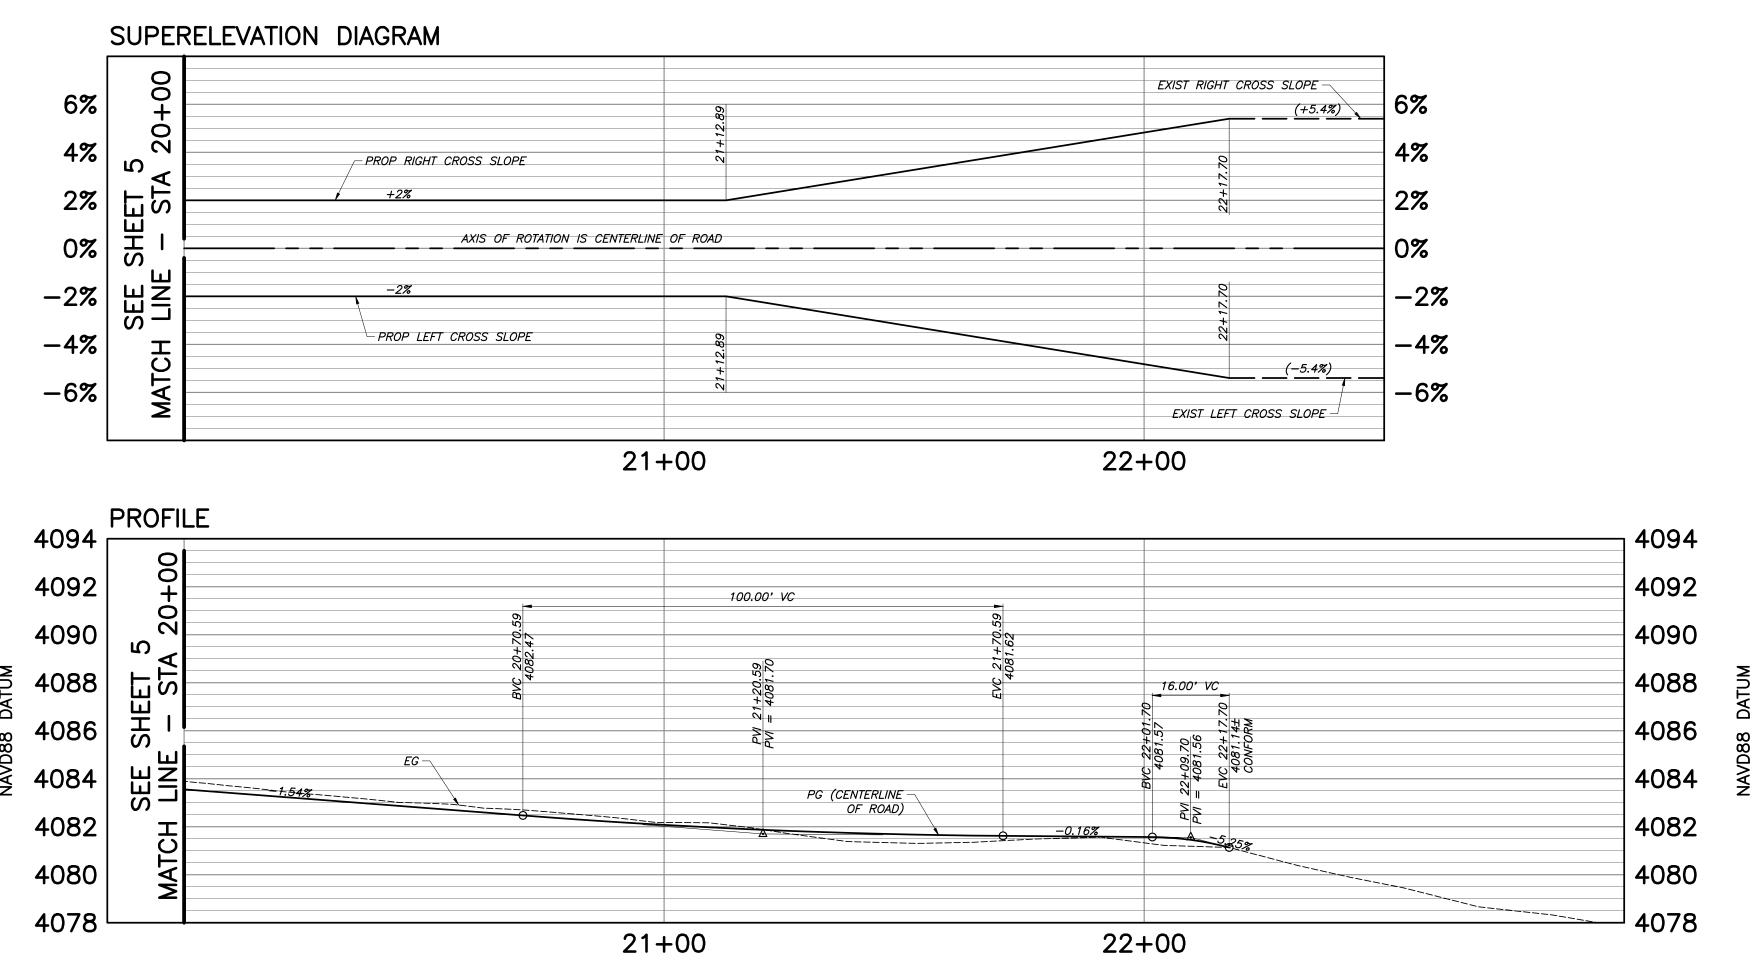

DATE SIGNED: 4/30/2021												
	DATE			SCALE			PROFESSIONAL	PROJECT	K COUN	DEF	PARTMENT OF PUBLIC WORKS	S AND PLANNING
DESIGNED: XXXX	XX/XX/20XX	RESIDENT ENGINEER	DATE					PETERSON ROAD				
DRAWN: XXXX	XX/XX/20XX			ASNOTED			992 - No. 61,604 NO EE	REPAIRS AND IMPROVEMENTS		ROA	AD PLAN AND PROFILE - STA 20	0+00 TO 22+17.69
CHECKED: XXXX	XX/XX/20XX			AS NOTED	SUPERVISING ENGINEER	DATE	CIVIL					
FOR RIGHT OF WAY DATA AND ACCURATE ACCESS DETERMINATION, SEE DOCUMENTS IN THE DEPARTMENT OF PUBLIC WORKS AND PLANNING.					OF CALIFORN	ROAD NO. BRIDGE NO.	FRES	DRAWING NO.	SHEET NO. 6	TOTAL 7		

