PLANS FOR CONSTRUCTION


ACTIVE TRANSPORTATION PROGRAM WEST PARK PEDESTRIAN PROJECT

FEDERAL PROJECT NO. ATPLSB1-5942 (301)

PROJECT LENGTH: 1.2 MILES

TO BE SUPPLEMENTED BY THE STATE STANDARD PLANS AND SPECIFICATIONS DATED 2015.

DEPARTMENT OF PUBLIC WORKS AND PLANNING

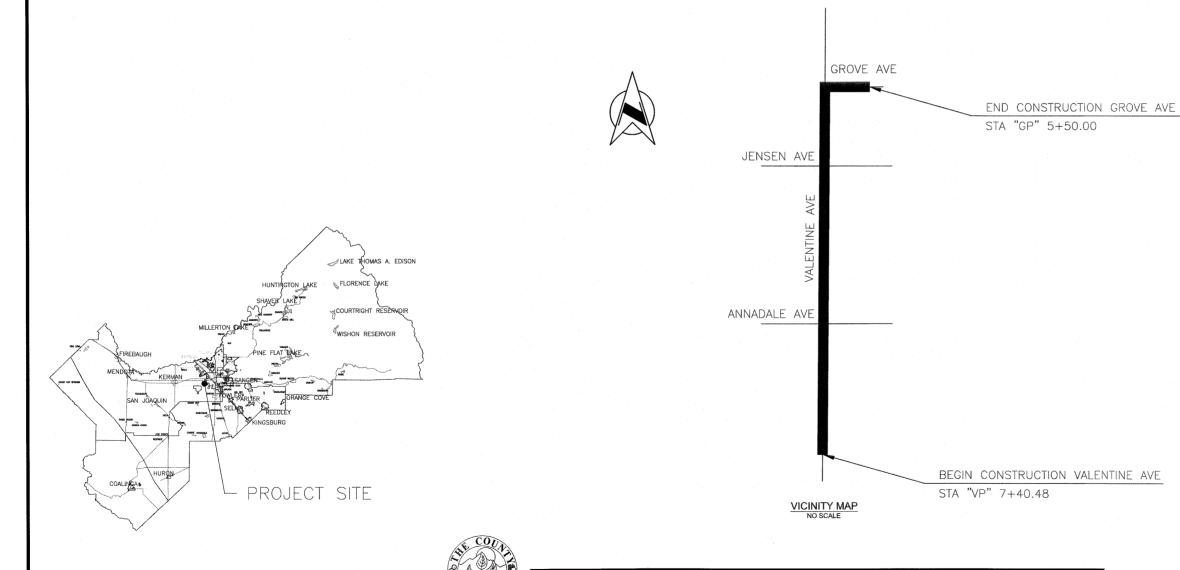

INDEX OF SHEETS

Brian Pacheco Sal Quintero Steve Brandau Ernest Buddy Mendes Nathan Magsig

Chairman Vice Chairman 1st District 3rd District 2nd District 4th District 5th District

Paul Nerland
County Administrative Officer

APPROVED


Steven E. White, Director
Department of Public Works and Planning

REVIEWED BY CASP

PPROVED David Horn. CASp-372

CALIFORNIA	CONTRACT	OR'S LICENS	ES REQUIRE	D FOR THIS	PROJECT	
CLASS A, C	GENERAL ENG	INEERING & CL	ASS C-12, EAR	THWORK AND I	PAVING	
DRAWING NO.	ROAD NO.	BRIDGE NO.	FISCAL YR.	SHEET NO.	TOTAL	
11313	x		22 / 23	T-1	35	
		CONTRACT N	O. 22-07-C			

	RECORD DRAWING		
DATE ADOPTED			
	CONTRACTOR		
NAME			
ADDRESS		, , , , , , , , , , , , , , , , , , , ,	
CITY	STATE	ZIP	
PHONE			
DATE AWARDED			
DATE STARTED			
DATE COMPLETED			
	RESIDENT ENGINEER		
NAME	SIGNATURE		
NAME	SIGNATURE		

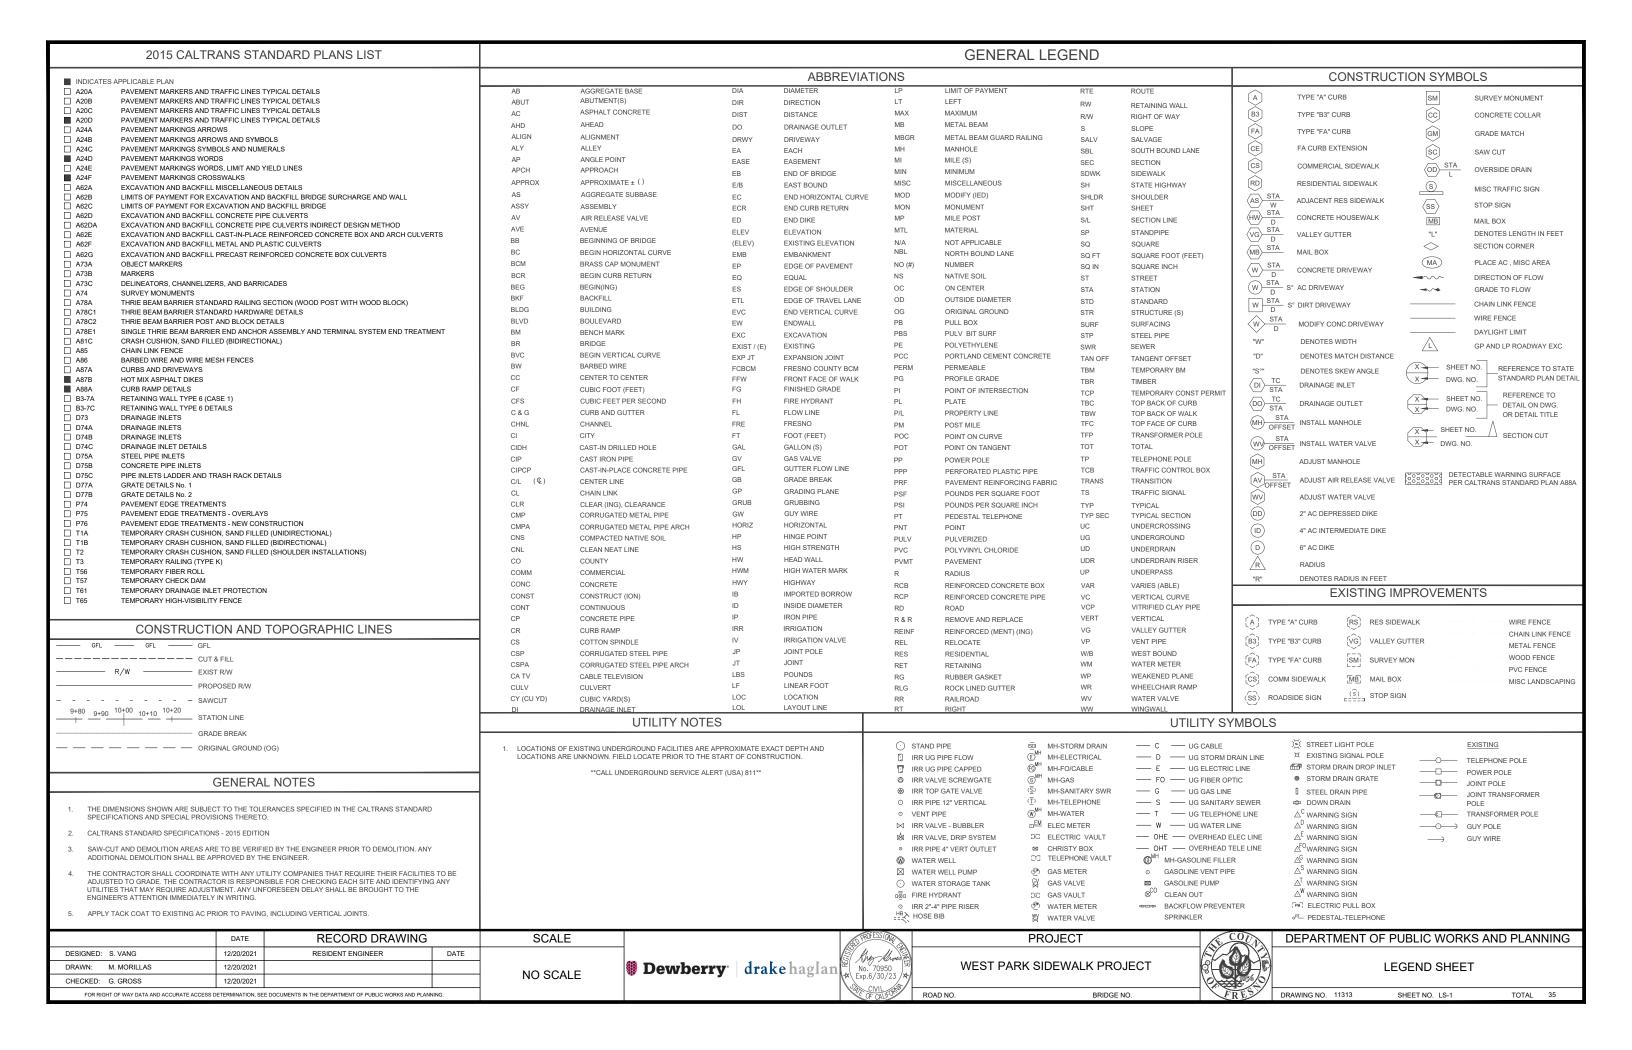

BASIS OF VERTICAL CONTROL:
CITY OF FRESNO BENCHMARK 183. A 2" BRASS CAP STAMPED 183. ON A CONCRETE CURB. ON THE WEST SIDE OF VALENTINE AVENUE, AND 600' NORTH OF NORTH AVENUE, HAS AN NGVD29 ELEVATION OF 257.73 FEET PER FRESNO CITY BENCHMARK RECORDS.

CALIFORNIA STATE PLANE COORDINATE SYSTEM:
THIS PROJECT IS IN THE CALIFORNIA COORDINATE SYSTEM OF 1983 (CC83), ZONE 4, AND IS TIED TO CENTRAL VALLEY SPATIAL REFERENCE NETWORK BASE STATION "PRS19285076630". STATION "PRS19285076630" HAS CCS83 ZONE 4 COORDINATES OF N2160518.501, E6318928.555, US SURVEY FEET AT EPOCH 2017.5 PER CALIFORNIA DEPARTMENT OF TRANSPORTATION RECORDS.

GRID TO GROUND CONVERSION:
MULTIPLY DISTANCES MEASURED IN THIS PROJECT BY A COMBINED FACTOR


OF 1.0000663 FOR GROUND DISTANCES.

	Point Table											
Point #	Raw Description	Northing	Corner	Section	Township	Range						
1419251	FD. FCBCM DN. 6"	2136174.7310	6311454.1310	N 1/4	25	14	19					
1419242	FD. FCBCM IN WELL DN. 4"	2138810.8860	6311477.2200	C 1/4	24	14	19					
1419241	FD. FCBCM IN WELL DN. 12"	2141454.5160	6311501.2000	N 1/4	24	14	19					
1419132	FD. 2" BC FLUSH IN A/C	2144095.6630	6311525.5860	C 1/4	13	14	19					



LEGEND:

SURVEY CONTROL POINT

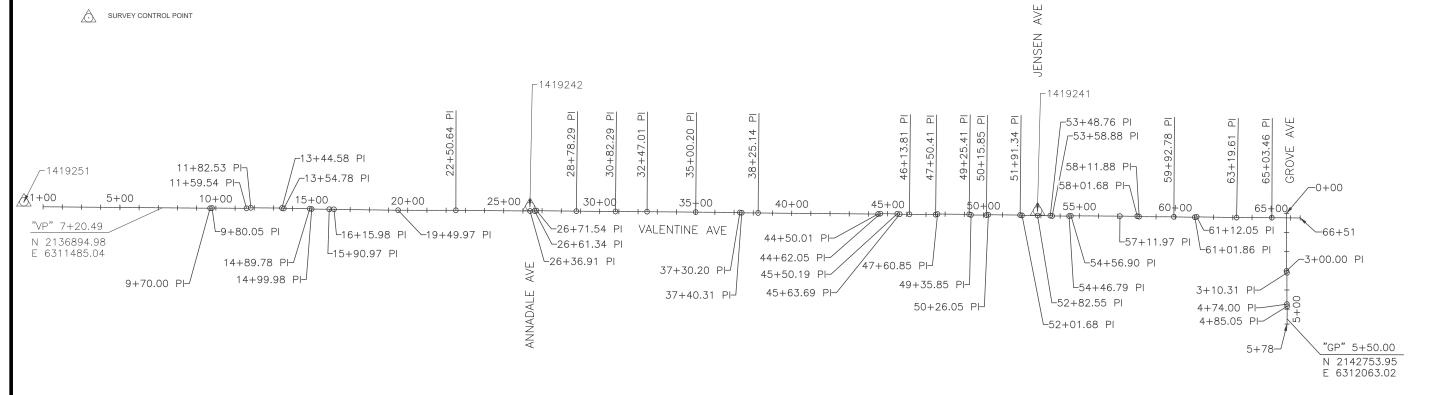

		DATE	RECORD DRAWING		
DESIGNED:	S. VANG	12/20/2021	RESIDENT ENGINEER	DATE	
DRAWN:	M. MORILLAS	12/20/2021			
CHECKED:	G. GROSS	12/20/2021			
FOR RIG	SHT OF WAY DATA AND ACCURATE ACCESS D	ETERMINATION, SE	E DOCUMENTS IN THE DEPARTMENT OF PUBLIC WORKS AND PLANN	NING.	1



SCALE

NO SCALE



ROAD NO.



PROJECT




DEPARTMENT OF PUBLIC WORKS AND PLANN	ING
PROJECT CONTROL	

SHEET NO. PC-1


DRAWING NO. 11313 BRIDGE NO.

TOTAL 35

14191327

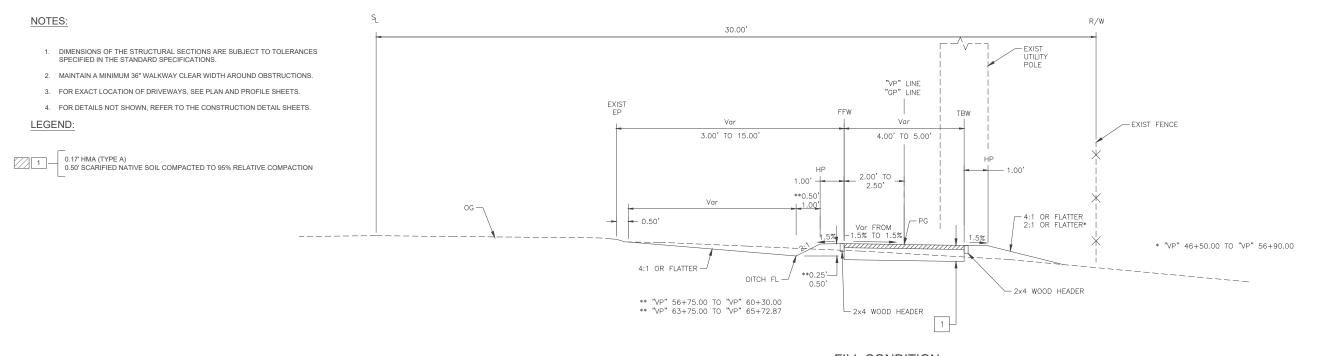

FILL CONDITION

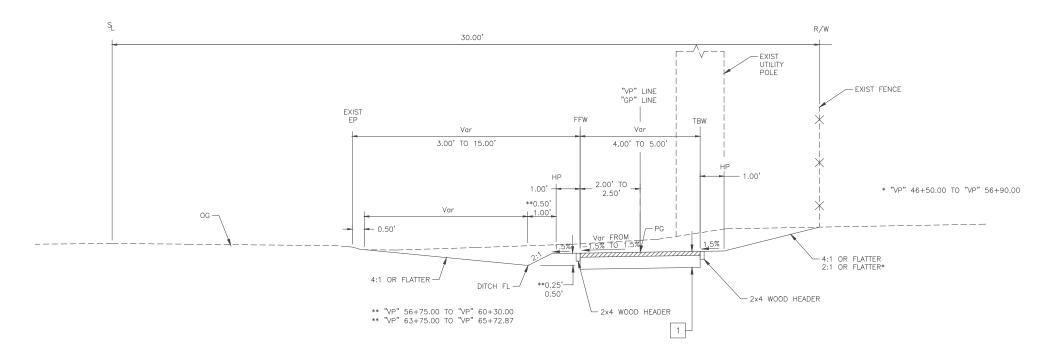



CUT CONDITION


VALENTINE PATH
"VP" 7+73.14 TO "VP" 65+79.77


GROVE PATH
"GP" 0+23.88 TO "GP" 5+50.00


	DATE	RECORD DRAWING		SCALE	FROFESSION L	PROJECT	COUN	DEPARTMENT OF PUBLIC WORKS AND PLANNING
DESIGNED: S. VANG	12/20/2021	RESIDENT ENGINEER	DATE		E Mrs Myris			
DRAWN: M. MORILLAS	12/20/2021			NO SCALE	Dewberry drake haglan No. 70950	WEST PARK SIDEWALK PROJECT		TYPICAL CROSS SECTION
CHECKED: G. GROSS	12/20/2021			NO SCALE	*\Exp.6/30/23 /*\			
FOR RIGHT OF WAY DATA AND ACCURATE ACCESS I	DETERMINATION, SE	E DOCUMENTS IN THE DEPARTMENT OF PUBLIC WORKS AND PLANN	IING.		OF CALIFORN	ROAD NO. BRIDGE NO.	FRES	DRAWING NO. 11313 SHEET NO. X-1 TOTAL 35

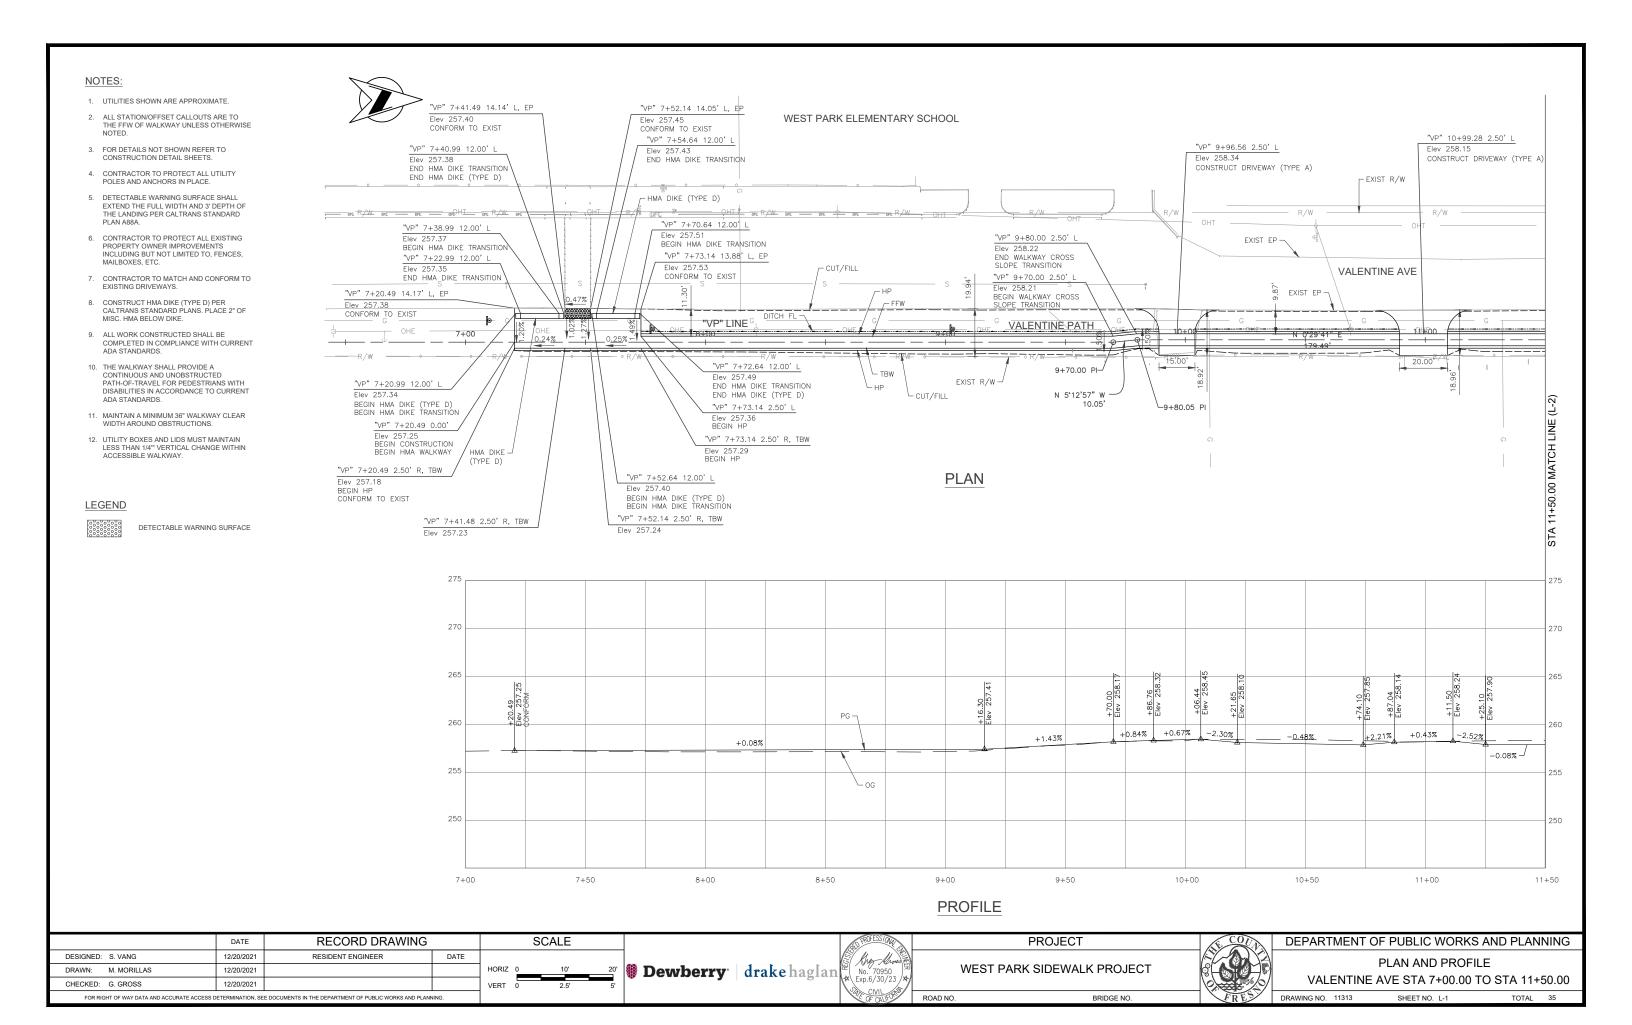


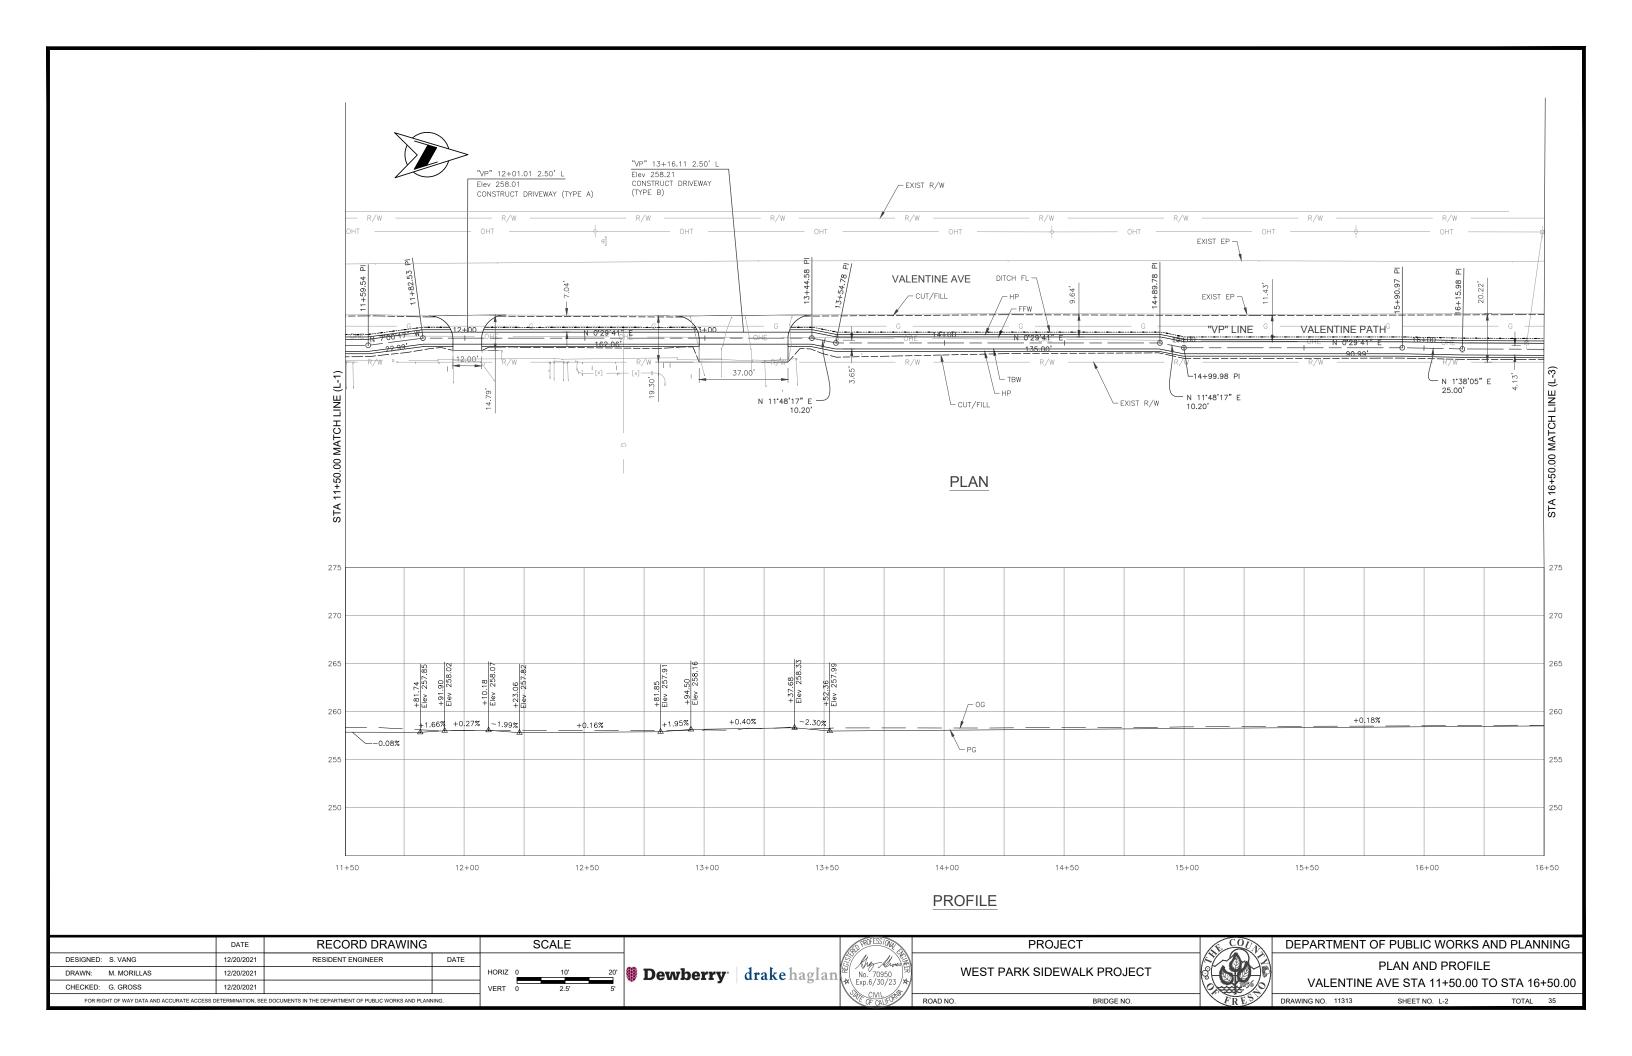


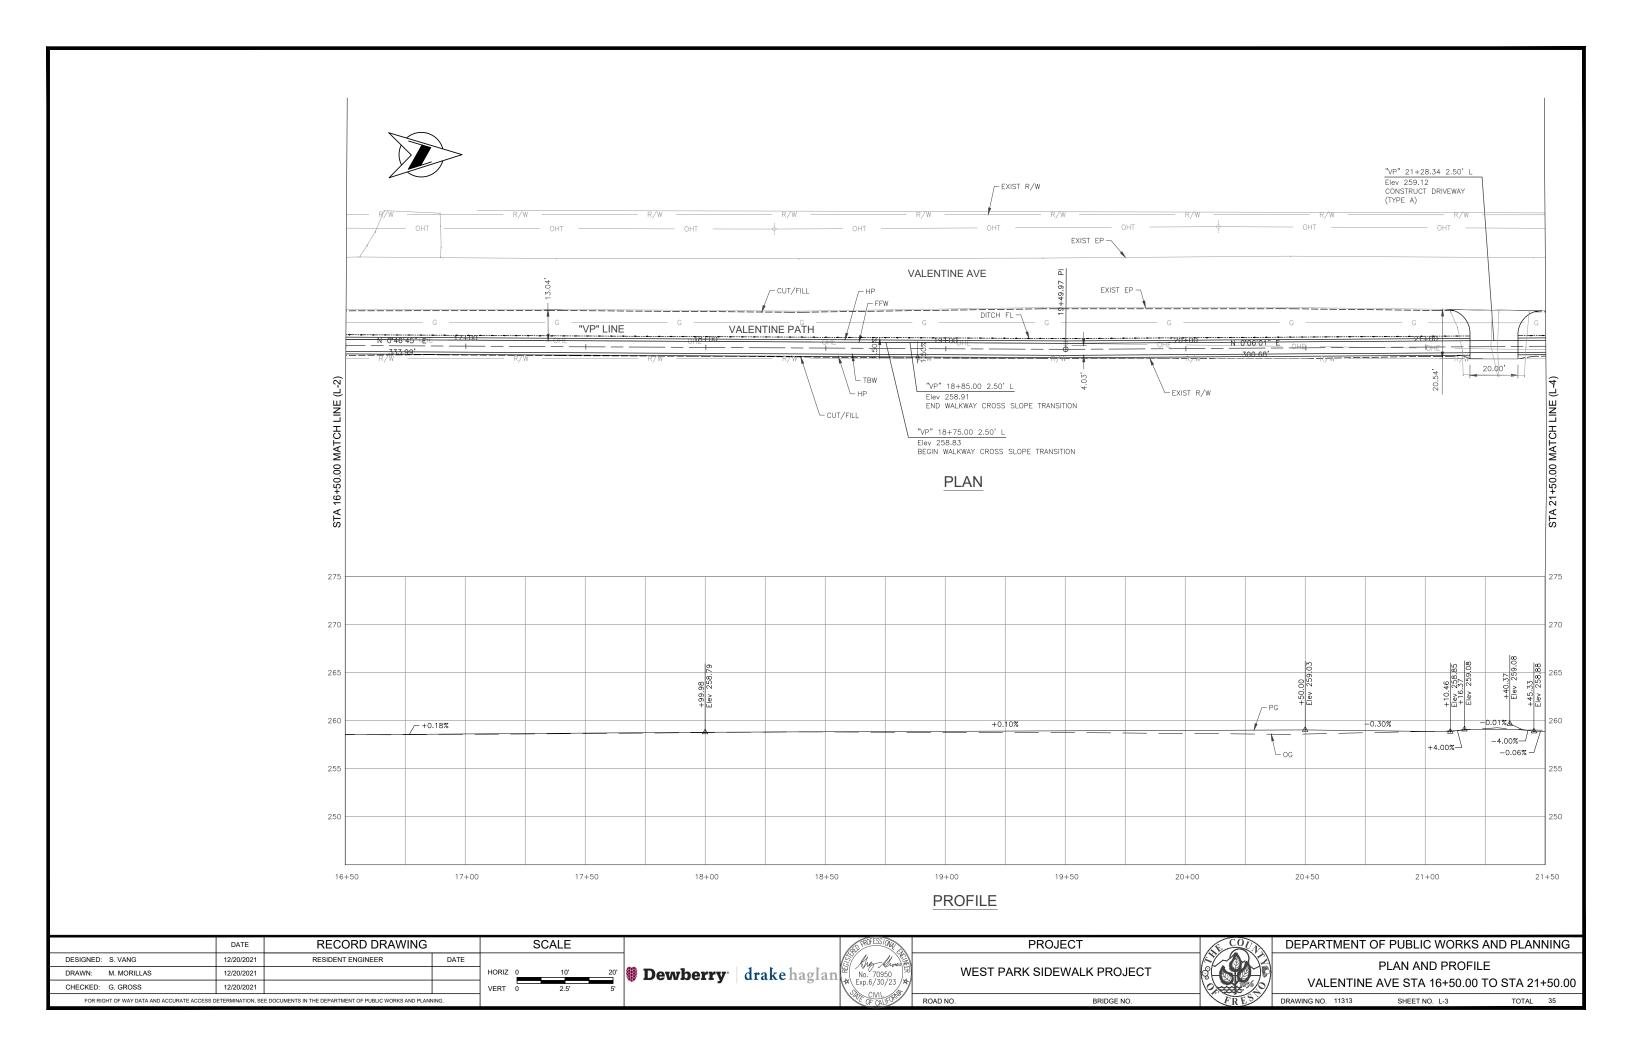


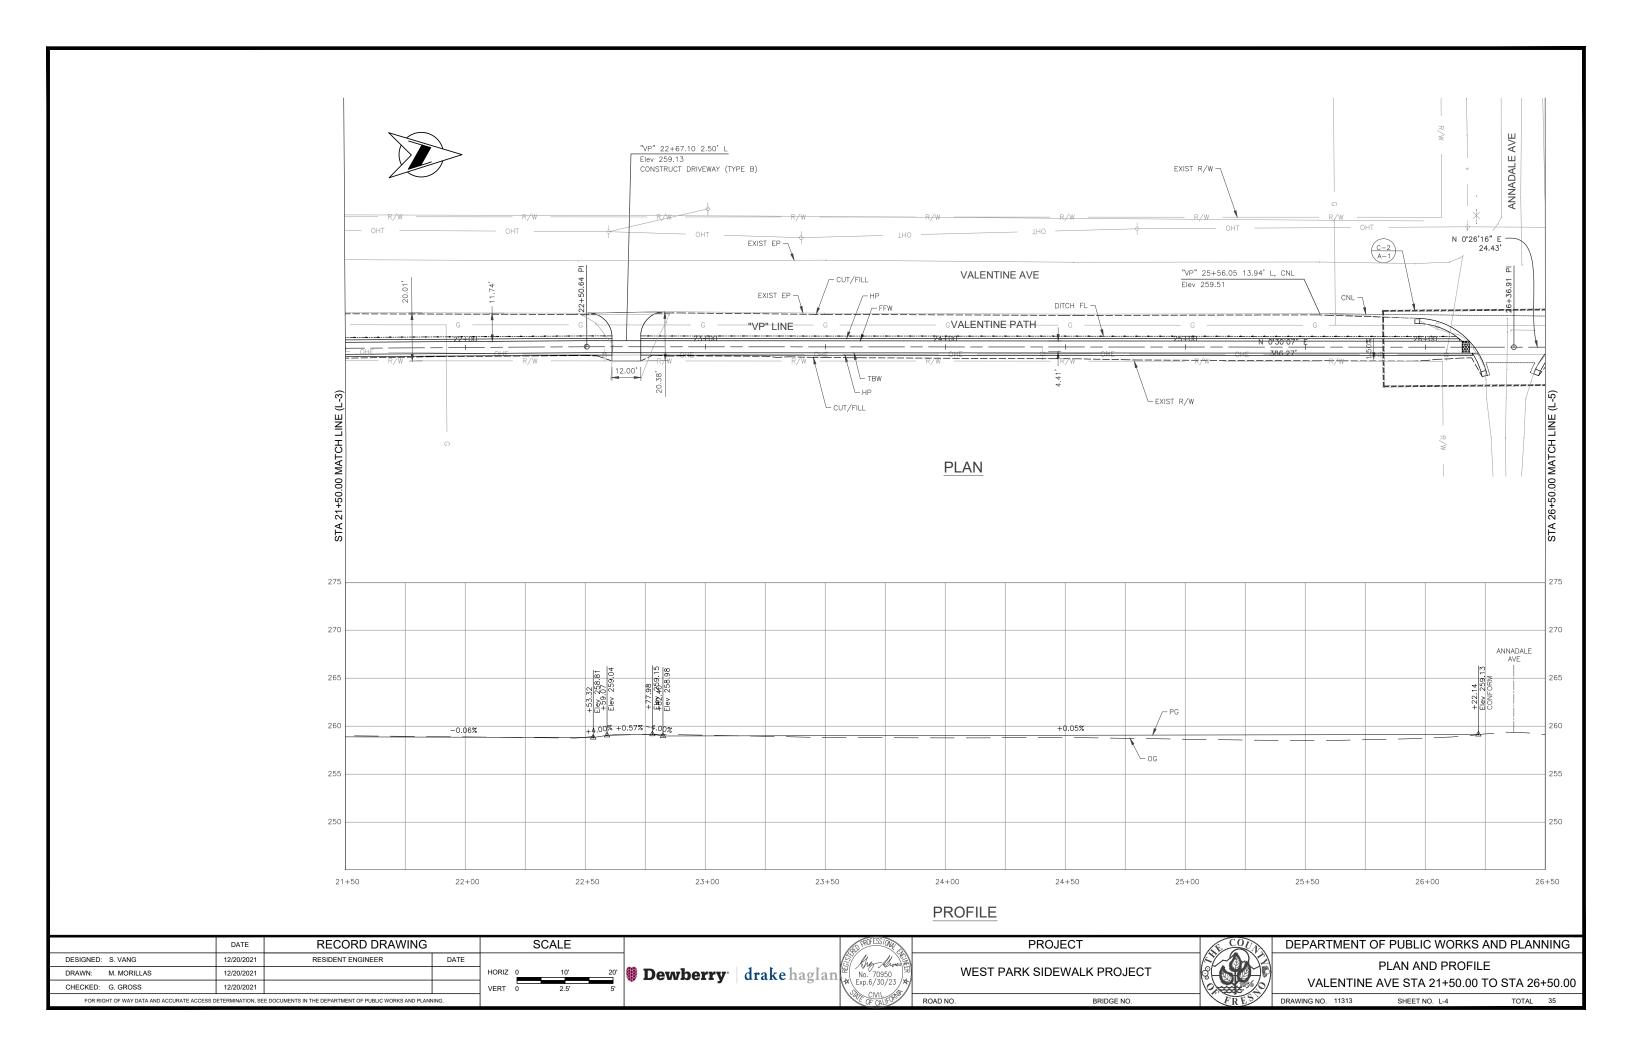


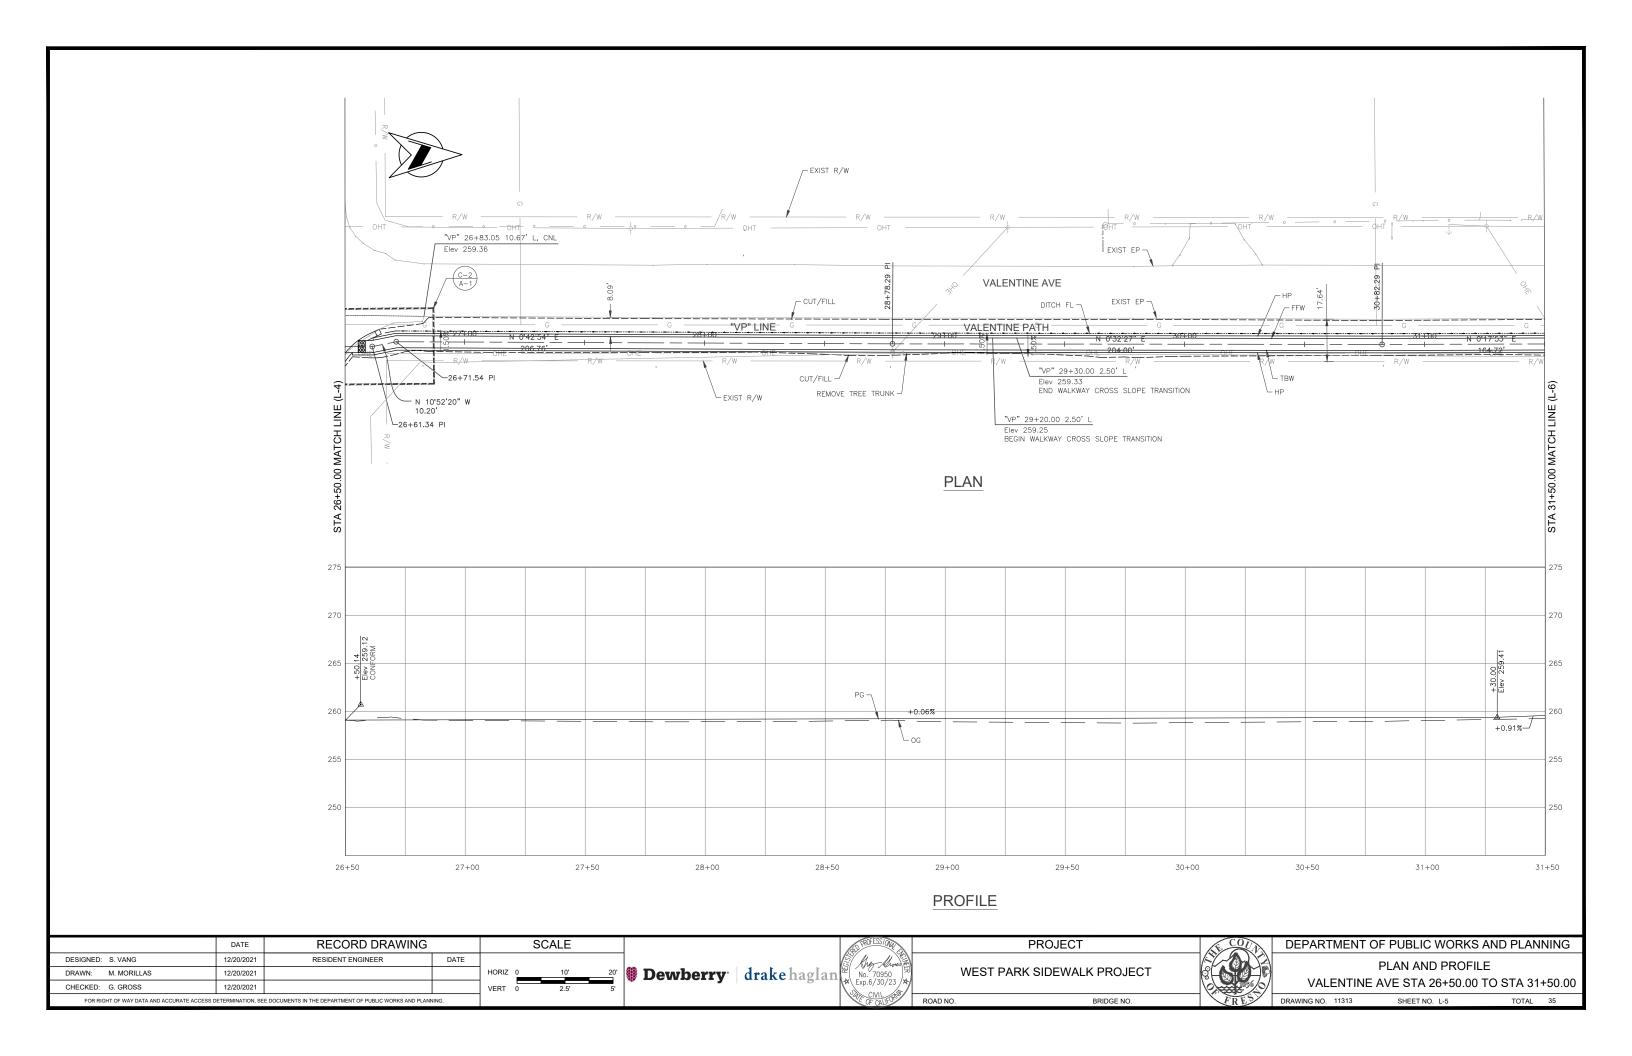


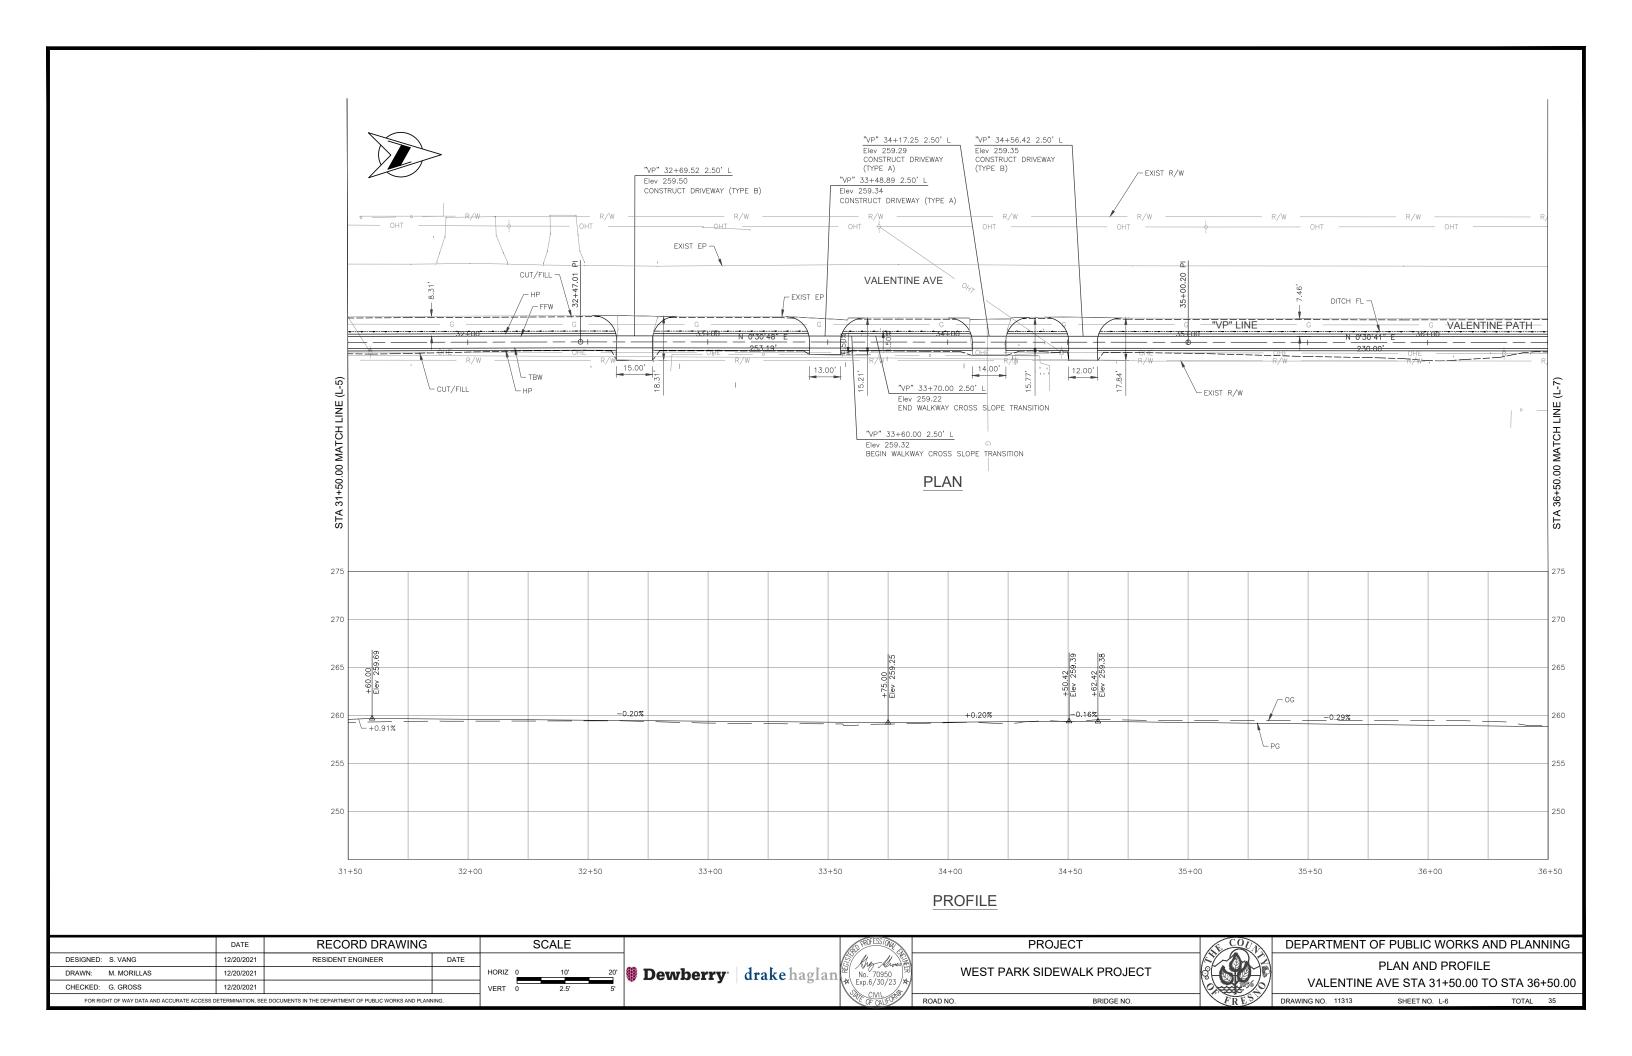


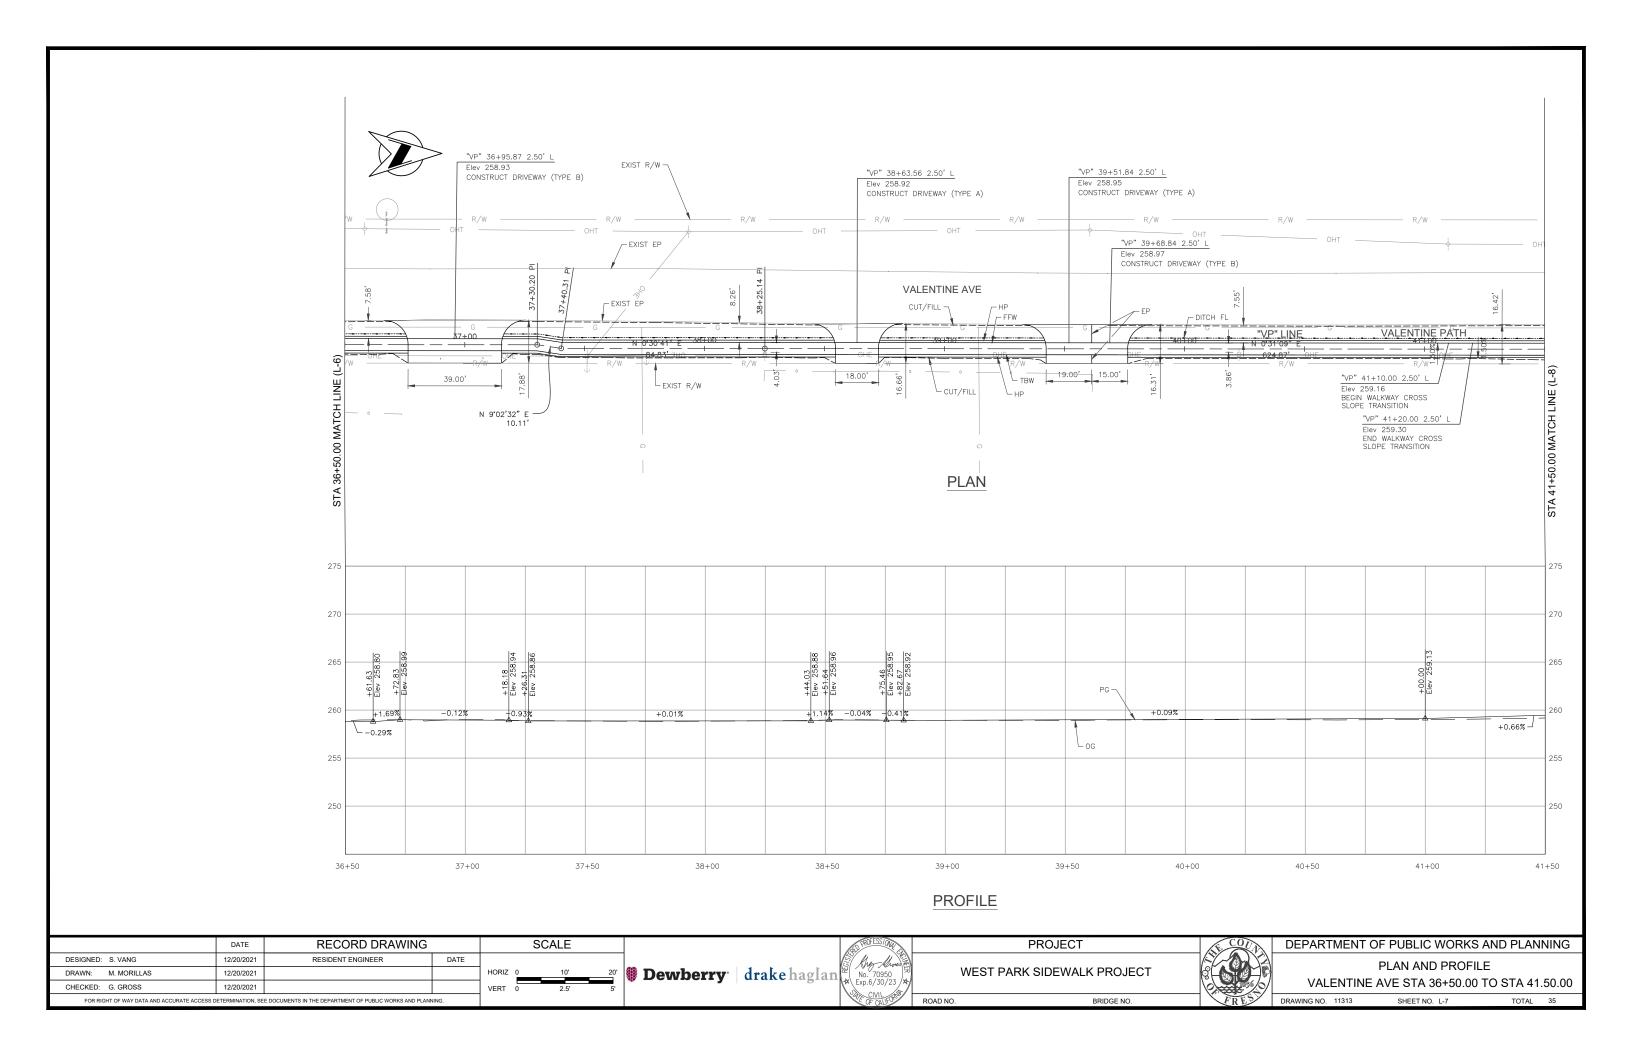


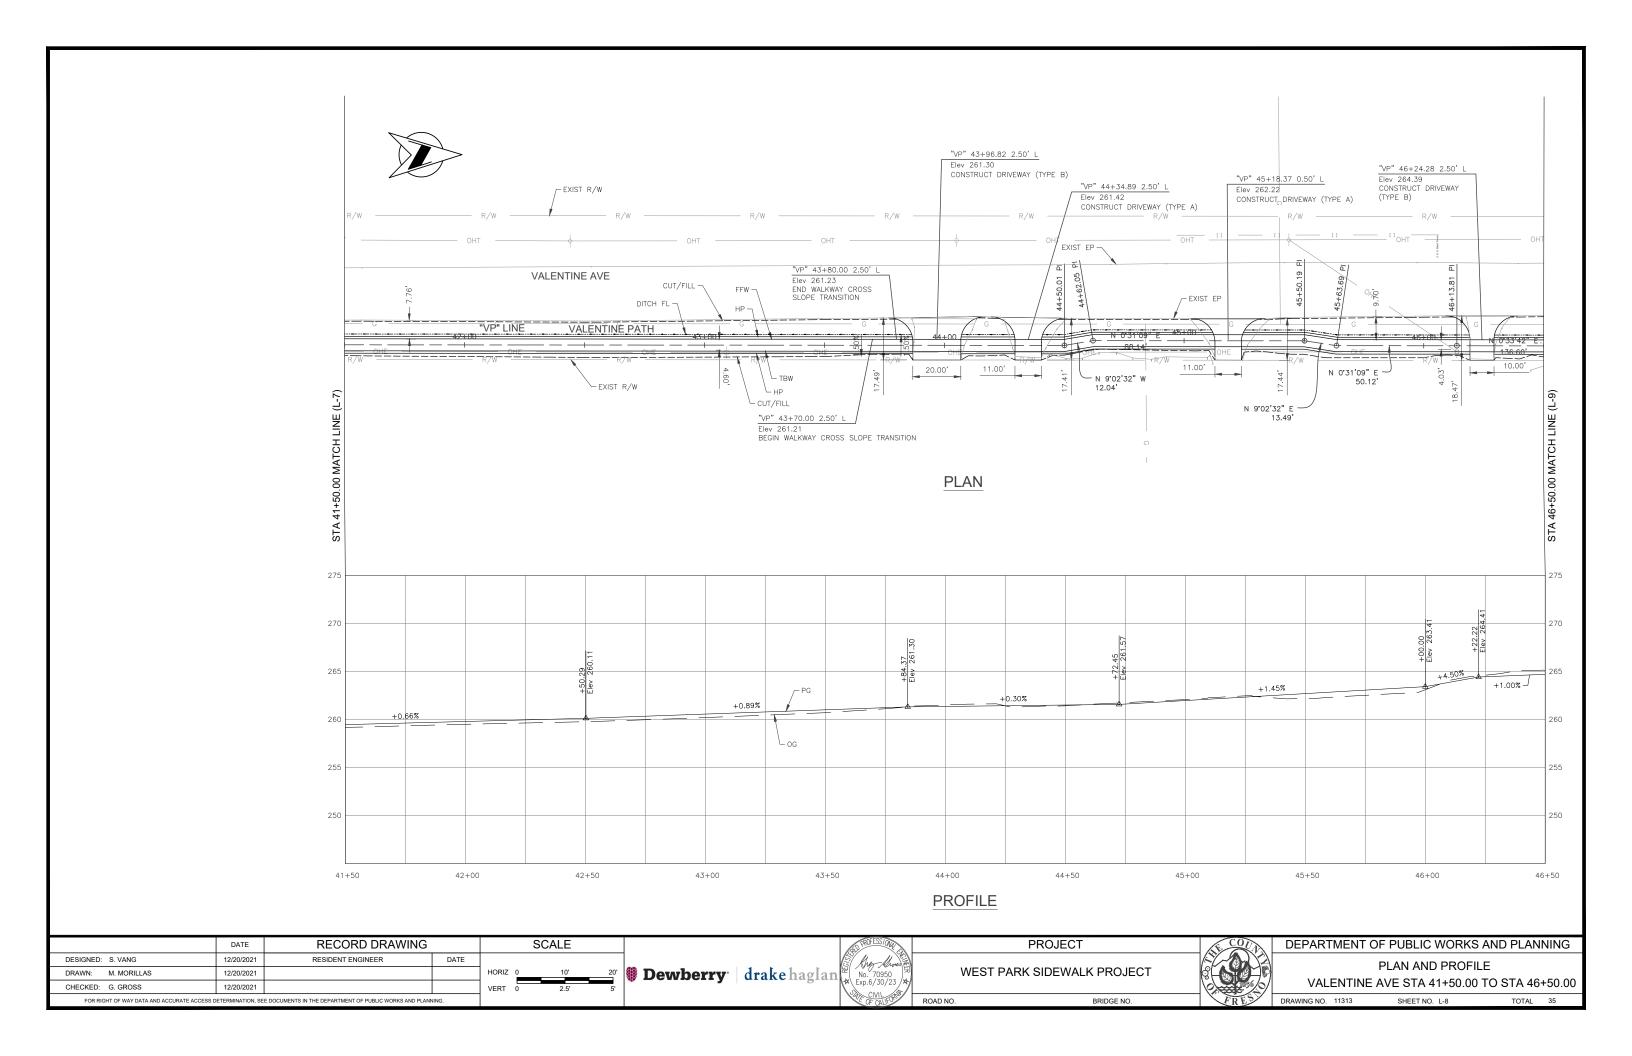


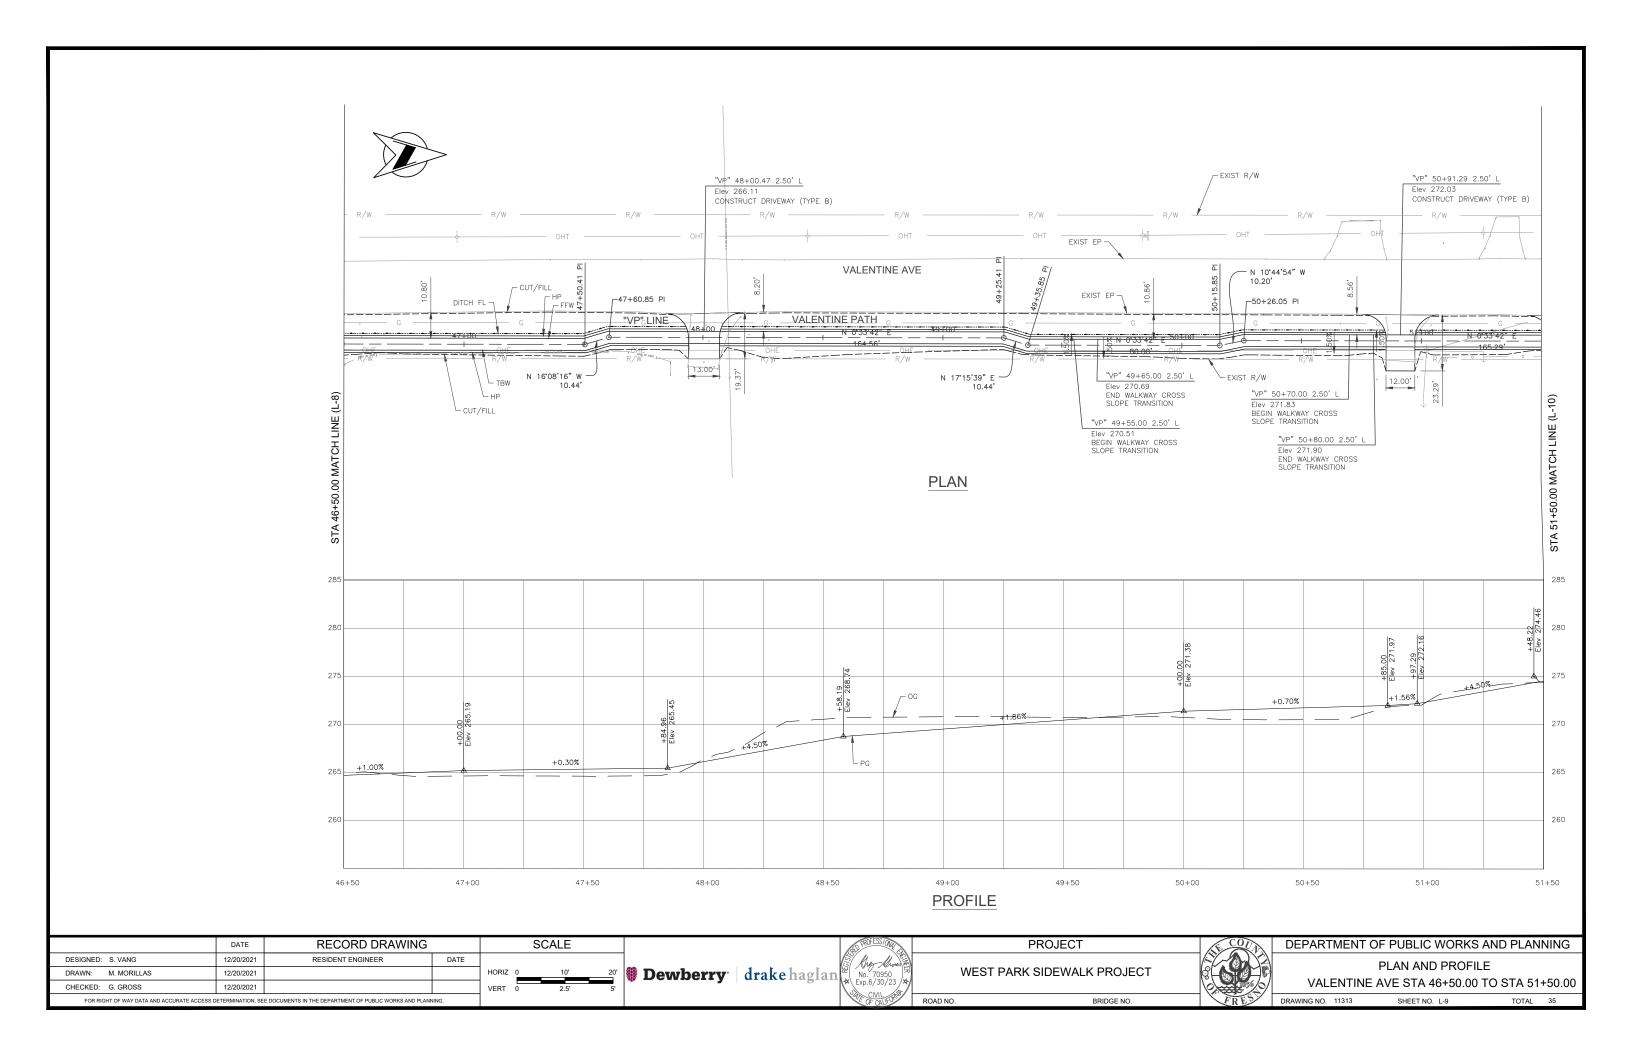

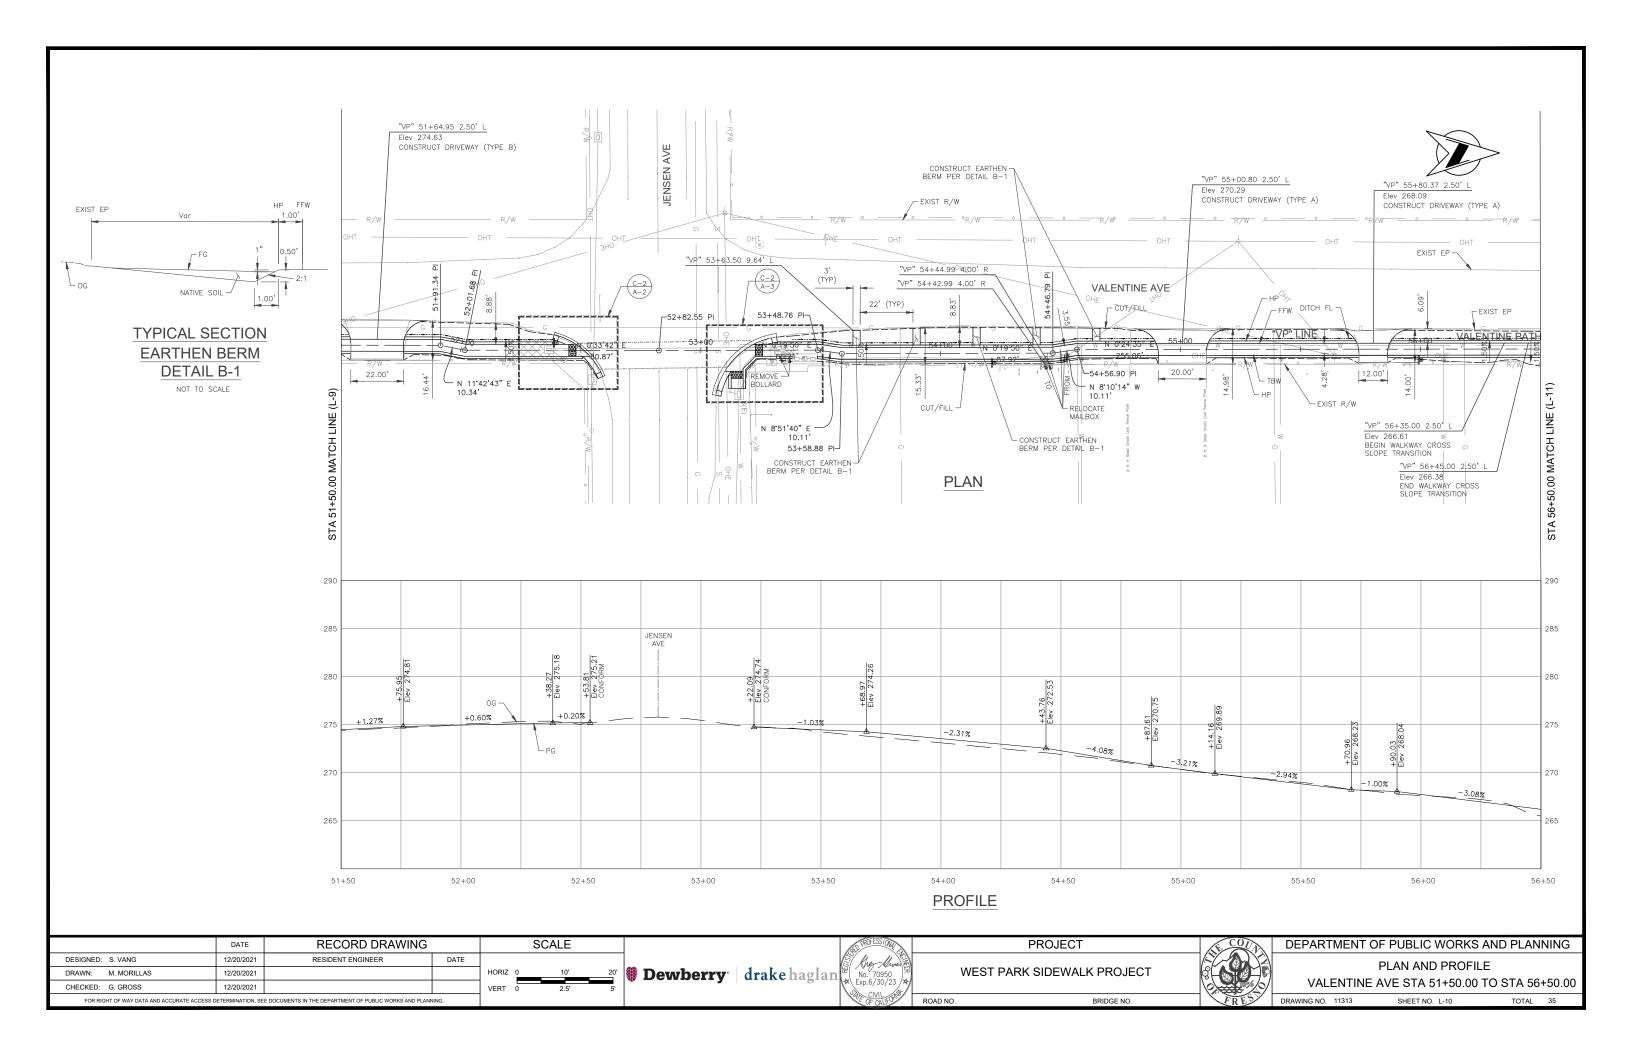

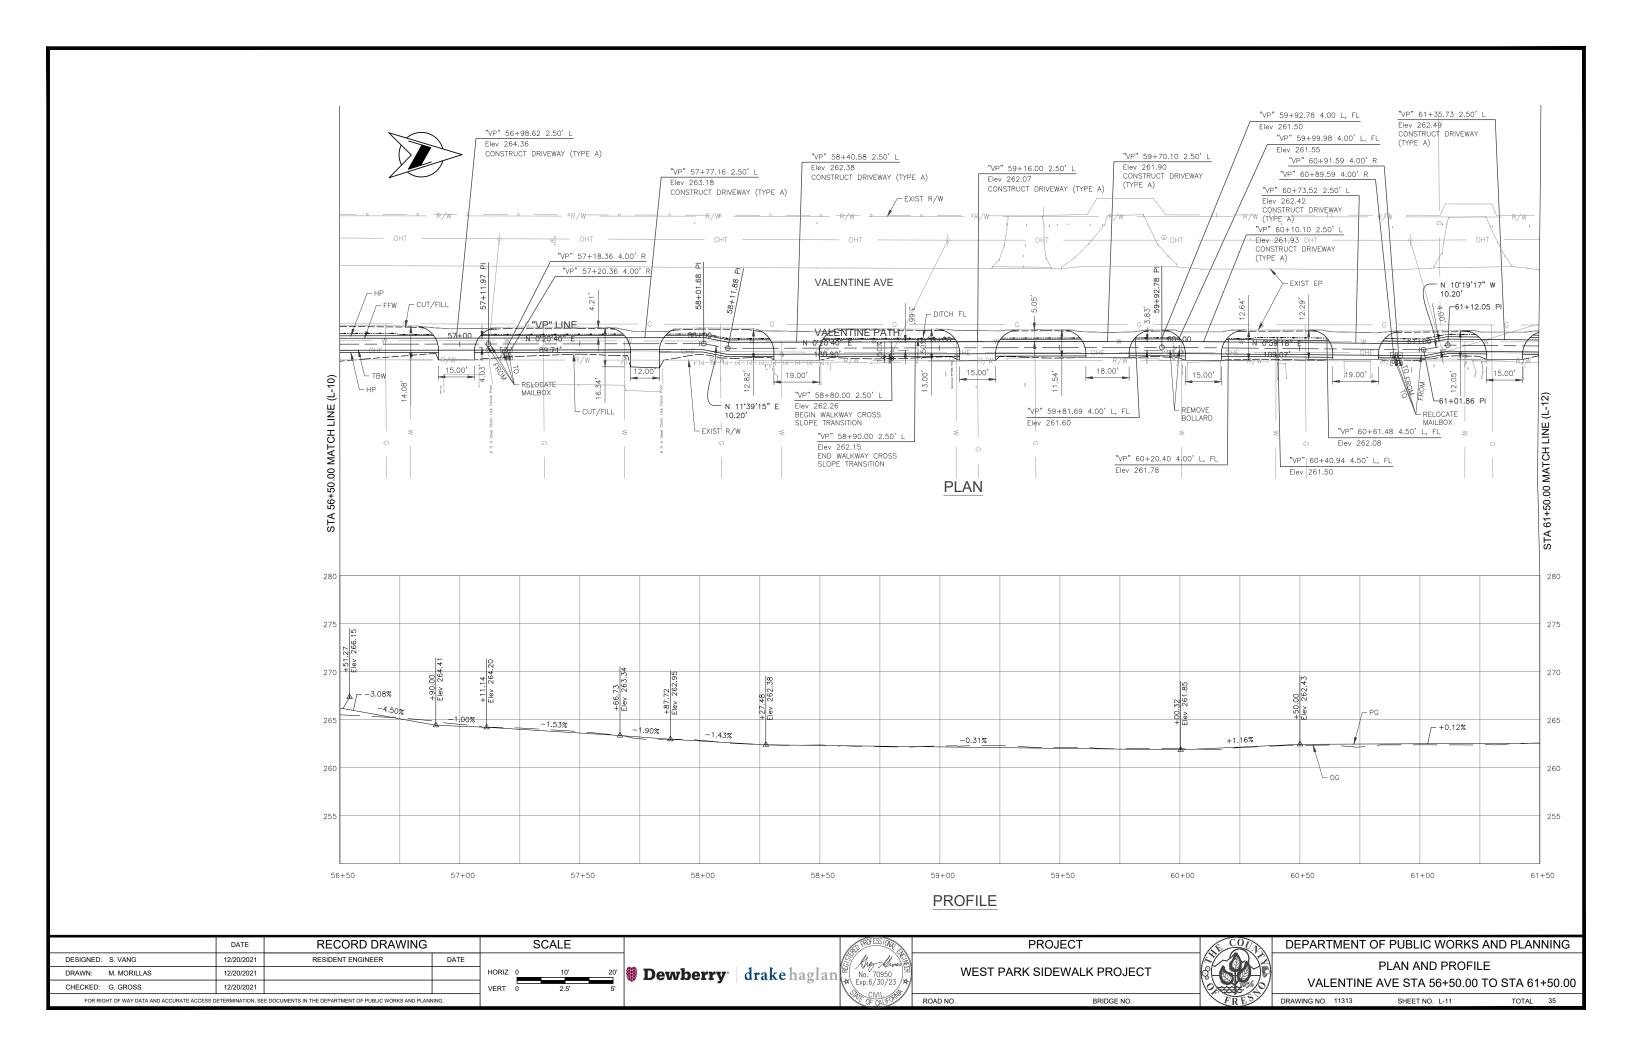


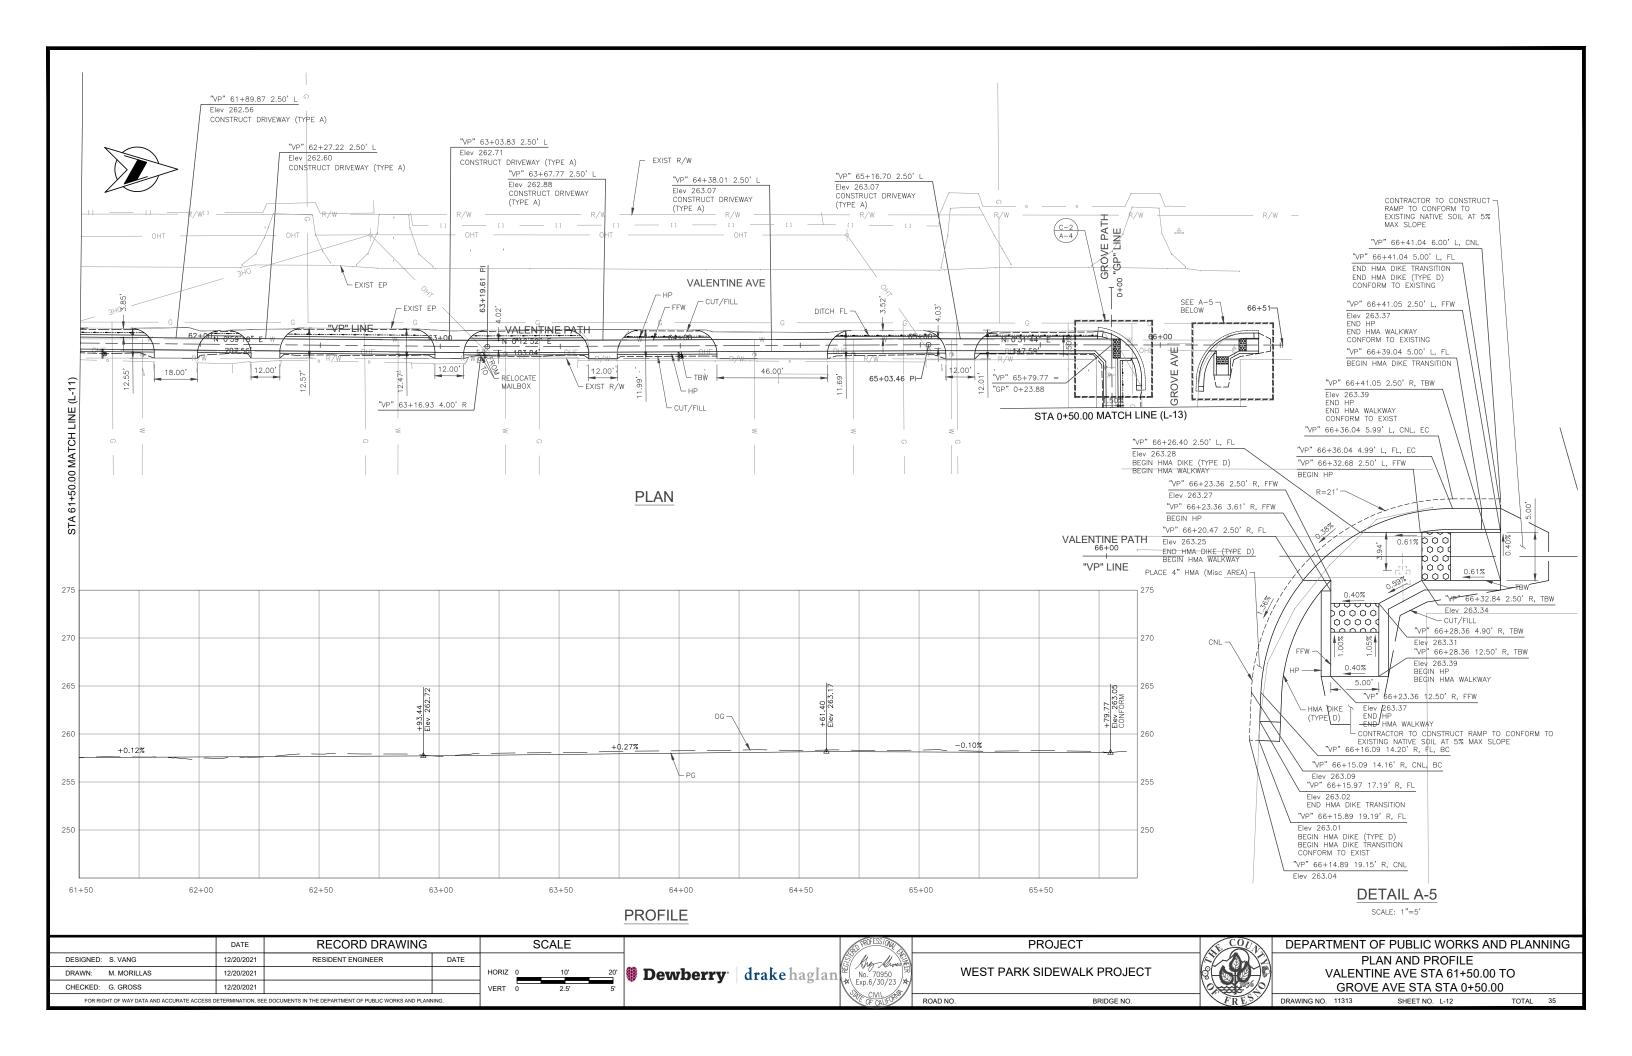


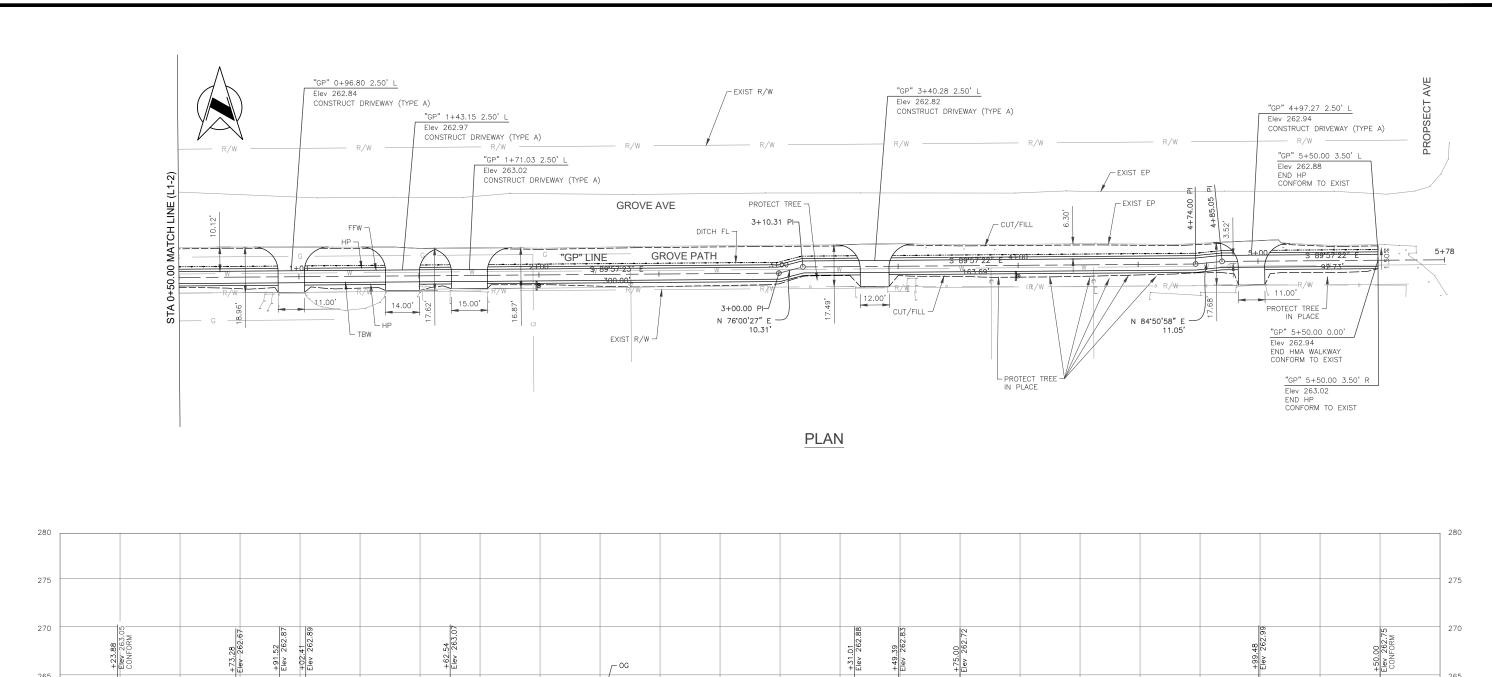



	DATE	RECORD DRAWING		S	SCALE				PROFESS/OW		PROJECT	St. COU	DEPARTMENT (OF PUBLIC WORKS	AND PLANNING
DESIGNED: S. VANG	12/20/2021	RESIDENT ENGINEER	DATE						S Krey Mrs &			1-2-10-1721		PLAN AND PROFIL	_
DRAWN: M. MORILLAS	12/20/2021		HC	RIZ 0	10'	20'	Dewberry	drake hagla	n No. 70950	l W	EST PARK SIDEWALK PROJECT		000/5 4//5		
CHECKED: G. GROSS	12/20/2021		VE	RT 0	2.5'	5'	•	8	Exp.6/30/23 / A				GROVE AVE	STA 0+50.00 TO S	TA 5+50.00
FOR RIGHT OF WAY DATA AND ACCURATE	ACCESS DETERMINATION, SEE D	OCUMENTS IN THE DEPARTMENT OF PUBLIC WORKS AND PLANNI	NG.						OF CALLEGE	ROAD NO.	BRIDGE NO.	FRES	DRAWING NO. 11313	SHEET NO. L-13	TOTAL 35

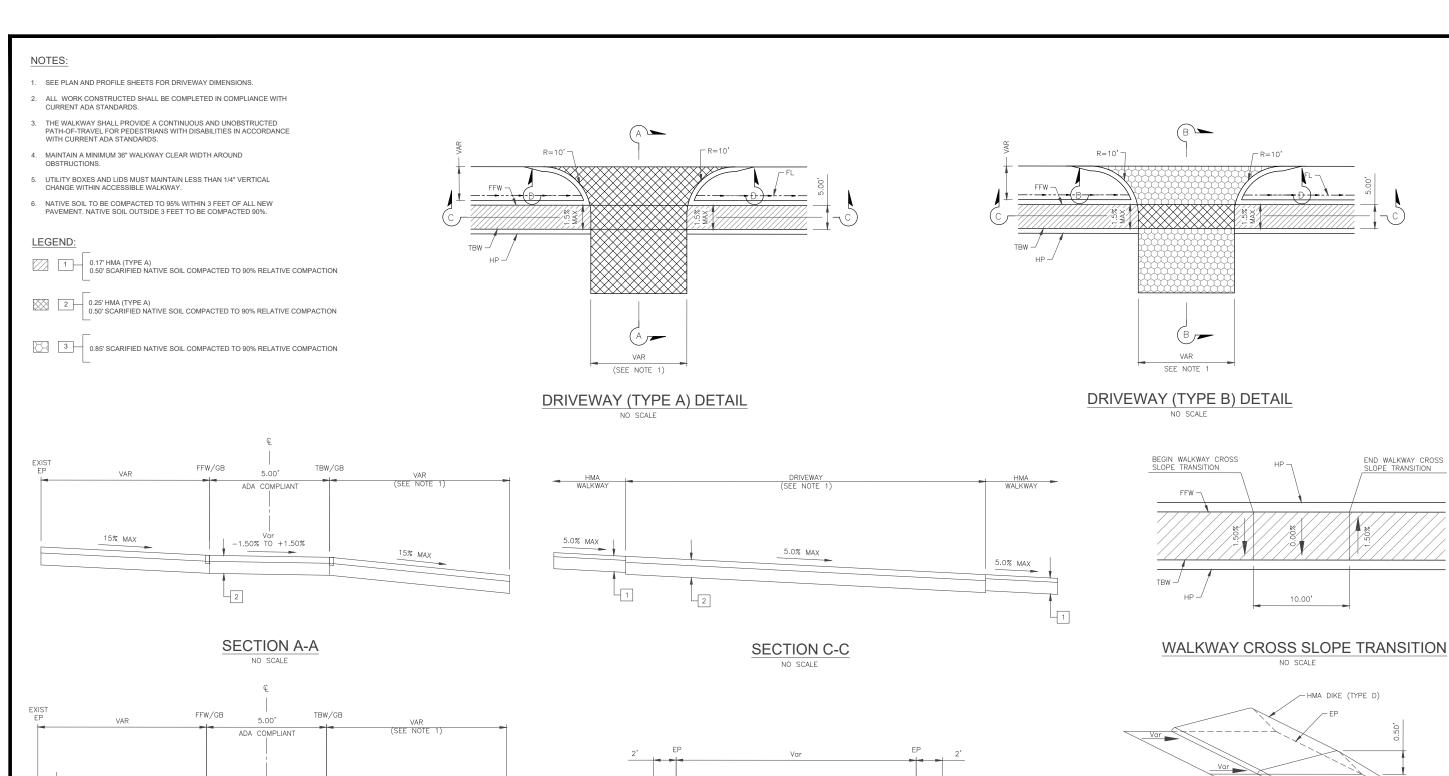

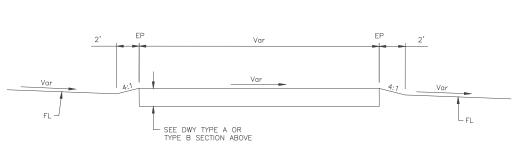

Var 2.00'

SECTION B-B NO SCALE

2

Var -1.50% TO +1.50%

15% MAX


15% MAX

3

SECTION D-D


 $\frac{\text{HMA DIKE TRANSITION}}{\text{\tiny NO SCALE}}$


	DATE	RECORD DRAWIN	RECORD DRAWING		AND PROFESSION	PROJECT	COL	DEPARTMENT OF PUBLIC WORKS	AND PLANNING
DESIGNED: S. VANG	12/20/2021	RESIDENT ENGINEER	DATE		(E) Shey-Mines				
DRAWN: M. MORILLAS	12/20/2021			NO SCALE	Dewberry drake haglan No. 70950	WEST PARK SIDEWALK PROJECT		CONSTRUCTION DET	AILS
CHECKED: G. GROSS	12/20/2021			NO SCALE	Exp.6/30/23 /x				
FOR RIGHT OF WAY DATA AND ACCURATE AC	CCESS DETERMINATION, SEE	DOCUMENTS IN THE DEPARTMENT OF PUBLIC WORKS AND	PLANNING.		OF CAUFORN	ROAD NO. BRIDGE NO.	FRES	DRAWING NO. 11313 SHEET NO. C-1	TOTAL 35

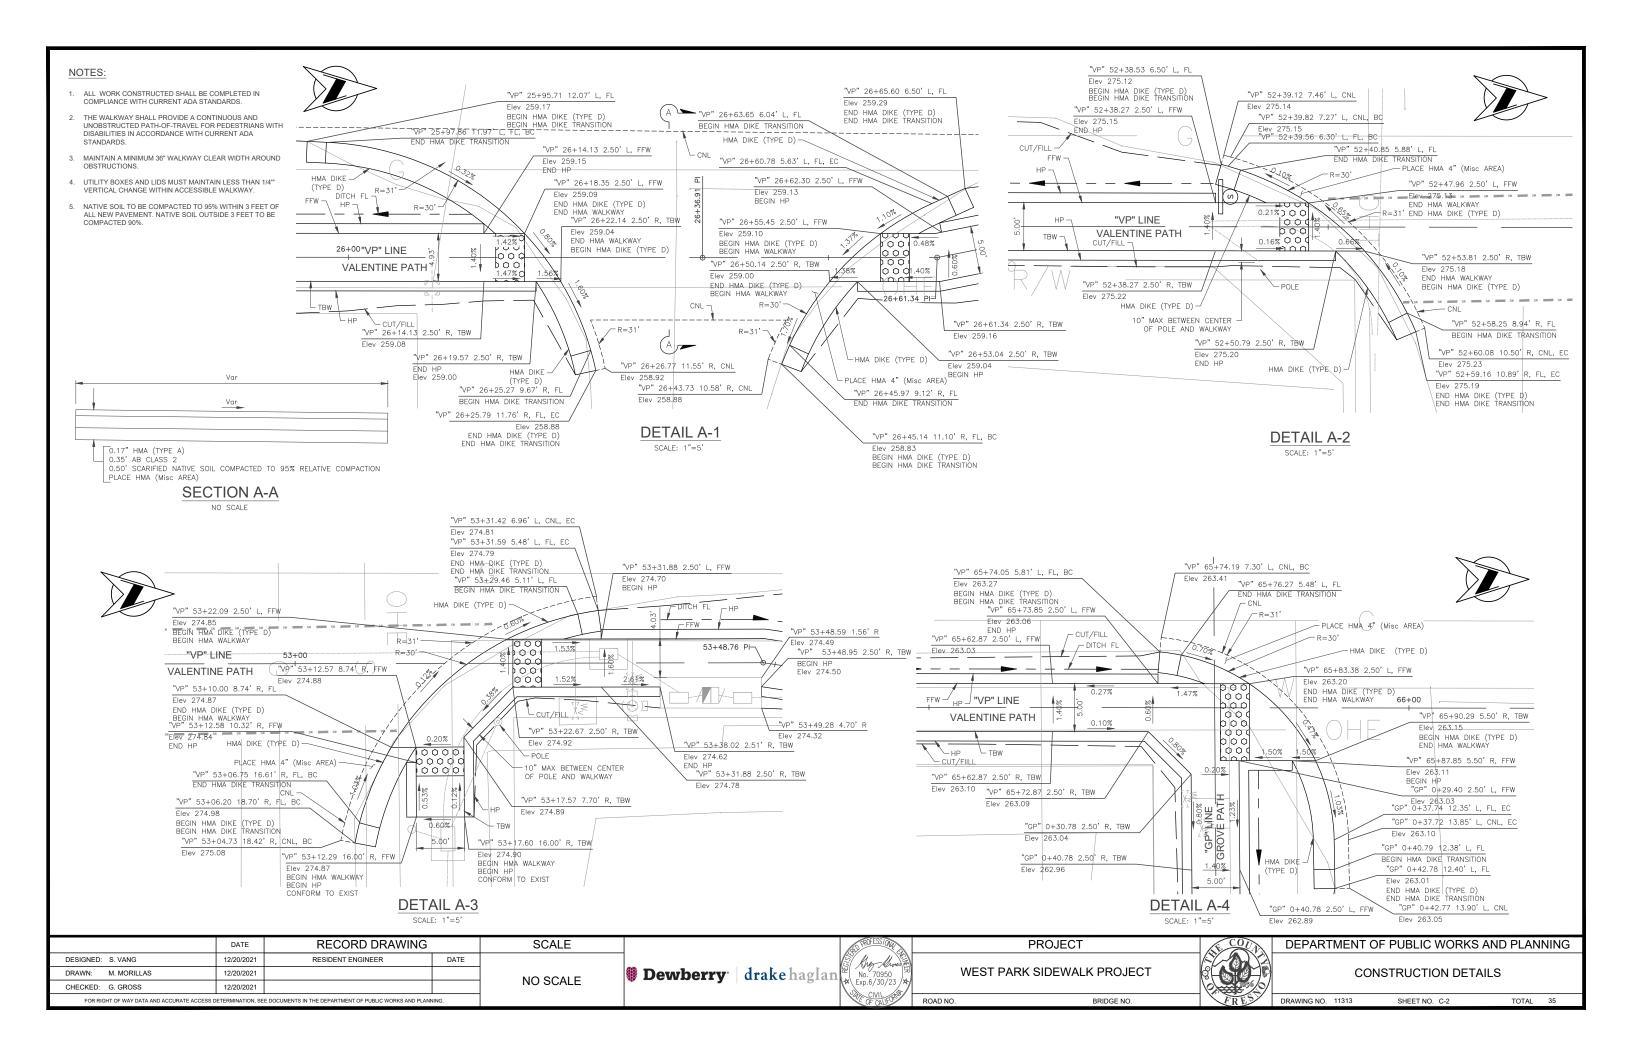

- 1. UTILITIES SHOWN ARE APPROXIMATE.
- 2. UTILITIES REPLACED AS DIRECTED BY
- UNLESS OTHERWISE SHOWN, PROTECT ALL EXISTING UTILITIES IN PLACE.

- PROTECT EXIST UTILITY IN PLACE
- 2 ADJUST UTILITY TO GRADE

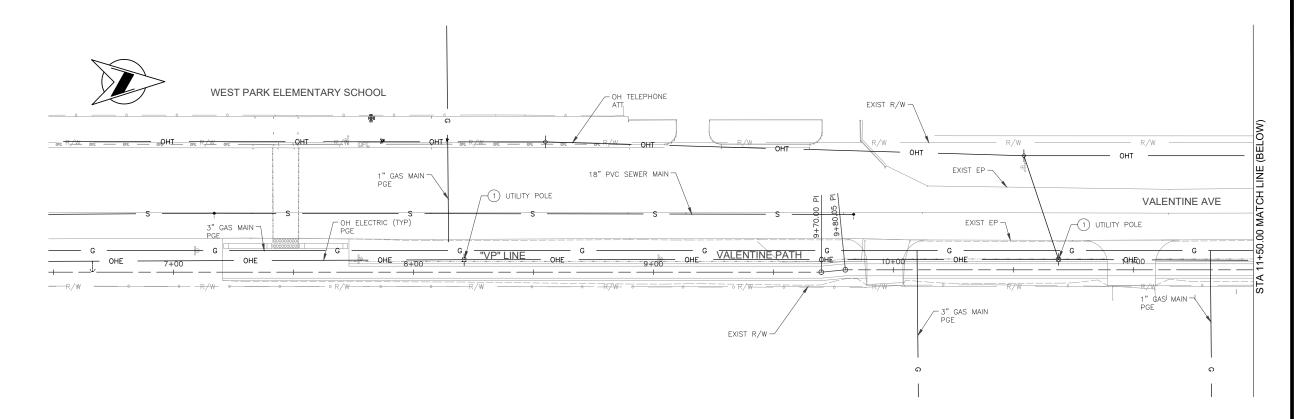

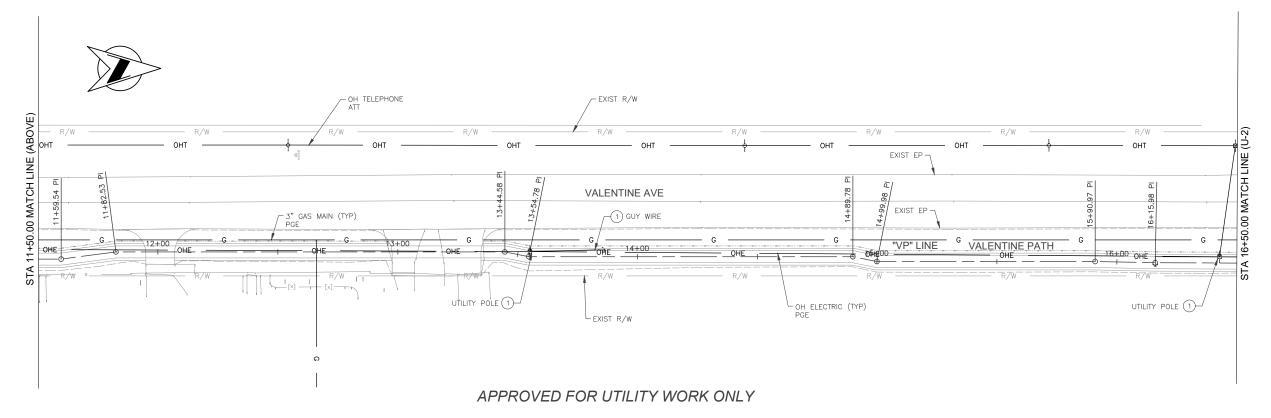

	DATE	RECORD DRAWIN	G	SCALE		PROFESSIONAL PROFESSIONAL		PROJECT	St. COU	DEPARTMENT C	F PUBLIC WORK	S AND PLANNING
DESIGNED: S. VANG	12/20/2021	RESIDENT ENGINEER	DATE			El Kher-Kharis A					UTILITY PLANS	
DRAWN: M. MORILLAS	12/20/2021			NO COALE	Dewberry	drake haglan No. 70950	WEST PAR	K SIDEWALK PROJECT			_	
CHECKED: G. GROSS	12/20/2021			NO SCALE	• = ===================================	Exp.6/30/23 /*			(July 1056/0/	VALENTINE	AVE STA 7+00.00	TO STA 16+50.00
FOR RIGHT OF WAY DATA AND ACCURATE AC	CCESS DETERMINATION, SEE DOCUI	MENTS IN THE DEPARTMENT OF PUBLIC WORKS AND I	PLANNING.			OF CAUFORN	ROAD NO.	BRIDGE NO.	FRES	DRAWING NO. 11313	SHEET NO. U-1	TOTAL 35

NOTES: 1. UTILITIES SHOWN ARE APPROXIMATE. 2. UTILITIES REPLACED AS DIRECTED BY UNLESS OTHERWISE SHOWN, PROTECT ALL EXISTING UTILITIES IN PLACE. **LEGEND** PROTECT EXIST UTILITY IN PLACE OH TELEPHONE _EXIST R/W ADJUST UTILITY TO GRADE EXIST EP VALENTINE AVE EXIST EP 3" GAS MAIN (TYP) VALENTINE PATH "VP" LINE UTILITY POLE 1 OH ELECTRIC (TYP) PGE EXIST R/W OH TELEPHONE (ABOVE) EXIST EP STA 21+50.00 MATCH LINE VALENTINE AVE EXIST EP -3" GAS MAIN (TYP) VALENTINE PATH 23+00 22+00 24+00 25+00 - OHE UTILITY POLE (1)-UTILITY POLE (1) UTILITY POLE 1--EXIST R/W OH ELECTRIC (TYP) PGE GUY WIRE 1)-APPROVED FOR UTILITY WORK ONLY DATE RECORD DRAWING SCALE **PROJECT** DEPARTMENT OF PUBLIC WORKS AND PLANNING 12/20/2021 RESIDENT ENGINEER DATE DESIGNED: S. VANG UTILITY PLANS WEST PARK SIDEWALK PROJECT **Dewberry** drake haglan DRAWN: M. MORILLAS 12/20/2021 NO SCALE VALENTINE AVE STA 16+50.00 TO STA 26+50.00

ROAD NO.

BRIDGE NO.

CHECKED: G. GROSS

12/20/2021

FOR RIGHT OF WAY DATA AND ACCURATE ACCESS DETERMINATION, SEE DOCUMENTS IN THE DEPARTMENT OF PUBLIC WORKS AND PLANNING

MATCH LINE (BELOW)

00 MATCH LINE (U-3)


TOTAL 35


DRAWING NO. 11313

SHEET NO. U-2

- 1. UTILITIES SHOWN ARE APPROXIMATE.
- 2. UTILITIES REPLACED AS DIRECTED BY
- UNLESS OTHERWISE SHOWN, PROTECT ALL EXISTING UTILITIES IN PLACE.

- PROTECT EXIST UTILITY IN PLACE
- 2) ADJUST UTILITY TO GRADE

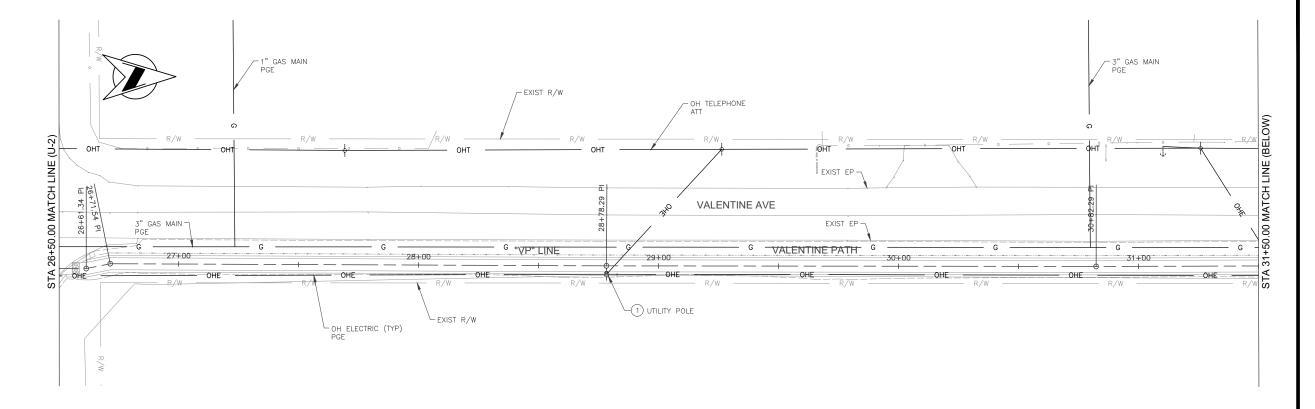


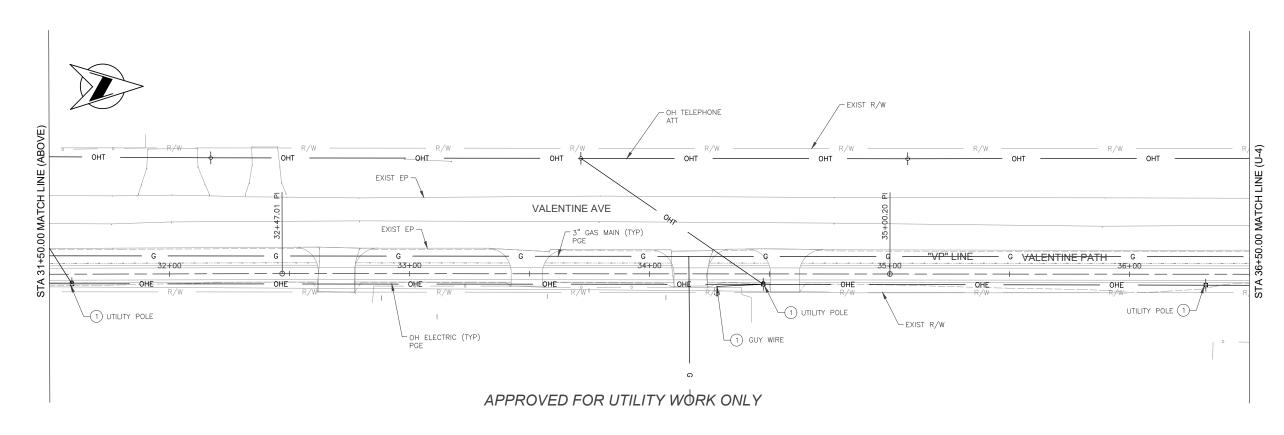


	DATE	RECORD DRAWING		SCALE	PROJECT		COUN	DEPARTMENT OF	PUBLIC WORKS A	ND PLANNING
DESIGNED: S. VANG	12/20/2021	RESIDENT ENGINEER	DATE		El Sher-University				UTILITY PLANS	
DRAWN: M. MORILLAS	12/20/2021			NO SCALE	Dewberry drake haglan No. 70950	WEST PARK SIDEWALK PROJECT				0.074.00.50.00
CHECKED: G. GROSS	12/20/2021			NO SCALE	Exp.6/30/23 / Ar			VALENTINE A	VE STA 26+50.00 To	O STA 36+50.00
FOR RIGHT OF WAY DATA AND ACCURATE ACCESS D	DETERMINATION, SEE	DOCUMENTS IN THE DEPARTMENT OF PUBLIC WORKS AND PLAN	IING.		OF CALFORN	ROAD NO. BRIDGE NO.	FRES	DRAWING NO. 11313	SHEET NO. U-3	TOTAL 35

- 1. UTILITIES SHOWN ARE APPROXIMATE.
- 2. UTILITIES REPLACED AS DIRECTED BY
- 3. UNLESS OTHERWISE SHOWN, PROTECT ALL EXISTING UTILITIES IN PLACE.

- PROTECT EXIST UTILITY IN PLACE
- 2) ADJUST UTILITY TO GRADE

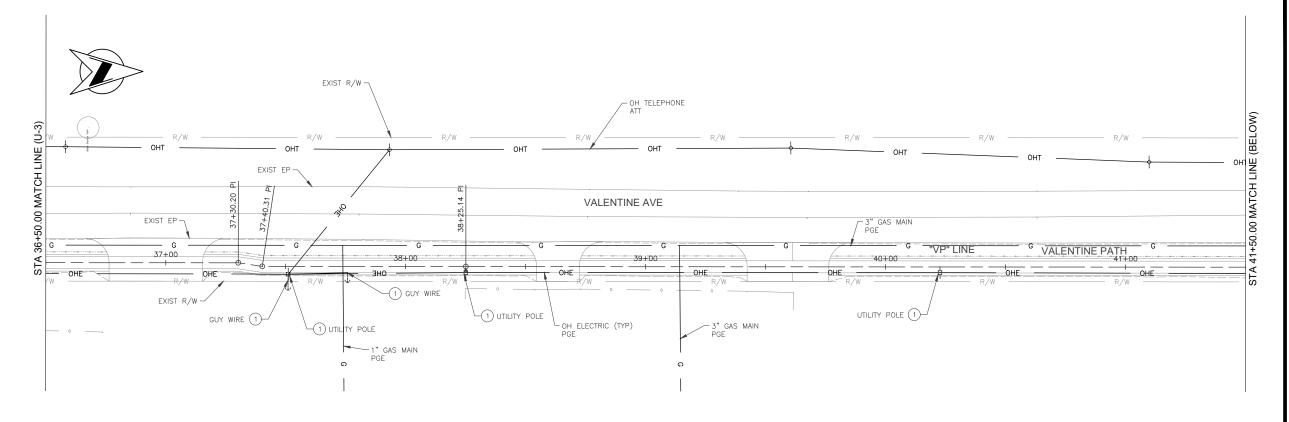

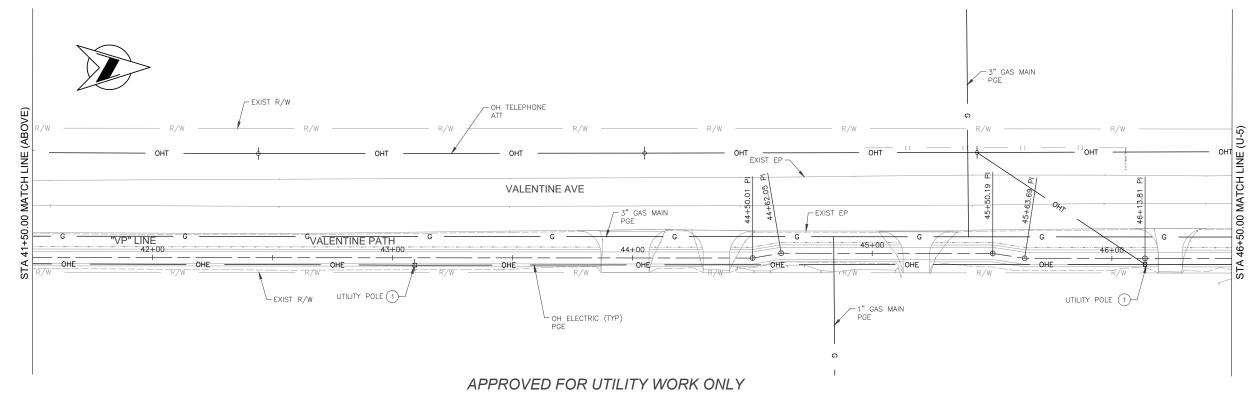



	DATE	RECORD DRAWIN	1G	SCALE		PROFESS/OWN	F	PROJECT	COUN	DEPARTMENT O	F PUBLIC WORKS	S AND PLANNING
DESIGNED: S. VANG	12/20/2021	RESIDENT ENGINEER	DATE			S Kher Shres					UTILITY PLANS	
DRAWN: M. MORILLAS	12/20/2021			NO SCALE	Dewberry	drake haglan No. 70950	WEST PARK	SIDEWALK PROJECT			•	TO OTA 40 50 00
CHECKED: G. GROSS	12/20/2021			NO SCALE	,	Exp.6/30/23 / A				VALENTINE /	AVE STA 36+50.00	TO STA 46.50.00
FOR RIGHT OF WAY DATA AND ACCURATE	ACCESS DETERMINATION, SEE DOC	UMENTS IN THE DEPARTMENT OF PUBLIC WORKS AND	PLANNING.			OF CAULOS	ROAD NO.	BRIDGE NO.	FRES	DRAWING NO. 11313	SHEET NO. U-4	TOTAL 35
										'		

- 1. UTILITIES SHOWN ARE APPROXIMATE.
- 2. UTILITIES REPLACED AS DIRECTED BY
- UNLESS OTHERWISE SHOWN, PROTECT ALL EXISTING UTILITIES IN PLACE.

LEGEND

- PROTECT EXIST UTILITY IN PLACE
- 2) ADJUST UTILITY TO GRADE

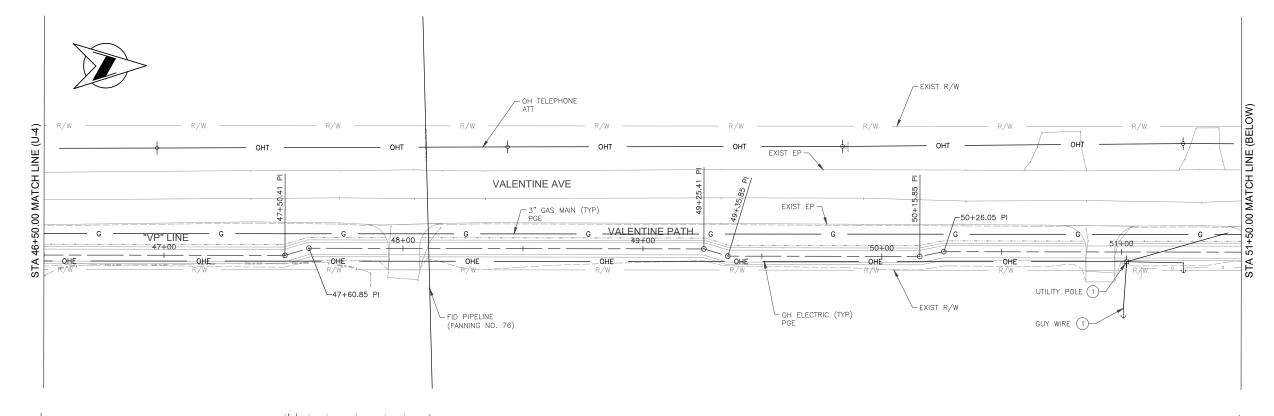

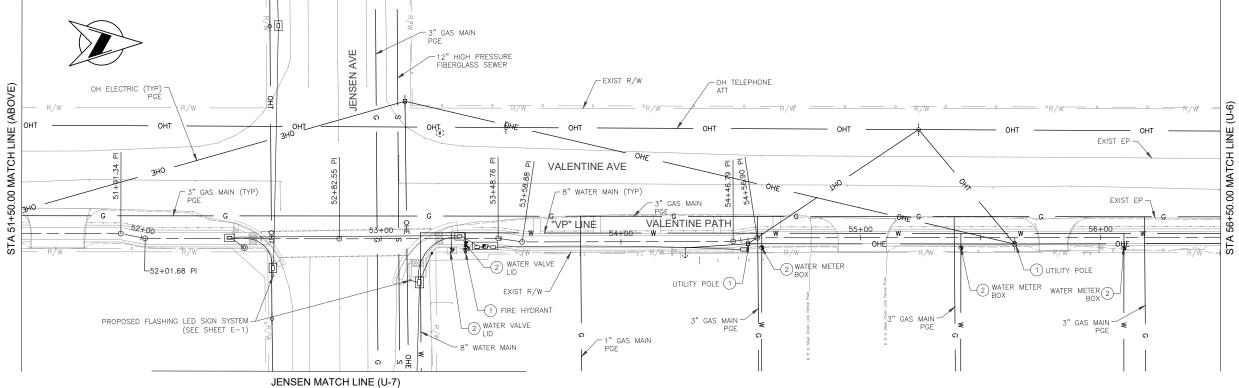



APPROVED FOR UTILITY WORK ONLY

	DATE	RECORD DRAWING	}	SCALE		ROFESS OW	PROJEC [*]	T COV	DEPARTMENT	OF PUBLIC WORKS	AND PLANNING
DESIGNED: S. VANG	12/20/2021	RESIDENT ENGINEER	DATE			El Khey-Khows &		151-0m	[2]	UTILITY PLANS	
DRAWN: M. MORILLAS	12/20/2021			NO SCALE	Dewberry of	drake haglan No. 70950	WEST PARK SIDEWA	ALK PROJECT)		
CHECKED: G. GROSS	12/20/2021			NO SCALE	•	Exp.6/30/23 / */		1850	VALENTIN	E AVE STA 46+50.00	TO STA 56+50.00
FOR RIGHT OF WAY DATA AND ACCURATE ACCESS	DETERMINATION, SEE D	OCUMENTS IN THE DEPARTMENT OF PUBLIC WORKS AND PL	ANNING.			OF CAUFORN	ROAD NO.	BRIDGE NO.	DRAWING NO. 11313	SHEET NO. U-5	TOTAL 35


- 1. UTILITIES SHOWN ARE APPROXIMATE.
- 2. UTILITIES REPLACED AS DIRECTED BY
- 3. UNLESS OTHERWISE SHOWN, PROTECT ALL EXISTING UTILITIES IN PLACE.

- PROTECT EXIST UTILITY IN PLACE
- 2) ADJUST UTILITY TO GRADE

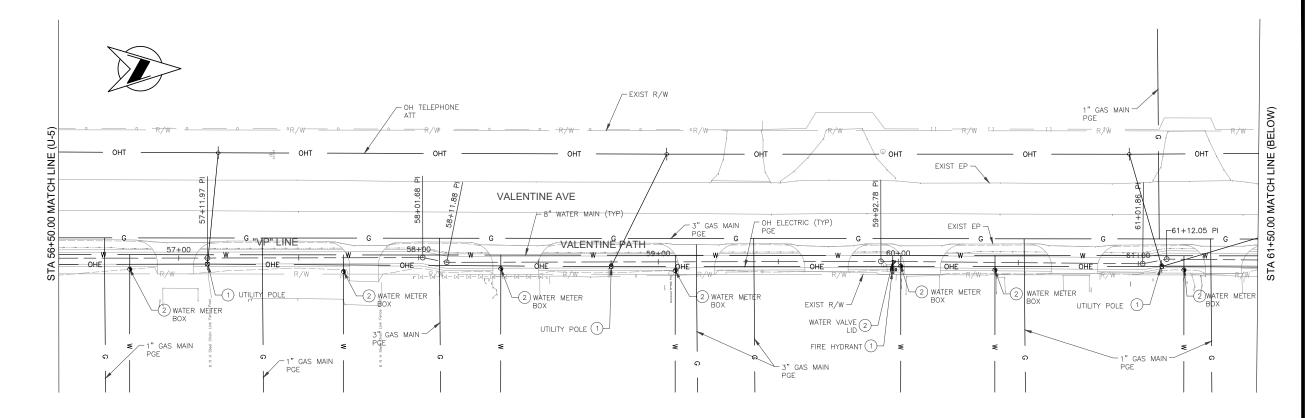

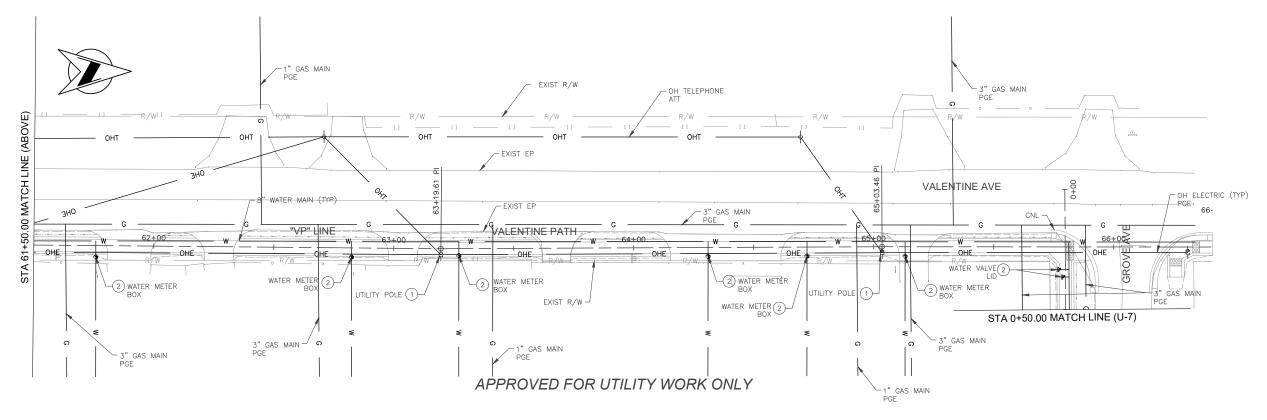

	DATE	RECORD DRAWIN	G	SCALE		ROFESS ON	PROJECT	COUN	DEPARTMENT OF	PUBLIC WORKS AN	ID PLANNING
DESIGNED: S. VANG	12/20/2021	RESIDENT ENGINEER	DATE			(S) Khey-Khres &				ITILITY PLANS	
DRAWN: M. MORILLAS	12/20/2021			NO SCALE	Dewberry	drake haglan No. 70950	WEST PARK SIDEWALK PRO	DJECI (QL) III P		/E STA 56+50 TO ST	
CHECKED: G. GROSS	12/20/2021			NO SCALE	•	Exp.6/30/23			VALENTINE AVE STA	4 61+50 TO GROVE	AVE STA 0+50
FOR RIGHT OF WAY DATA AND ACCURATE ACCESS I	DETERMINATION, SEE	DOCUMENTS IN THE DEPARTMENT OF PUBLIC WORKS AND	LANNING.			OF CALIFORNI	ROAD NO. BRIDGE		DRAWING NO. 11313	SHEET NO. U-6	TOTAL 35

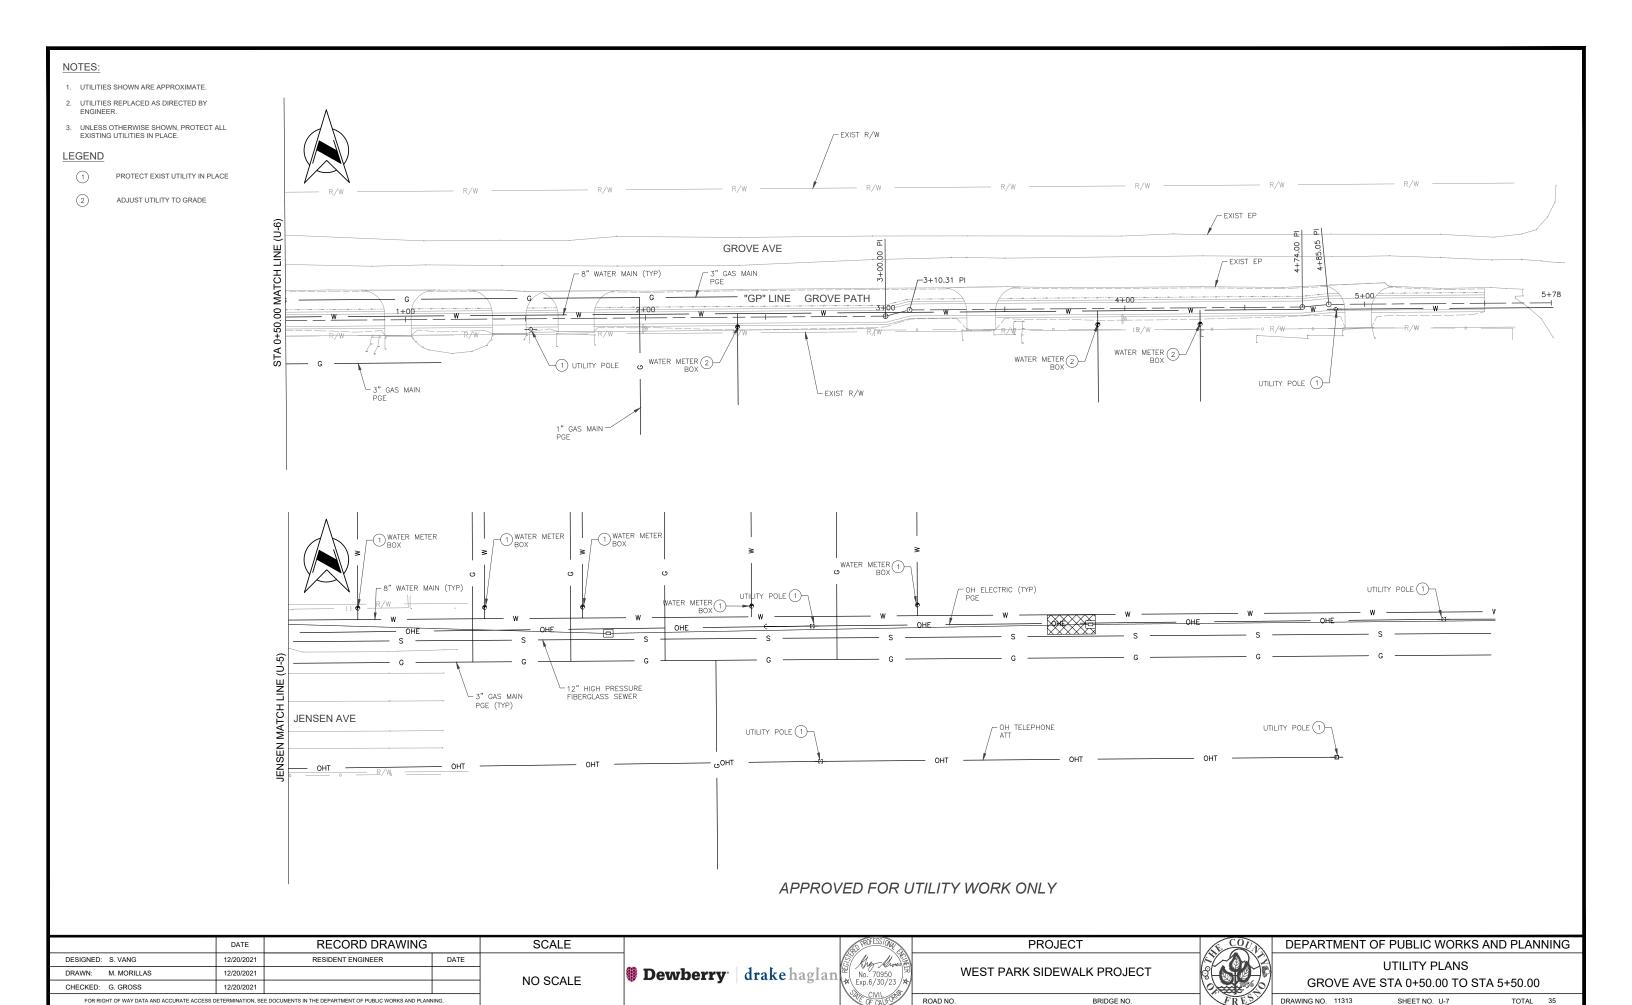

NOTES: FOR ALL PAVEMENT STRIPING AND MARKING DETAILS, REFER TO CALTRANS STANDARD PLANS DATED 2015. FOR ROADSIDE SIGN DETAILS, REFER TO 2014 VERSION OF THE CALIFORNIA MUTCD. ALL TRAFFIC STRIPES SHALL BE THERMOPLASTIC. RELOCATED SIGNS SHALL BE EQUIPPED WITH A NEW POST. 5. ALL HMA DIKE (TYPE D) ARE TO BE PAINTED WHITE. ARROW ON SIGN SHALL POINT TOWARDS WALKWAY AND SIGN ORIENTATION IS AS SHOWN. **LEGEND** ▲ EXISTING SIGN TO REMAIN (PROTECT IN PLACE). RELOCATE ROADSIDE SIGN. FURNISH ROADSIDE SIGN ROADSIDE SIGN ONE POST BEGIN END OF TRAFFIC STRIPE DETAIL # TRAFFIC STRIPE DETAIL NUMBER WWW WHITE CROSSWALK THERMOPLASTIC MARKING YELLOW CROSSWALK THERMOPLASTIC MARKING - GRIND AND PLACE NEW THERMOPLASTIC PAVEMENT MARKING 3+00 VALENTINE PATH 5+00 6+00 "VP" LINE "VP" 1+25.00 8.00' L "VP" 2+50.00 8.00' L SW24-3 (CA) SR4-1 (CA)

APPROVED FOR SIGNING AND STRIPING WORK ONLY

VALENTINE AVE

	DATE	RECORD DRAWING		SCALE		SUD PROFESSIONAL	PRO	OJECT	ST COV	DEPARTMENT O	F PUBLIC WORKS	AND PLANNING
DESIGNED: S. VANG	12/20/2021	RESIDENT ENGINEER	DATE			El Kher-Khris D			ST-0-12	SIGNING	AND STRIPING PLA	ANG
DRAWN: M. MORILLAS	12/20/2021			HORIZ 0 10' 20'	Dewberry	drake haglan No. 70950	WEST PARK SII	DEWALK PROJECT				
CHECKED: G. GROSS	12/20/2021				,	Exp.6/30/23 /#				VALENTINE AV	'E STA 1+00.00 TO	STA 6+50.00
FOR RIGHT OF WAY DATA AND ACCURATE ACCESS D	DETERMINATION, SEE	DOCUMENTS IN THE DEPARTMENT OF PUBLIC WORKS AND PLA	NNING.			OF CALIFORNIA	ROAD NO.	BRIDGE NO.	FRES	DRAWING NO. 11313	SHEET NO. SS-1	TOTAL 35



- FOR ALL PAVEMENT STRIPING AND MARKING DETAILS, REFER TO CALTRANS STANDARD PLANS DATED 2015.
- FOR ROADSIDE SIGN DETAILS, REFER TO 2014 VERSION OF THE CALIFORNIA MUTCD.
- 3. ALL TRAFFIC STRIPES SHALL BE THERMOPLASTIC.
- 4. RELOCATED SIGNS SHALL BE EQUIPPED WITH A NEW POST.
- 5. ALL HMA DIKE (TYPE D) ARE TO BE PAINTED WHITE.
- 6. ARROW ON SIGN SHALL POINT TOWARDS WALKWAY AND SIGN ORIENTATION IS AS SHOWN

LEGEND

▲ EXISTING SIGN TO REMAIN (PROTECT IN PLACE).

RELOCATE ROADSIDE SIGN.

FURNISH ROADSIDE SIGN


ROADSIDE SIGN ONE POST


BEGIN END OF TRAFFIC STRIPE DETAIL

TRAFFIC STRIPE DETAIL NUMBER


WHITE CROSSWALK THERMOPLASTIC MARKING


 $\overleftarrow{\langle\!\langle \Upsilon\Upsilon W\!\rangle} \ \ \Upsilon \text{ELLOW CROSSWALK THERMOPLASTIC MARKING}$

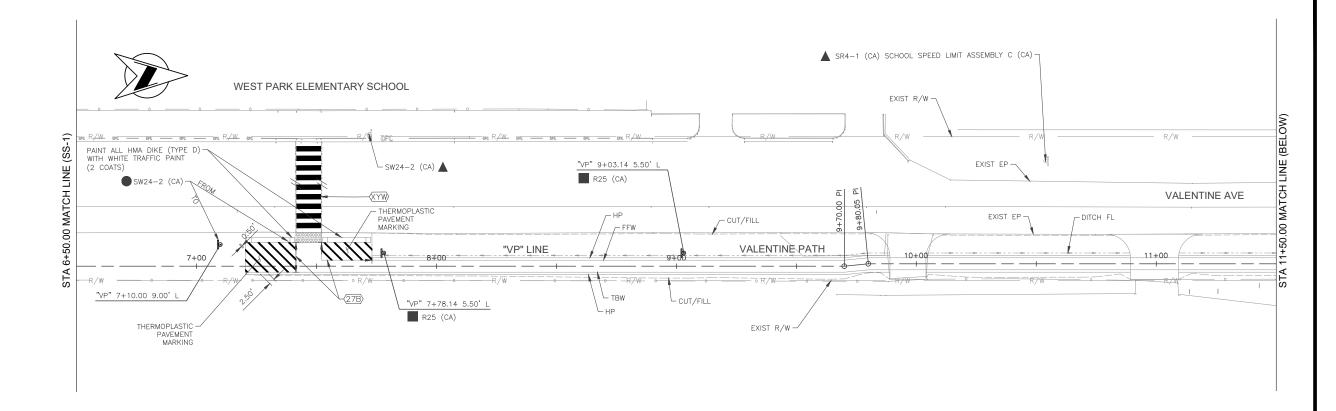


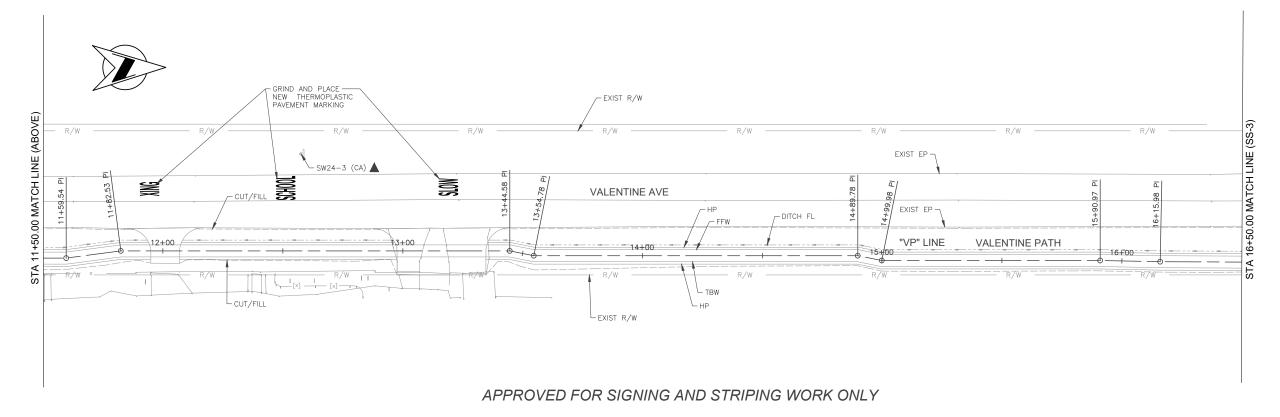



	DATE	RECORD DRAWING		SCALE		PROFESS/OW		PROJECT	COUN	DEPARTMENT C	OF PUBLIC WORKS	AND PLANNING
DESIGNED: S. VANG	12/20/2021	RESIDENT ENGINEER	DATE			El Kher-Khrus A	\			SIGNING	AND STRIPING PL	ANS
DRAWN: M. MORILLAS	12/20/2021			HORIZ 0 10'	20' ® Dewberrv ®	drake haglan No. 70950	WEST PARK	SIDEWALK PROJECT			_	
CHECKED: G. GROSS	12/20/2021					Exp.6/30/23 /				VALENTINE A	VE STA 7+00.00 TO	STA 16+50.00
FOR RIGHT OF WAY DATA AND ACCURATE	ACCESS DETERMINATION, SEE	DOCUMENTS IN THE DEPARTMENT OF PUBLIC WORKS AND PLAN	NING.			OF CALIFORNIA	ROAD NO.	BRIDGE NO.	FRES	DRAWING NO. 11313	SHEET NO. SS-2	TOTAL 35

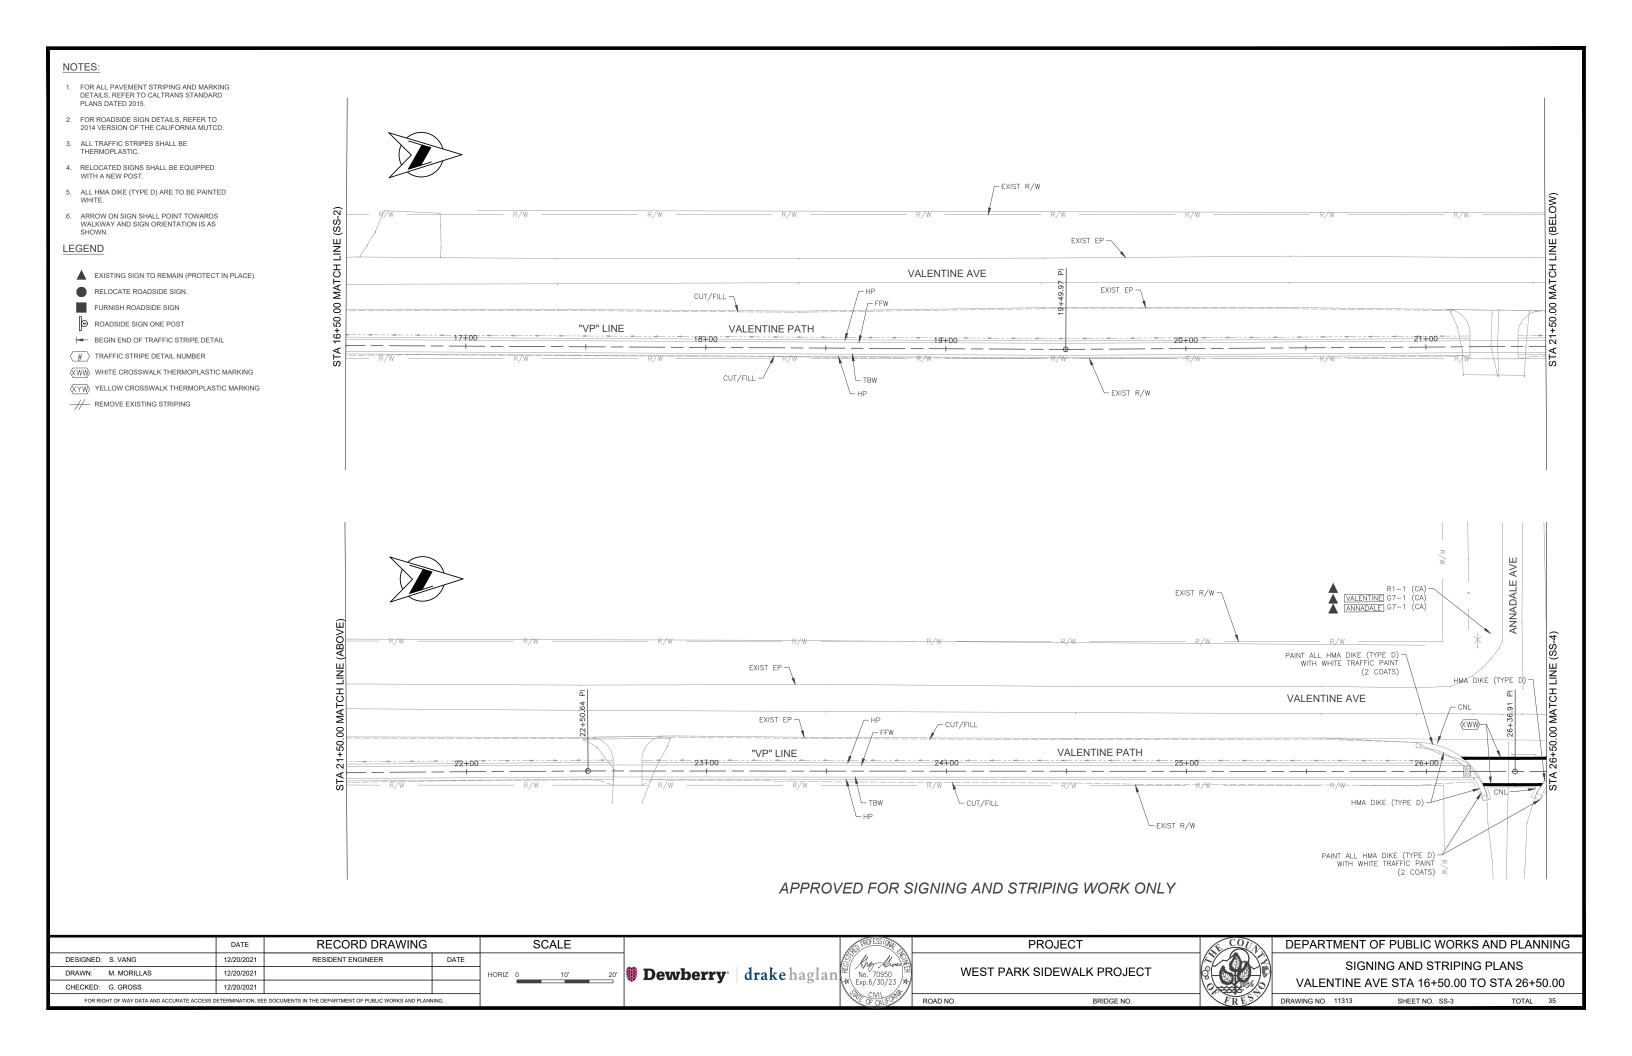

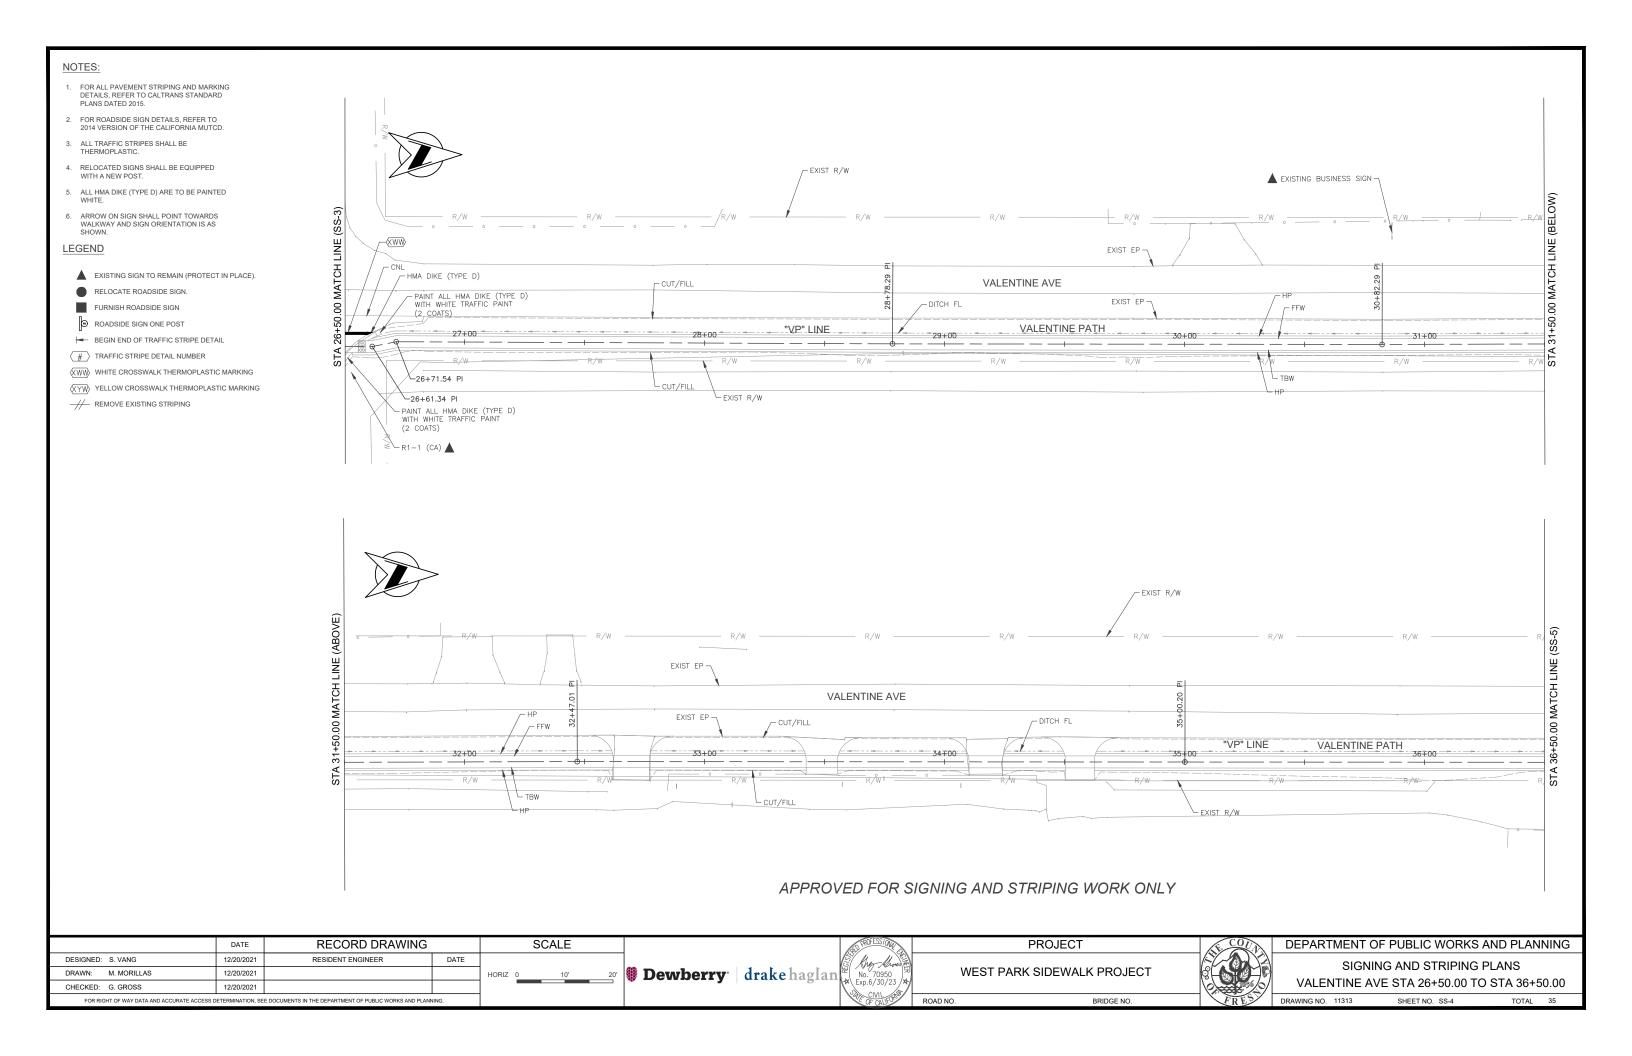

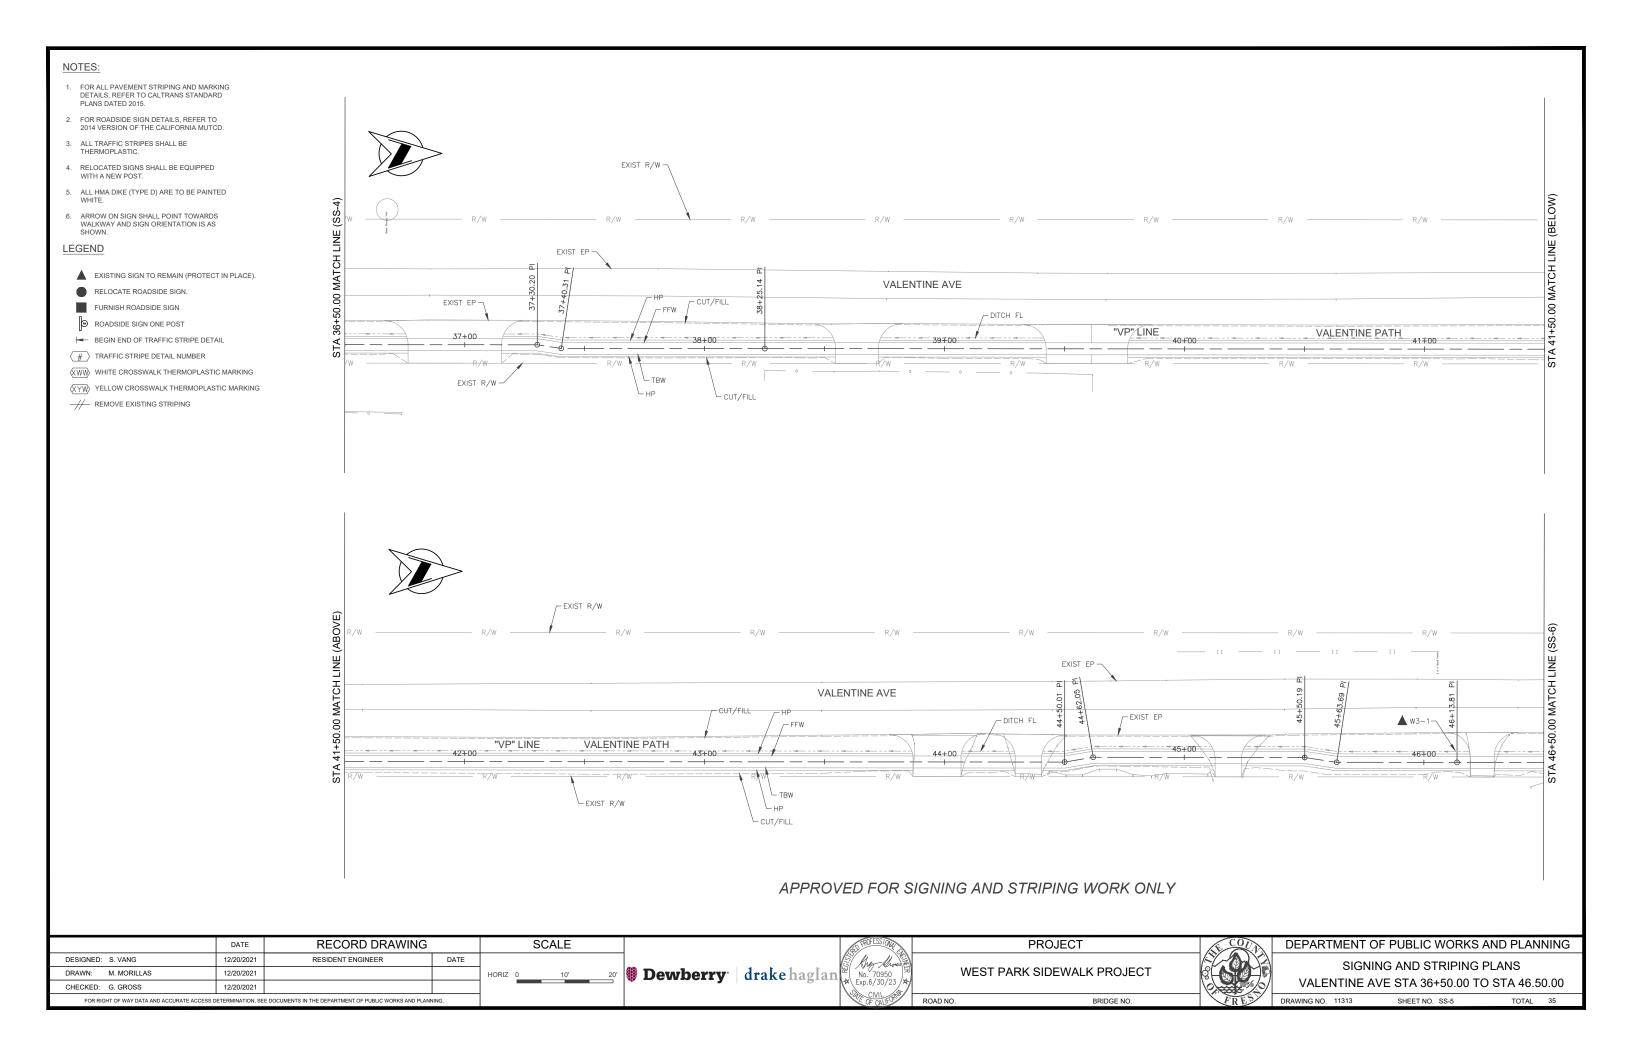

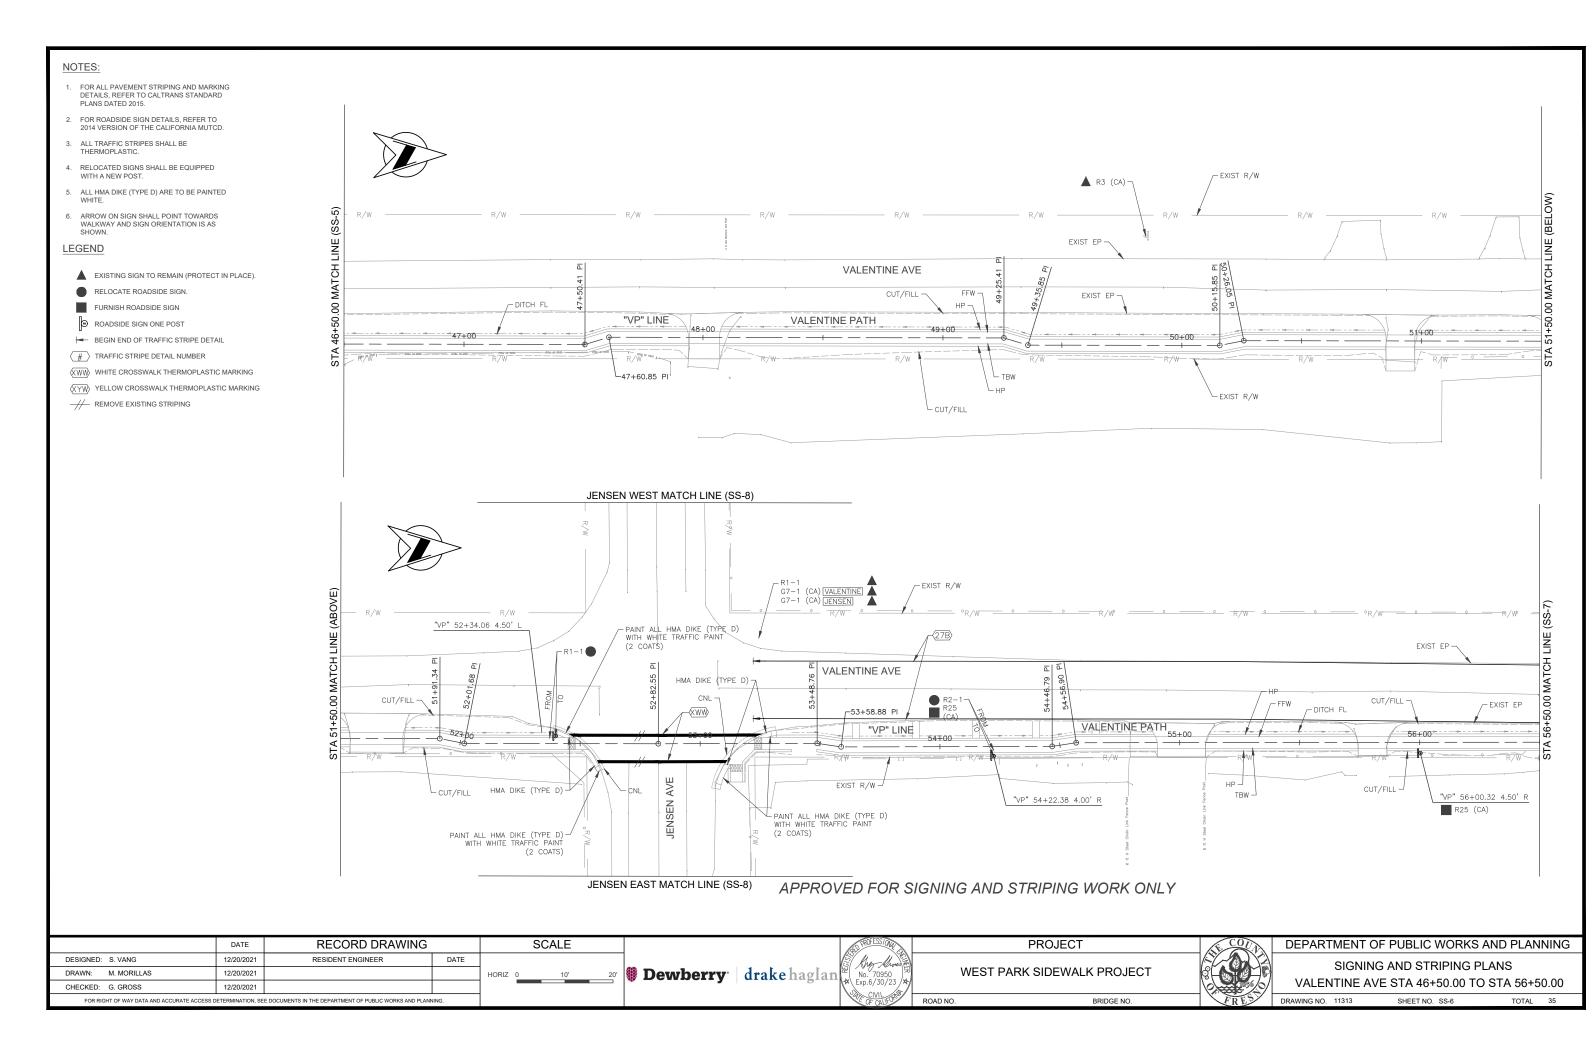

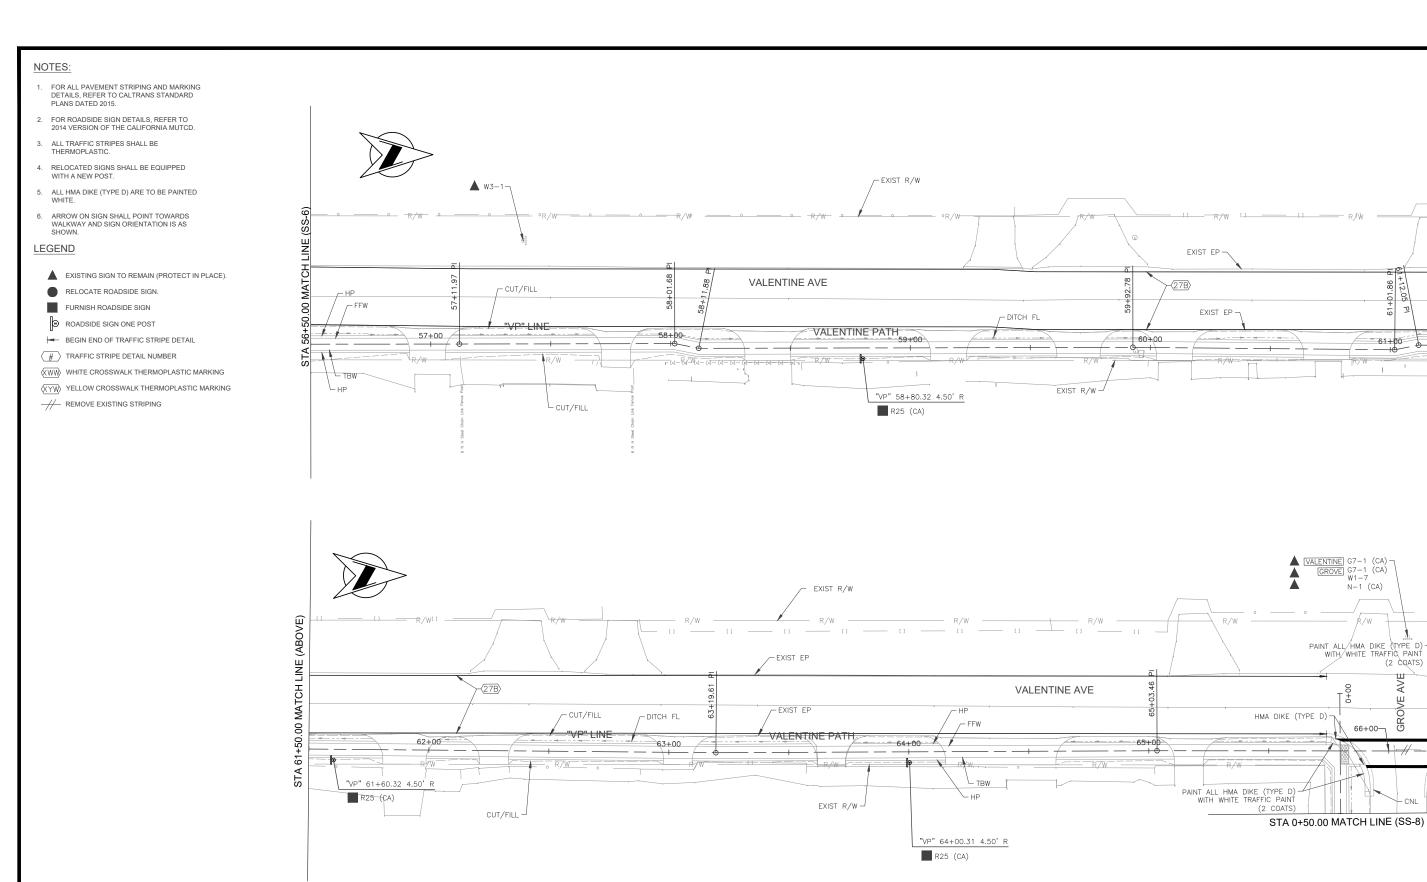

Α	PPROVE	D FOR	SIGNING	AND	STRIPING	WORK	ONLY

(BELOW)

LINE


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66+51-

↓ HMA DIKE

(TYPE D)

	DATE	RECORD DRAWING		SCALE		S PROFESS/ONAL	PROJECT	AL CO	DEPARTM	ENT OF PUBLIC WORKS	S AND PLANNING
DESIGNED: S. VANG	12/20/2021	RESIDENT ENGINEER	DATE			the lives &		(=V-0)	1/2	SIGNING AND STRIPING	
DRAWN: M. MORILLAS	12/20/2021			HORIZ 0 10' 20'	Dewberry drake haglan	No. 70950	WEST PARK SIDEWALK P	ROJECT	VALEN	ITINE AVE STA 56+50 TO	
CHECKED: G. GROSS	12/20/2021					Exp.6/30/23 /*/			VALENTINE	AVE STA 61+50 TO GRO	OVE AVE STA 0+50
FOR RIGHT OF WAY DATA AND ACCURATE ACCESS D	ETERMINATION, SEE DOCUMEN	ITS IN THE DEPARTMENT OF PUBLIC WORKS AND PLAN	NING.			OF CALIFORN	ROAD NO. BRIE	DGE NO.	DRAWING NO. 11	SHEET NO. SS-7	TOTAL 35

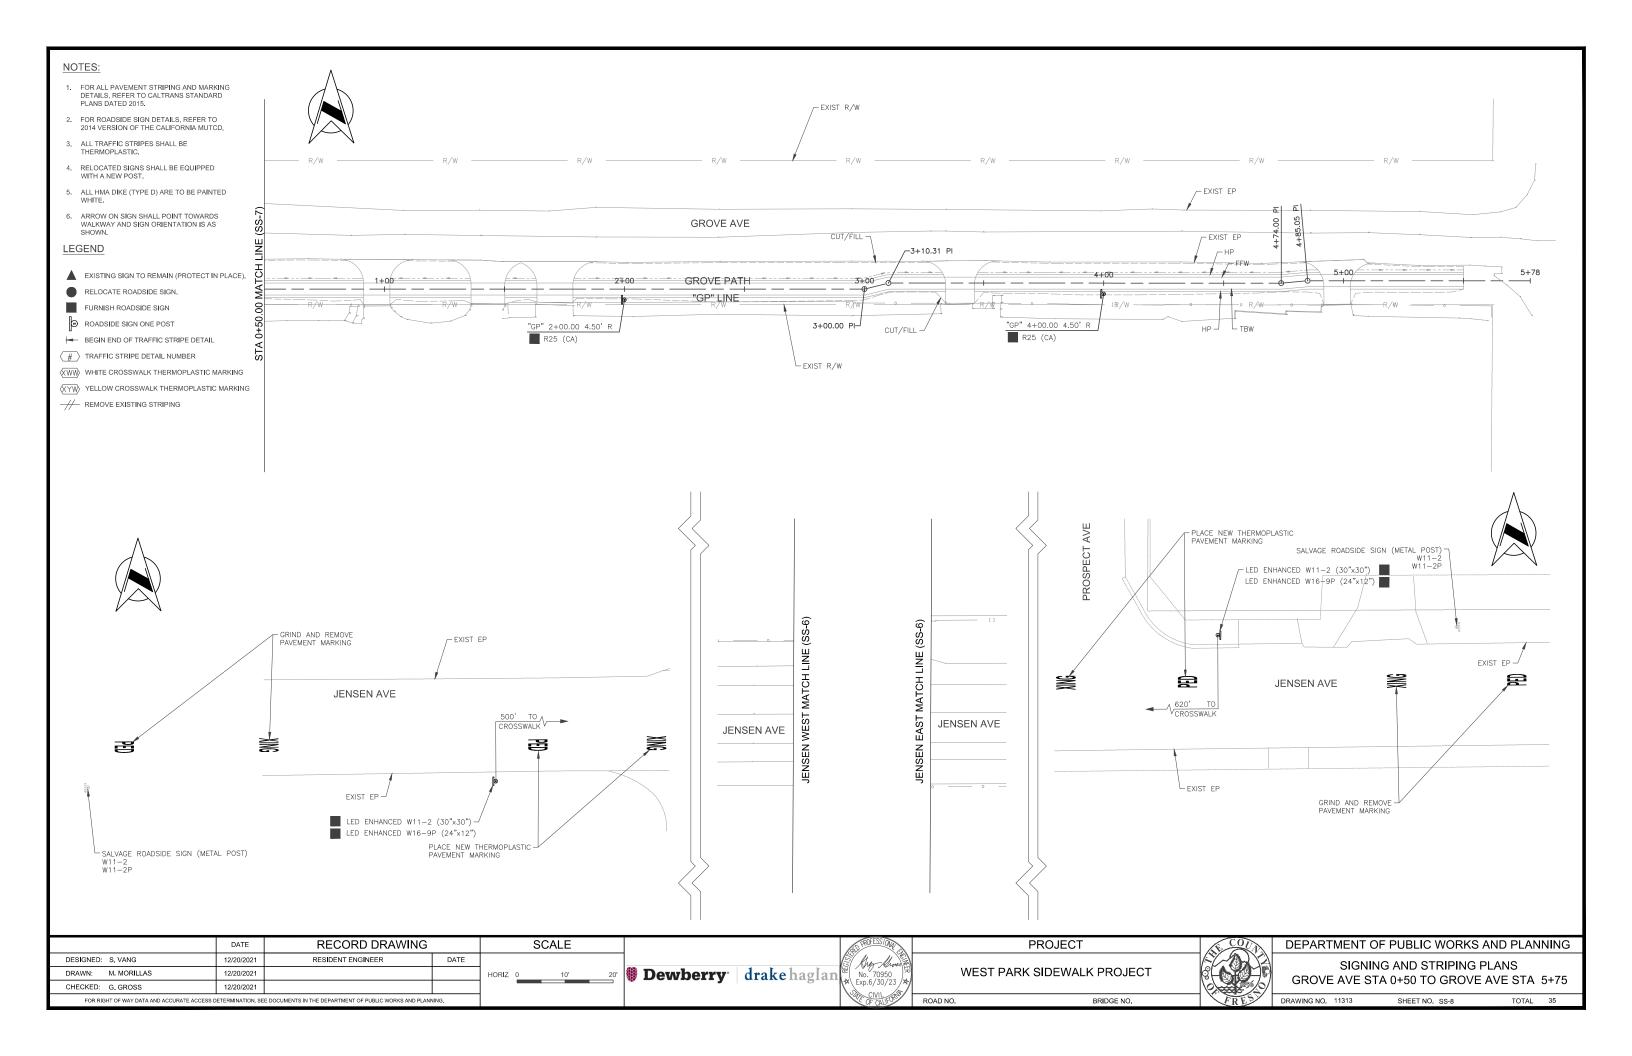


CONSTRUCTION NOTES (FOR THIS SHEET ONLY) WORK SHALL BE DONE IN ACCORDANCE WITH THE 2015 EDITION OF THE STATE OF CALIFORNIA DEPARTMENT OF TRANSPORTATION STANDARD PLANS AND SPECIFICATIONS; THE LATEST EDITION OF THE CALIFORNIA MANUAL ON UNIFORM TRAFFIC CONTROL DEVICES (CA MUTCD); THE COUNTY OF FRESNO PLANS AND SPECIFICATIONS: THE TECHNICAL SPECIFICATIONS OF THE COUNTY OF FRESNO: THE MANUFACTURER'S SPECIFICATIONS. AND THESE PLANS 2. THIS SHEET IS ACCURATE FOR ELECTRICAL WORK ONLY. 3. THE CONTRACTOR SHALL DETERMINE THE EXACT LOCATION OF UNDERGROUND UTILITIES, THEIR FACILITIES, AND ASSOCIATED EQUIPMENT. PROTECTION SHALL BE PROVIDED PRIOR TO AND DURING DEMOLITION, TRENCHING, EXCAVATION, JACKING, AND BORING. CONTACT UNDERGROUND SERVICE ALERT (USA), TOLL FREE AT 811, AT LEAST 2 WORKING DAYS BEFORE BEGINNING WORK. 4. AFTER ALL UNDERGROUND UTILITIES ARE MARKED, THE CONTRACTOR SHALL ESTABLISH THE LOCATIONS OF ALL SIGN POSTS AND PEDESTRIAN PUSH BUTTON POSTS AND RELATED FACILITIES. THE CONTRACTOR SHALL THEN ARRANGE WITH THE COUNTY RESIDENT ENGINEER TO APPROVE THOSE LOCATIONS PRIOR TO THE START OF ANY WORK. THE CONTRACTOR SHALL REFER TO THE LATEST VERSION OF THE COUNTY STANDARD SPECIFICATIONS AND THE STATE STANDARD SPECIFICATIONS FOR TRAFFIC SIGNAL, ELECTRICAL, AND RELATED FACILITIES INSTALLATION. 6. PULL BOXES SHALL BE NO. 5(E) UNLESS OTHERWISE NOTED. ALL PULL BOXES SHALL HAVE EXTENSIONS AND VANDAL RESISTANT LOCKING LIDS. 7. PULL BOXES INSTALLED IN NON-CONCRETE AREAS SHALL BE SURROUNDED BY A 12" CONCRETE COLLAR TO THE FULL DEPTH OF THE PULL BOX PLUS EXTENSION. 8. SEAL CONDUIT OPENINGS WITH AN APPROVED DUCT SEAL AFTER ALL CONDUCTORS HAVE BEEN INSTALLED. CONDUITS ENTERING AND DEPARTING PULL BOXES SHALL BE INSTALLED SUCH THAT THE ALIGNMENT OF THE CONDUIT ENTERING THE PULL BOX IS

10. ALL CONDUITS SHALL HAVE BUSHINGS INSTALLED PRIOR TO INSTALLING CONDUCTORS. THIS INCLUDES BOTH ENDS OF THE NON-METALLIC CONDUITS.

MAINTAINED. VERTICAL SWEEPS SHALL NOT BE ALLOWED.

1-800-227-2600

STEEL CONDUITS SHALL HAVE BONDING BUSHINGS INSTALLED.

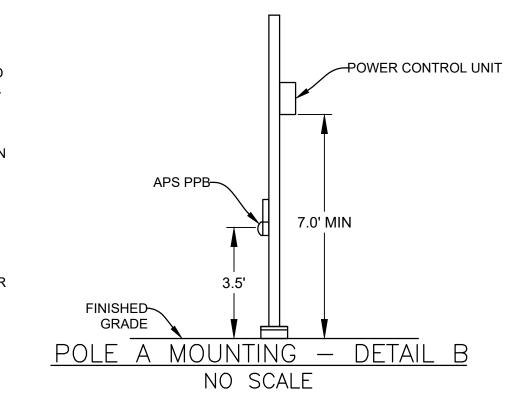

PROJECT NOTES (THIS SHEET ONLY):

- FURNISH AND INSTALL TYPE III-AF SERVICE ENCLOSURE WITH BBS. CABINET DOOR SHALL FACE SOUTH.
- 2 | FURNISH AND INSTALL PG&E APPROVED PULL BOX.
- FURNISH AND INSTALL No. 5(E) PULL BOX INSCRIBED "ELECTRICAL".
- INSTALL 10.5' X 3.25' X 4" PCC PAD. SEE SHEET L-10 FOR PCC PAD LOCATION.


LEGEND (THIS SHEET ONLY):

- SECTION LINE
- **EDGE OF PAVEMENT**
- FURNISH AND INSTALL No. 5(E) PULL BOX, UNLESS OTHERWISE NOTED.
- FURNISH AND INSTALL No. 5(E)(T) PULL BOX, UNLESS OTHERWISE NOTED, WITH A 12" CONCRETE COLLAR EQUAL TO THE DEPTH OF THE PULL BOX PLUS EXTENSION.
- "X" IDENTIFIES THE PULL BOX LOCATION NUMBER FOR STATION AND OFFSET DETAILS.



RECEIVING PIT STAGING AREA


	EQUIPMENT SCHEDULE									
No.	TYPE	SPECIAL REQUIREMENTS								
A	1-B (10')	STANDARD SHALL BE PER CALTRANS 2015 REVISED STANDARD PLAN ES-7B. FURNISH AND INSTALL APS PPB 3'-6" ABOVE THE FINISHED GRADE. FURNISH AND INSTALL POWER CONTROL UNIT AND ALL ANCILLARY DEVICES FOR THE ACTUATED LED SIGN SYSTEM.								
B	SIGN POST (10')	STANDARD SHALL BE THE COMBINED STREET SIGN PUSH BUTTON ASSEMBLY POST PER CALTRANS 2015 REVISED STANDARD PLAN ES-7A. FURNISH AND INSTALL LED ENHANCED W11-2 (30" X 30") AND W16-7P (24" X 12") SIGNS.								
(C)	SIGN POST (10')	STANDARD SHALL BE THE COMBINED STREET SIGN PUSH BUTTON ASSEMBLY POST PER CALTRANS 2015 REVISED STANDARD PLAN ES-7A. FURNISH AND INSTALL LED ENHANCED W11-2 (30" X 30") AND W16-7P (24" X 12") SIGNS.								
D	2 ½" PPB POST (5' 7")	STANDARD SHALL BE THE PUSH BUTTON ASSEMBLY POST (5' 7") PER CALTRANS 2015 REVISED STANDARD PLAN ES-7A. APS PPB SHALL BE MOUNTED 3'-6" ABOVE THE FINISHED GRADE.								
E	SIGN POST (10')	STANDARD SHALL BE THE COMBINED STREET SIGN PUSH BUTTON ASSEMBLY POST PER CALTRANS 2015 REVISED STANDARD PLAN ES-7A. FURNISH AND INSTALL LED ENHANCED W11-2 (30" X 30") AND W16-9P (24" X 12") SIGNS.								
F	SIGN POST (10')	STANDARD SHALL BE THE COMBINED STREET SIGN PUSH BUTTON ASSEMBLY POST PER CALTRANS 2015 REVISED STANDARD PLAN ES-7A. FURNISH AND INSTALL LED ENHANCED W11-2 (30" X 30") AND W16-9P (24" X 12") SIGNS.								

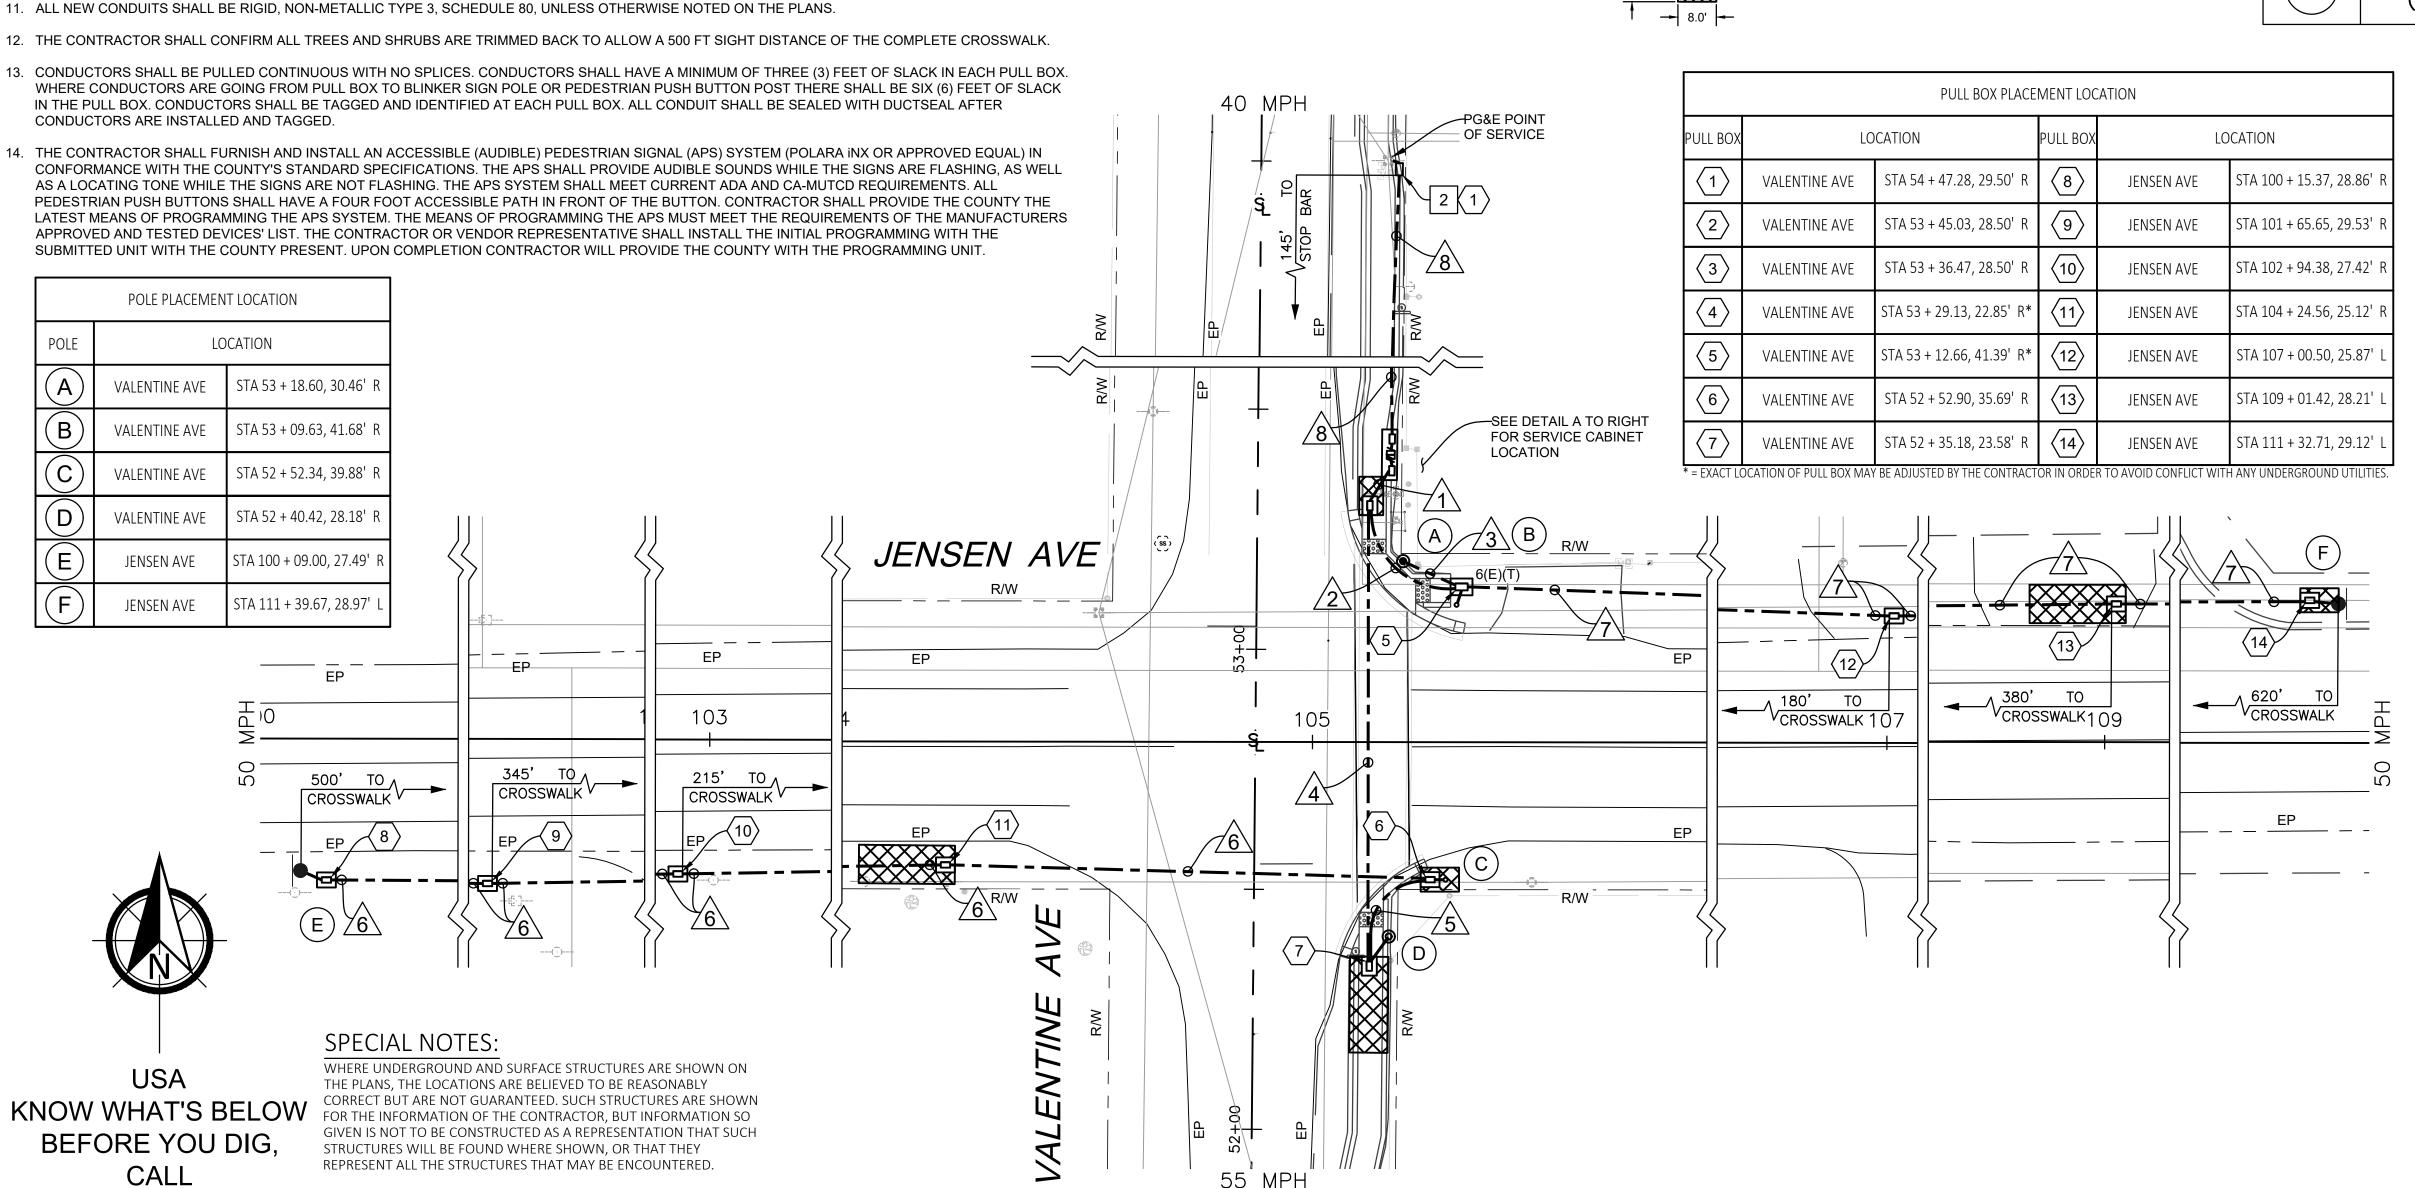

55 MPH

(UNPOSTED)

	CONDUCTOR SCHEDULE														
A)A/C			CONDUIT RUN NUMBER AND SIZE												
AWG OR CABLE	POLE	Ø	\triangle	2	3	4	<u></u>	6	<u>^</u>	8					
			2"	2"	1.5"	3"	2"	3"	2"	2"					
С	CONDUIT FILL			11%	12%	3%	5%	2%	4%	13%					
# 2	SERVIC	Œ								3					
#8	BOND)	1	1	1	1	1	1	1						
# 10	LED BLINKER (CONTROL	2	2	2										
# 10	LED SIG	LED SIGN				2	2	2	2						
# 14	LED BLINKE	R SIGN		4	4	2	2								
# 14	APS PP	В		2	2	2									

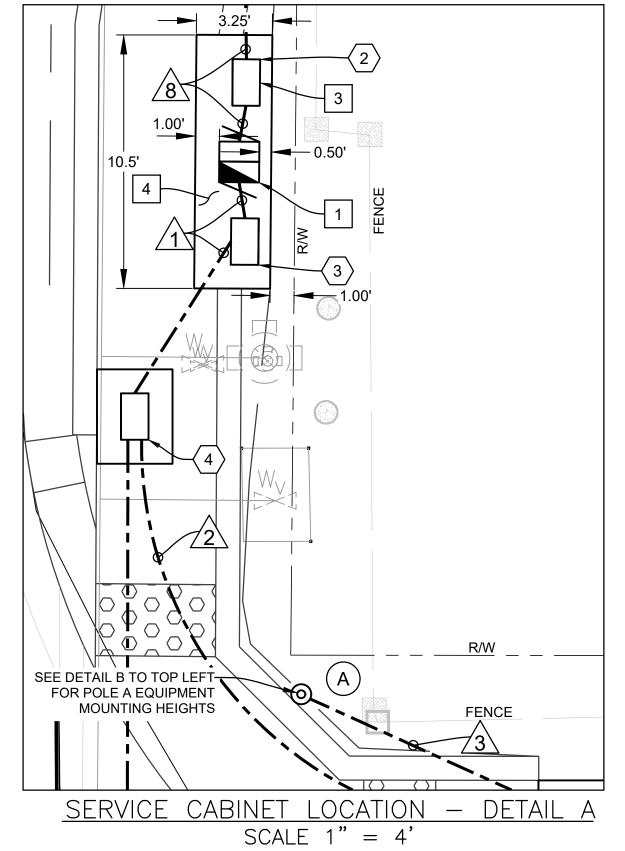

DEPARTMENT OF PUBLIC WORKS AND PLANNING

FLASHING LED SIGN SYSTEM

TOTAL 32 DRAWING NO. E-1 SHEET NO. 32

SCALE RECORD DRAWING RESIDENT ENGINEER DATE DESIGNED: J. BENAVIDES 08/05/2022 DRAWN: C. AYALA-MAGANA 08/05/2022 CHECKED: J. BENAVIDES 08/05/2022 SCALE: 1"=20' FOR RIGHT OF WAY DATA AND ACCURATE ACCESS DETERMINATION, SEE DOCUMENTS IN THE DEPARTMENT OF PUBLIC WORKS AND PLANNING

CONTRACTOR SHALL DETERMINE PRESENCE OF EXISTING FACILITIES

AND SHALL NOTIFY THE ENGINEER OF POTENTIAL CONFLICTS.



WEST PARK SIDEWALK PROJECT

PROJECT

ROAD NO. BRIDGE NO.