



**DEPARTMENT of PUBLIC WORKS and PLANNING**  
**DEVELOPMENT SERVICES DIVISION**



# Model No. LM-470

**TYPE:** Self-supporting, extendable, crank-up tower.

**SPECIFICATIONS:**

TOWER HEIGHT: Extended 69'-6". Retracted 25'-6".

TOWER SUPPORT: Self-supporting, no guys.

WIND LOADING: Engineering analysis indicates the tower will support an antenna with an equivalent effective projected area of 24-ft<sup>2</sup> at a basic wind speed of 100 MPH, 3-second gust per ANSI/TIA-222-H.

DEAD LOAD: The maximum antenna dead load is 450 lbs.

WEIGHT: The tower with the base weighs 1,200 pounds.

SECTIONS: The tower is made from 4 each 20 foot sections #5, #6, #7 and #8.

**DESCRIPTION:**

Tower is complete with a gearbox, drum, hoisting cables, and a rigid concrete base mount. The tower comes equipped with a rotator plate, manual and one set of drawings and calculations. Hoisting cable system designed to extend the tower telescopic sections uniformly.



The LM-470 is motorized, and includes 1/2 HP electric motor, electric control box and two limit switches wired for 110. This tower has a positive pull down.

"Positive Control" worm gear winch permits the raising and lowering of LM towers without the aid of stops or locks. LM-470 uses a 40:1 ratio winch. The LM-470 also includes a pre-wired motor control assembly.

This tower has a pulley frame on two faces and uses 1/4 x 7 x 19 aircraft cable.

**ACCESSORIES**


- RCB-70LT (#8 Wide Section)
- LM-470 Manual, Drawings, Calculations
- CO-4 for LM-470
- Replacement Pulleys
- TA-70
- Masts
- #5 Rotor Plates
- TB-2 Thrust Bearing
- Cable Kit for LM-470
- RLT

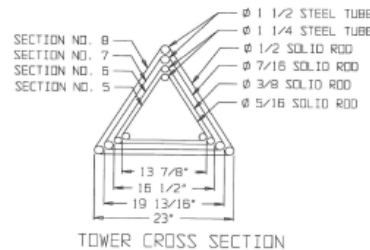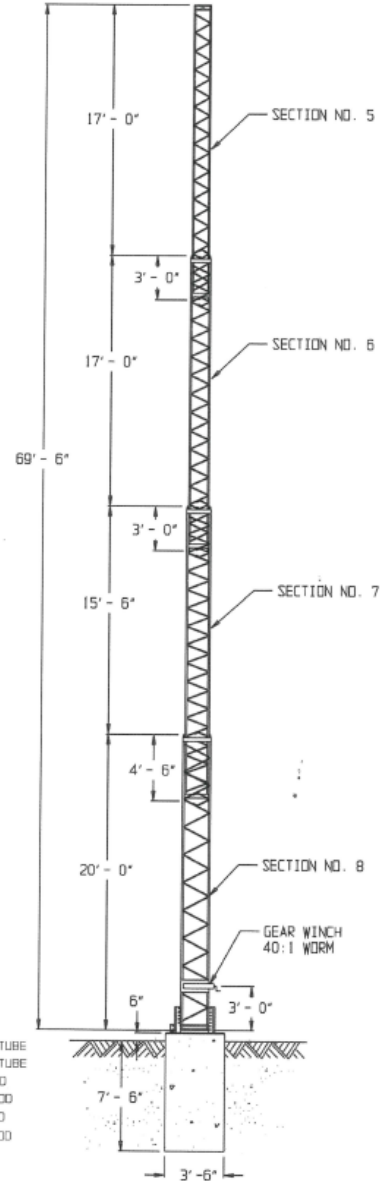


PART# 470-4000 \$11,674.00 USD



# EXISTING ZONING MAP

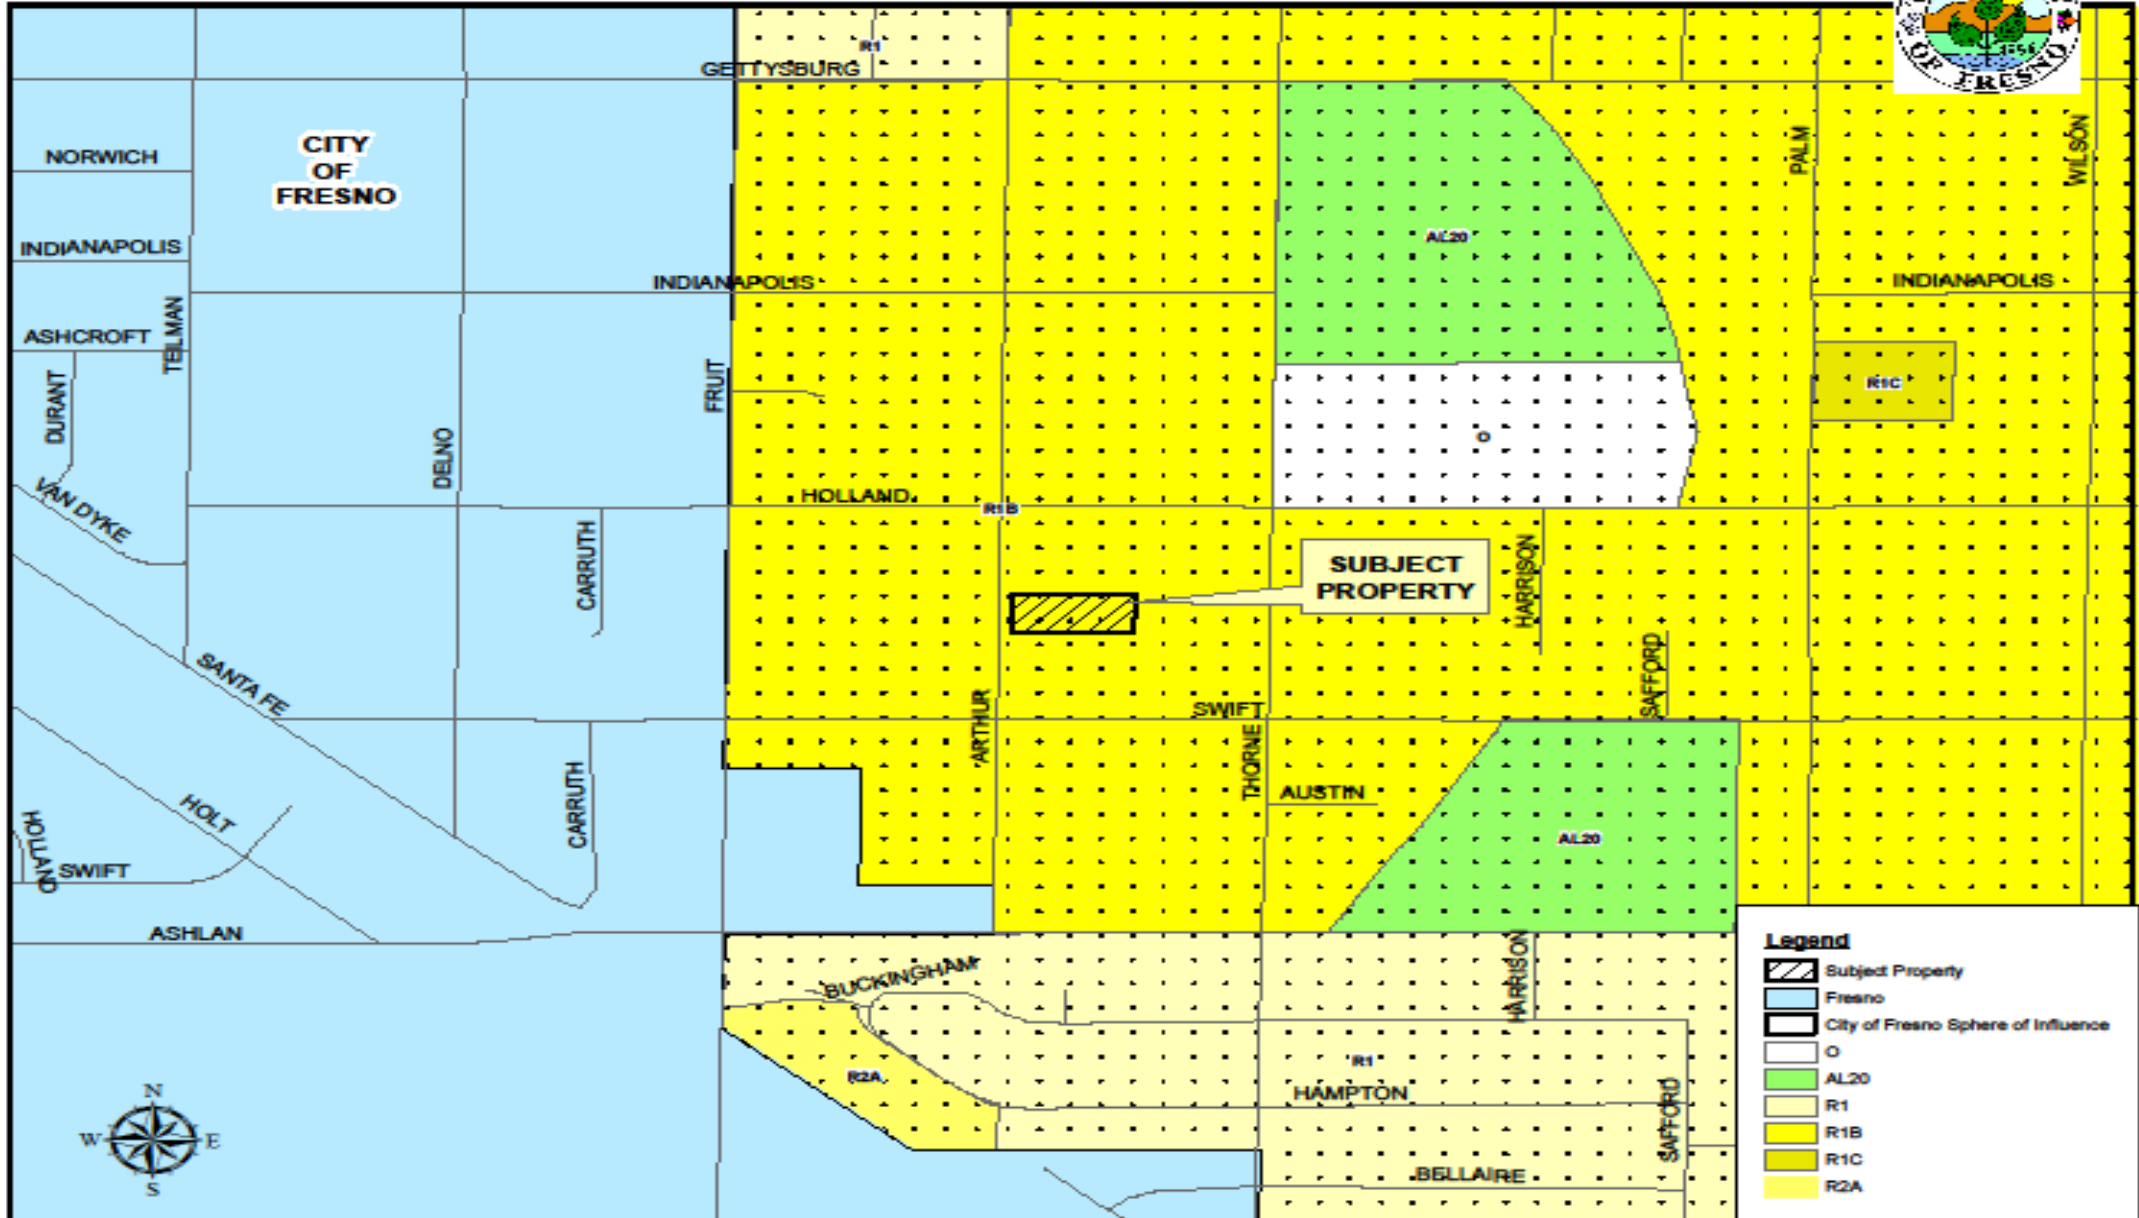

# EXISTING LAND USE MAP

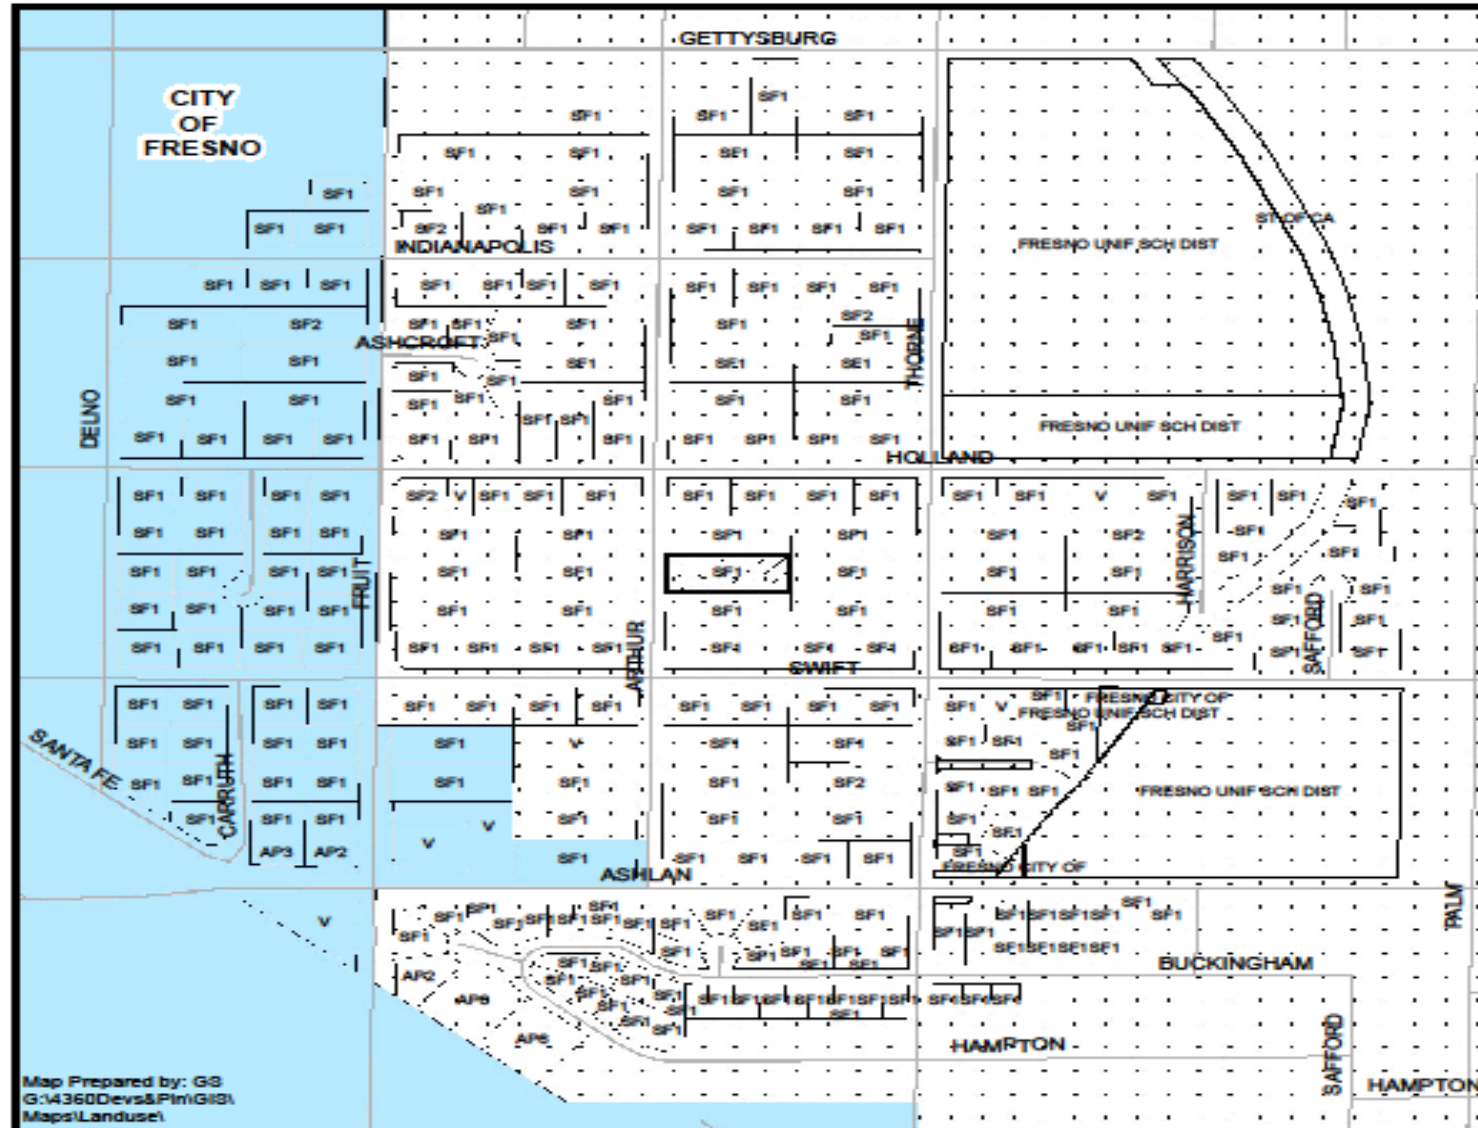

LEGEND	
	AP1 - APARTMENT
	CF - COMMERCIAL
	SFR - SINGLE FAMILY RESIDENCE
	V - VACANT

## Legend

- Subject Property
- Fresno
- City of Fresno Sphere of Influence




0 125 250 500 750 1,000 Feet

Department of Public Works and Planning  
Development Services Division

**NEW HAM RADIO TOWER**  
4352 N. Arthur Ave, Fresno, CA 93705

DATE	5-26-2022
PROJECT NO.	2222
SHEET NO.	1

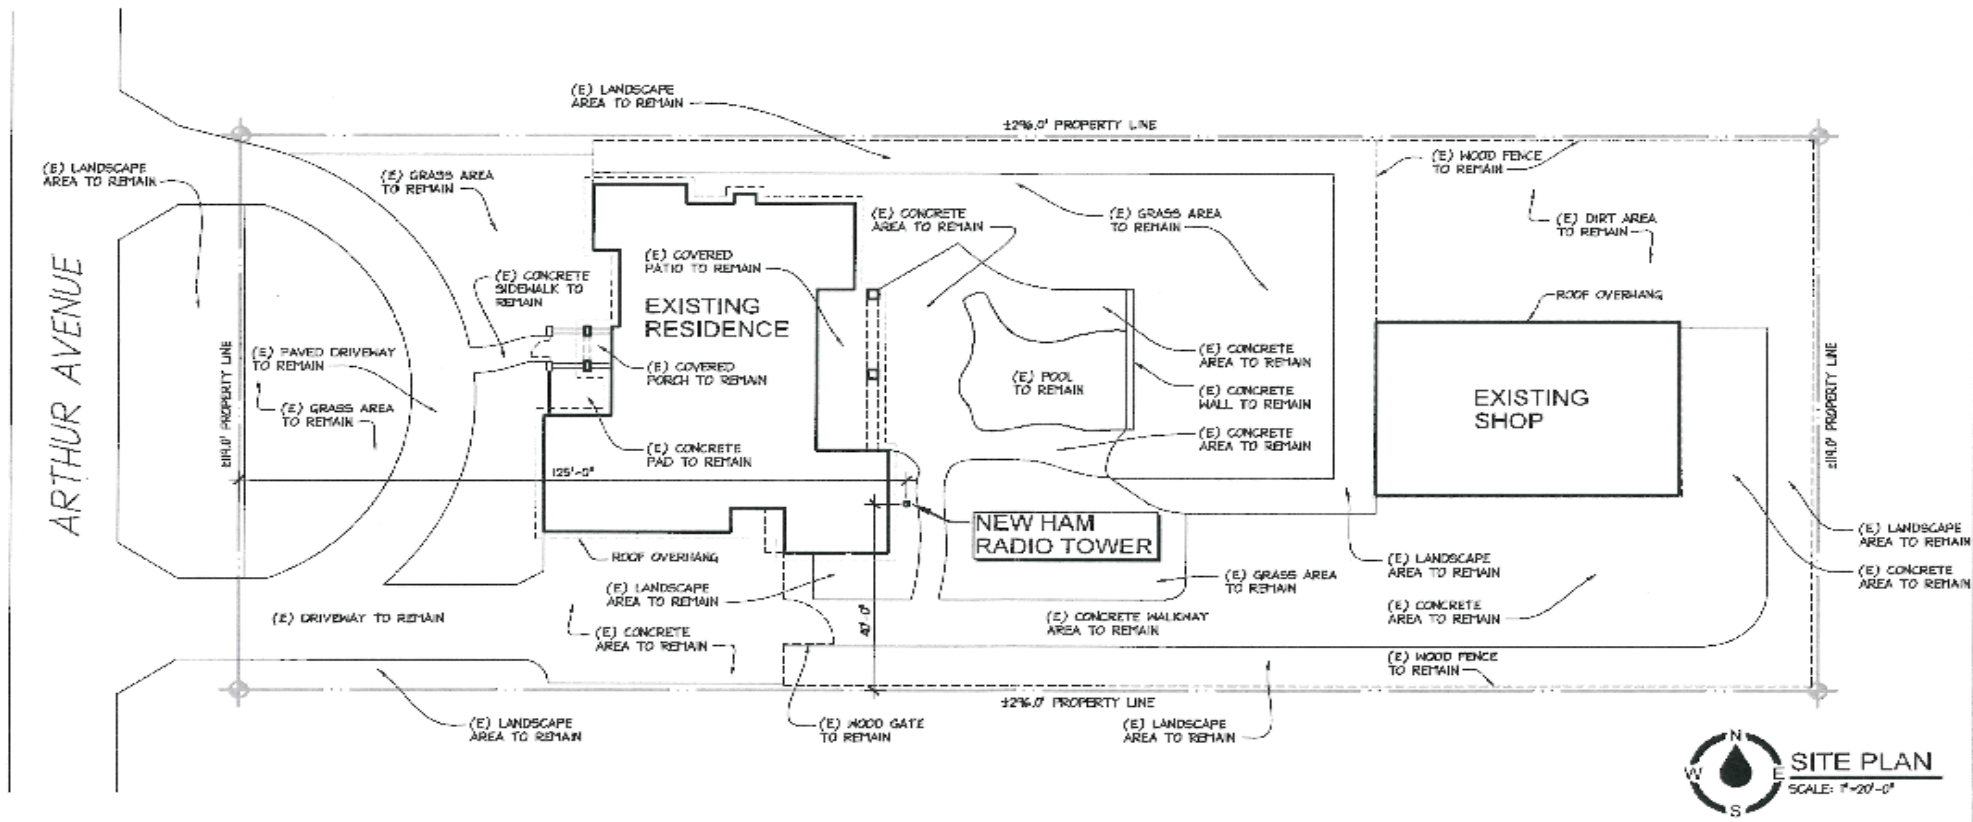

**SITE PLAN**  
SCALE: 1"=20'-0"

ARTHUR AVENUE



4352 N Arthur Ave,  
Fresno, CA 93705

4373

N Arthur Ave

N Arthur Ave

N Arthur Ave

N Arthur Ave

N Arthur Ave

4373

4369

4333

4352









# Public Comment

- Safety of the tower
- Interference with other frequencies such as television, Wi-Fi, and Cellular coverage
- Health Hazards due to exposure to radio frequency radiation
- Change to the characteristic of the neighborhood

Findings	DRA Findings	Findings Met
1	Size and shape of parcel is adequate.	YES
2	Streets and highways are adequate for use.	YES
3	No adverse effect on neighborhood.	YES
4	General Plan consistency.	YES

# PLANNING COMMISSION MOTIONS:

## Recommended Motion (Approval Action)

- Move to determine the required Findings can be made and move to approve Director Review and Approval No. 4701, subject to the Conditions of Approval and Project Notes listed in Exhibit 1; and
- Direct the Secretary to prepare a Resolution documenting the Commission's action.


## Alternative Motion (Denial Action)

- Move to determine that the required Findings cannot be made and move to deny Director Review and Approval No. 4701; and
- Direct the Secretary to prepare a Resolution documenting the Commission's action.

## Recommended Conditions of Approval and Project Notes:

- See Exhibit 1

# APPROVED DRAs IN A ONE-MILE RADIUS

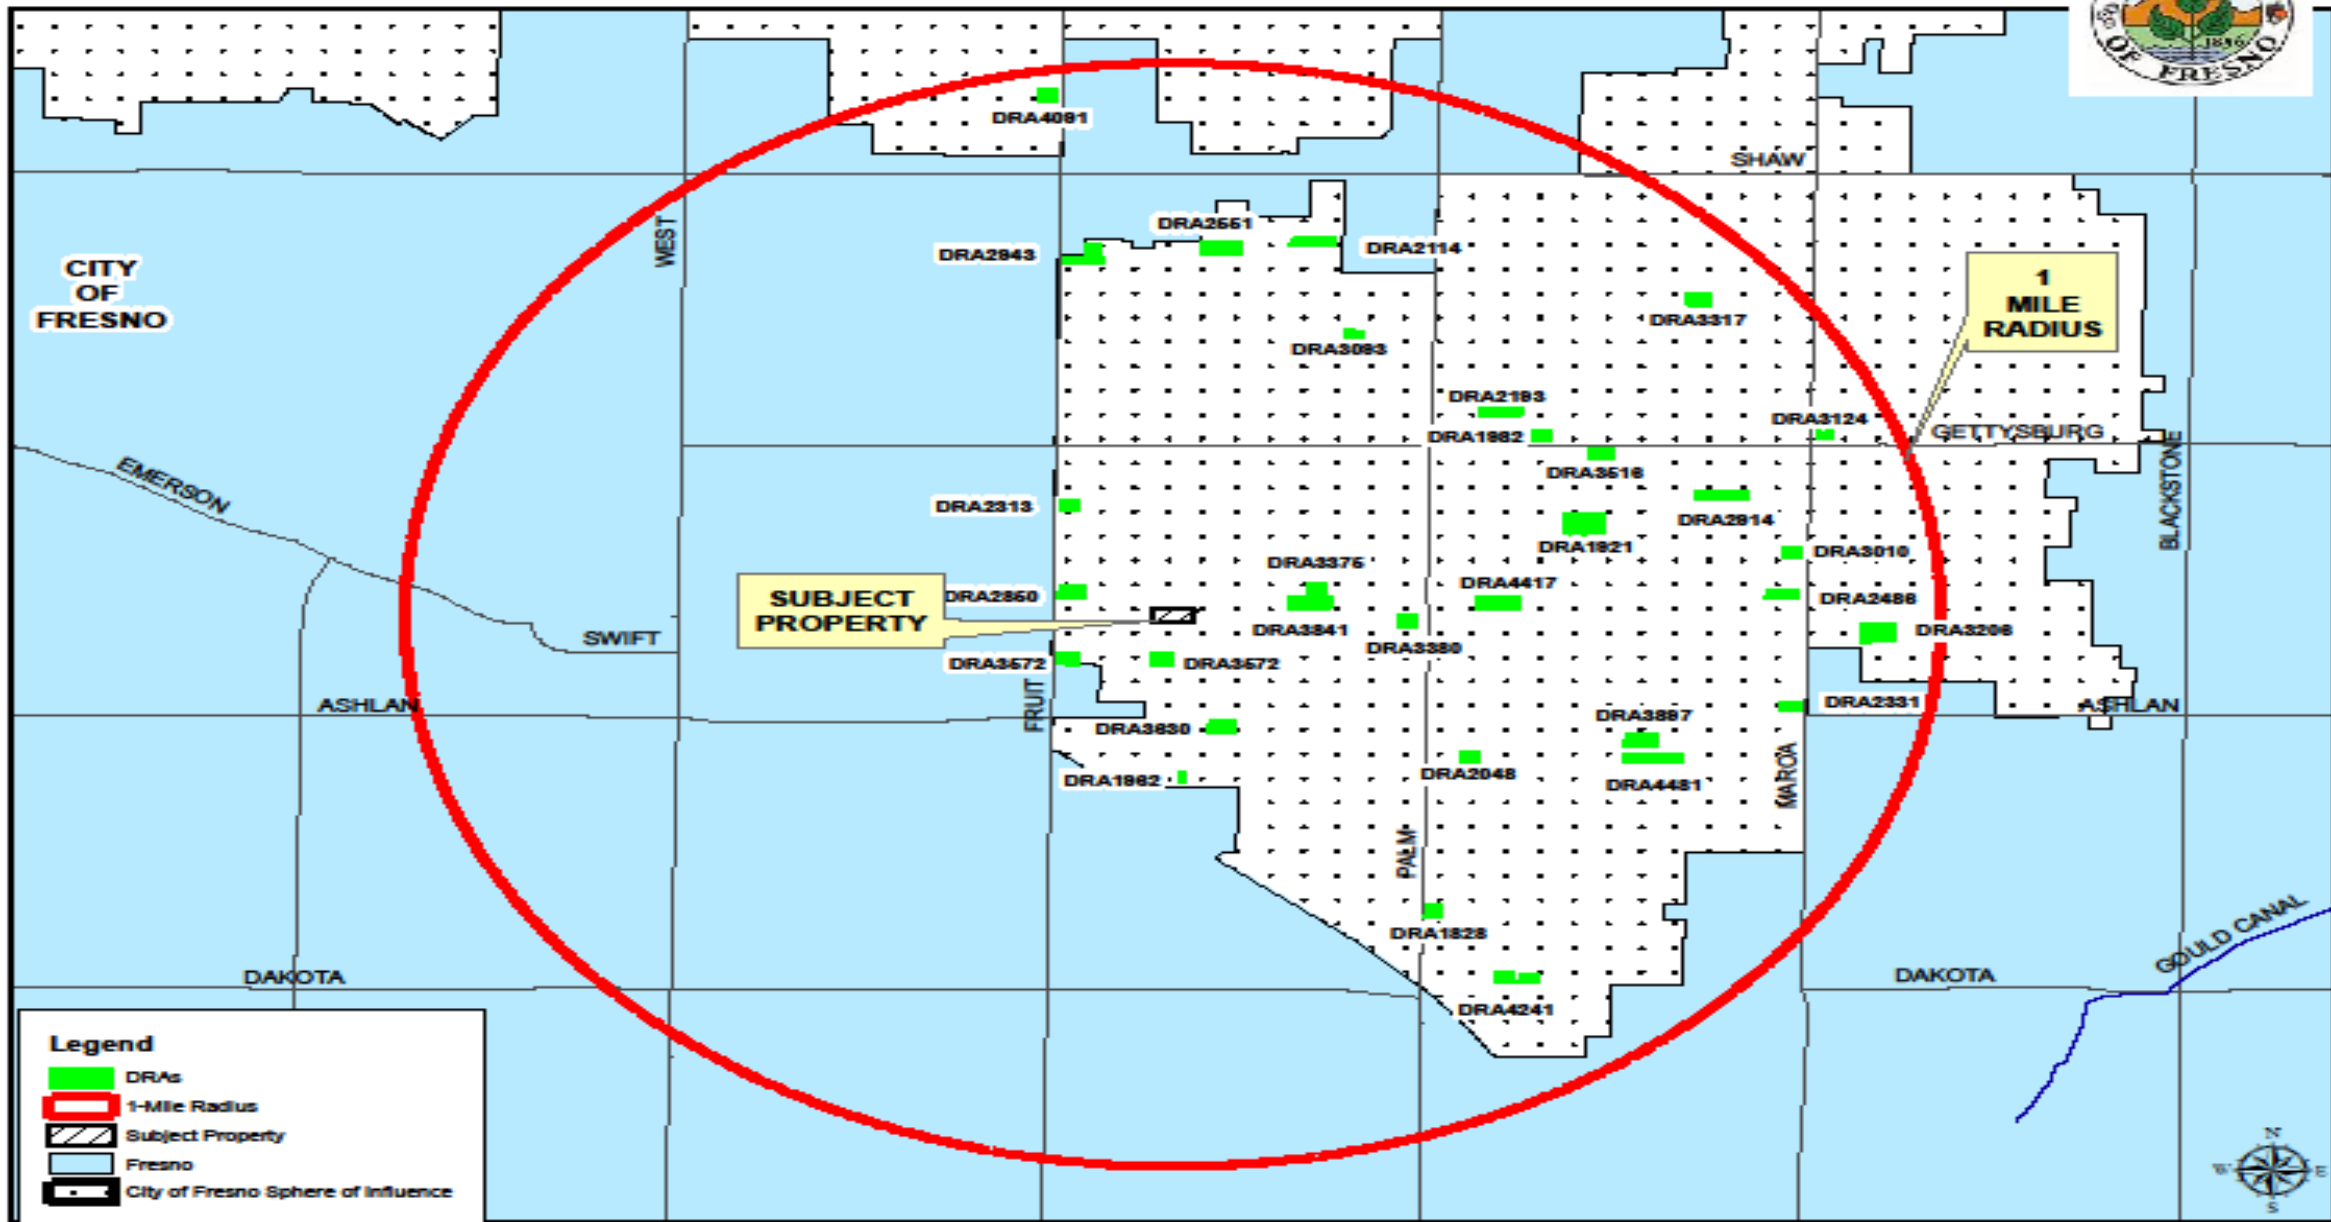

**Legend**

- DRAs
- 1-Mile Radius
- Subject Property
- Fresno
- City of Fresno Sphere of Influence

